



BRADY
THE CITY OF
TEXAS

**CITY OF BRADY COUNCIL AGENDA
REGULAR CITY COUNCIL MEETING
FEBRUARY 3, 2026, 6:00 P.M.**

NOTICE is hereby given of a meeting of the City Council of City of Brady, McCulloch County, State of Texas, to be held at **6:00 p.m. February 3, 2026**, at the City of Brady Municipal Court Building located at 207 S. Elm St., Brady, Texas, for the purpose of considering the following items. The City Council of the City of Brady, Texas, reserves the right to meet in closed session on any of the items listed below should the need arise and if applicable pursuant to authorization by Title 5, Chapter 551, of the Texas Government Code.

Tony Groves,
Mayor

Terry Phillips
Mayor Pro Tem
Council Member Place 1

Vacant
Council Member Place 2

Curtis Owens
Council Member Place 3

Vickie Roddie
Council Member Place 4

Gabe Moreno
Council Member Place 5

James Stewart
City Manager

Tina Keys
City Secretary

Sharon Hicks
City Attorney

1. CALL TO ORDER, ROLL CALL & CERTIFICATION OF A QUORUM

2. INVOCATION AND PLEDGE OF ALLEGIANCE

3. PUBLIC COMMENTS: Reserved for items NOT listed on the agenda

Please limit individual public comments to three (3) minutes. In accordance with TXAG opinion, any public comment addressing items not on the agenda, will only be heard by the City Council. No formal action, deliberation, discussion, or comment will be made by City Council. State Law prohibits any deliberation or decisions regarding items presented in public comments. City Council may only make a statement of specific factual information given in response to the inquiry; recite an existing policy; or request staff to place the item on an agenda for a subsequent meeting.

4. CONSENT AGENDA: Reserved for routine items to save time

Any item may be removed from the Consent Agenda at the request of a Council Member and considered separately following the Consent Agenda approval. All items listed on the Consent Agenda are to be with one motion "Move to approve Consent Agenda."

A. Approval of Minutes for Regular Session meeting on January 20, 2026

5. PRESENTATIONS:

➤ PPM Annual Report – Karl Friederich

6. PUBLIC HEARINGS:

None

In the very Heart of Texas, the City of Brady is dedicated to fostering a tight-knit community rooted in tradition, resilience, and rural pride. We strive to provide a welcoming, safe, and thriving environment where families flourish, local businesses prosper, and the spirit of the Lone Star State shines through our commitment to sustainable growth, preserving our heritage, and embracing the values of hard work, faith, and neighborly support.

7. INDIVIDUAL CONCERNS:

City Council Members are to deliberate the following items. Staff will present the item and are prepared to answer City Council Member questions. The Mayor will recognize Council Members as the council discuss the item so everyone is heard. Once the City Council Members finish discussion, the Mayor will recognize attendees who have comments. Attendees and council members need to direct comments to the Mayor as they are recognized. When all comments are complete, the Mayor will call for a motion.

- A. Discussion, consideration and possible action regarding the **second and final reading of Ordinance 1406** of the City of Brady, Texas, to amend FY 2026 Budget for municipal purposes.
- B. Discussion, consideration, and possible action regarding the **second and final reading of Ordinance 1407** of the City of Brady, Texas approving request for a SUP (Specific Use Provision) for Entertainment use in the Central Business District for property located at 212 N. Church Street, Fulcher Subdivision, Block 11, Lot 13 (P&Z action 01/13/2026)
- C. Discussion, consideration and possible action on selecting a firm for development and concept design of fire department building.

8. STAFF REPORTS:

A. Upcoming Special Events/Meetings:

February 16	President's Day, City Offices Closed, Altered Trash Schedule – Mon. 2/16 picked up on Tues. 2/17, Tues. 2/17 picked up on Wed. 2/18
February 17	Regular City Council Meeting, 6:00
March 3	Regular City Council Meeting, 6:00
March 17	Regular City Council Meeting, 6:00

9. ANNOUNCEMENTS:

Pursuant to the Texas Government Code § 551.0415, City Council Members and City staff may make reports about items of community interest during a meeting of the governing body without having given notice of the report. Items of community interest include: Expressions of thanks, congratulations, or condolence; an honorary or salutary recognition of a public official, public employee, or other citizen, except that a discussion regarding a change in the status of a person's public office or public employment is not an honorary or salutary recognition for purposes of this subdivision; Information regarding a social, ceremonial, or community event organized or sponsored by an entity other than the governing body that was attended or is scheduled to be attended by a member of the governing body or an official or employee of the municipality; and announcements involving an imminent threat to public health and safety of people in the municipality that has arisen after the posting of the agenda.

10. COMMENTS ON FUTURE ITEMS FOR CONSIDERATION:

11. EXECUTIVE SESSION:

The City Council of the City of Brady will adjourn into Executive Session for the following:

- Pursuant to Section 551.071 (Consultation with Attorney), the City Council will consult with the City Attorney about pending or contemplated litigation or on a matter in which the duty of the attorney to the City under the Texas Disciplinary Rules of Professional Conduct of the State Bar of Texas clearly conflicts with the Texas Open Meetings Act: Discussion regarding continued joint participation with County of communication/radio tower
- Pursuant to Section 551.074 (Personnel Matters) City Council will meet to deliberate the appointment, employment, evaluation, reassignment, duties, discipline or dismissal of a public officer or employee: City Manager duties & recommendations
- Pursuant to Section 551.072 (Deliberations about Real Property), the City Council will deliberate the purchase, exchange, lease, or value of real properties of the City as the deliberation in an open meeting will have the detrimental effect on the position of the City in negotiations with a third person: Fire Station

12. OPEN SESSION ACTION ON ANY ITEMS COMING OUT OF EXECUTIVE SESSION:

Discussion, consideration or possible action as a result of Executive Session, if any

13. ADJOURNMENT:

I certify that this is a true and correct copy of the City of Brady City Council Meeting Agenda and that this notice as posted on the designated bulletin board at Brady City Hall, 201 E. Main St., Brady, Texas 76825; a place convenient and readily accessible to the public at all times, and said notice was posted on _____ by _____ a.m. / p.m.. and will remain posted continuously for 3 business days prior to the scheduled meeting pursuant to Chapter 551 of the Texas Government Code.

Tina Keys, City Secretary

In compliance with the Americans with Disabilities Act, the City of Brady will provide for reasonable accommodations for persons attending public meetings at City facilities. Requests for accommodation or interpretive services must be received at least 48 hours prior to the meeting. Please contact the City Secretary at 325-597-2152 or tkeys@bradytx.us

Attendance by Other Elected or Appointed Officials: It is anticipated that members of other governmental bodies, and/or city boards, commissions and/or committees may attend the meeting in numbers that may constitute a quorum of the body, board, commission and/or committee. The members of the boards, commissions and/or committees may be permitted to participate in discussion on the same items listed on the agenda, which occur at the meeting, but no action will be taken by such in attendance unless item and action is specifically provided for on an agenda for that body, board, commission or committee subject to the Texas Open Meetings Act.

The City Council of the City of Brady reserves the right to adjourn into Executive Session at any time during the course of this meeting to discuss any of the matters listed on this agenda as authorized by the Texas Government Code Sections 551.071 (Consultation with Attorney), 551.072 (Deliberations regarding Real Property), 551.073 (Deliberations regarding prospective Gifts or Donations), 551.074 (Personnel Matters), 551.076 (Deliberations regarding Security Devices), 551.086 (Deliberate, vote or take final action on competitive matters of the public power utility), and 551.087 (Deliberation regarding Economic Development).

This agenda has been reviewed and approved by the City's legal counsel and the presence of any subject in any Executive Session portion of the agenda constitutes written interpretation of the Texas Government Code Chapter 551 by legal counsel for the governmental body and constitutes an opinion by the attorney that the items discussed therein may be legally discussed in the closed portion of the meeting considering available opinions of a court of record and opinions of the Texas Attorney General known to the attorney. This provision has been added to this agenda with the intent to meet all elements necessary to satisfy Texas Government Code Chapter 551.104(c) and the meeting is conducted by all participants in reliance on this opinion.

STATE OF TEXAS

COUNTY OF McCULLOCH

CITY OF BRADY

The City Council of the City of Brady, Texas met in a Regular Meeting on Tuesday, January 20, 2026 at 6:00 p.m. with Mayor Anthony Groves presiding. Council Members present were Terry Phillips, Curtis Owens, and Vickie Roddie. City staff present were Finance Director Lisa McElrath, Public Works Director Steven Miller, Police Chief Randy Batten, City Attorney Sharon Hicks and City Secretary Tina Keys. Also in attendance were Allison Beard, Charles Hodges, James Griffin, and Charles Bush.

1. CALL TO ORDER, ROLL CALL & CERTIFICATION OF A QUORUM

Mayor Groves called the meeting to order at 6:00 p.m. Council quorum was certified.

2. INVOCATION AND PLEDGE OF ALLEGIANCE

Council Member Phillips gave the invocation, and the Pledge of Allegiance was recited.

3. PUBLIC COMMENTS

There were no public comments

4. CONSENT AGENDA

- A. Approval of Minutes for Regular Session meeting on January 6, 2026.

Council Member Phillips moved to approve the Consent Agenda. Seconded by Council Member Owens. All Council Members voted “aye” and none “nay”. Motion passed with a 3 – 0 vote.

5. PRESENTATIONS:

- First Quarter Financial Report – FY 26– Lisa McElrath presented to Council

6. PUBLIC HEARINGS AND INDIVIDUAL CONCERNS ON PUBLIC HEARING

- Public Hearing to receive comments from the public regarding a request for SUP (Specific Use Provision) for Entertainment use (Gaming room) in the Central Business District for property located at 212 N. Church St., Fulcher Subdivision, Block 11, Lot 13.

Public Hearing was opened at 6:17 p.m. There were no comments. Public hearing was closed at 6:18 p.m.

7. INDIVIDUAL CONCERNS

- A. Discussion, consideration and possible action approving the purchase of a Case 580SV Backhoe from ASCO, San Angelo, TX in the amount of \$126,550.00. Lisa McElrath presented. Council Member Owens moved to approve the purchase of a Case 580SV Backhoe from ASCO, San Angelo, TX in the amount of \$126,550.00. Seconded by Council Member Phillips. All Council Members voted “aye” and none “nay”. Motion passed with a 3–0 vote.
- B. Discussion, consideration and possible action regarding the first reading of Ordinance 1406 of the City of Brady, Texas, to amend FY 2026 Budget for municipal purposes. Lisa McElrath presented. Council Member Phillips asked how much is in general construction fund. Lisa answered about \$3,500,00. Lisa said that

money can always be transferred elsewhere if necessary. Council Member Owens asked if fund 11 is interest-bearing. Lisa said no. She said it can be should we decide to allow it. She was going to discuss with James and possibly council. It's a discussion we need to have. Do we want that fund to have that interest or the general fund, which is what has been happening. She thought fund 11 is not an operation fund. It was set up to contribute specific dollars to specific events. Until we have a specific game plan on construction and cost, we have posted all interest earned on the Fund 11 money to the General Fund 10 to be utilized for general Government operations. Council Member Ownes said he thought we could generate some interest. Lisa said it is generating interest. The money in fund 11 generates interest but the credit for the interest is not going to this fund, rather, fund 10. Council Member Phillips moved to approve the first reading of Ordinance 1406 with Exhibit A attached. Second, by Council Member Roddie. All Council Members voted "aye" and none "nay". Motion passed with a 3 – 0 vote.

- C. Discussion, consideration and possible action regarding the first reading of Ordinance 1407 of the City of Brady, Texas approving request for a SUP (Specific Use Provision) for Entertainment use in the Central Business District for property located at 212 N. Church Street, Fulcher Subdivision, Block 11, Lot 13. James Stewart presented and said it was recommended by Planning & Zoning. P & Z didn't want it to set a precedence. Council Member Phillips asked what it is. James said it's a gaming room. Council Member Roddie moved to approve the first reading of Ordinance 1407. Seconded by Council Member Phillips. All Council Members voted "aye" and none "nay". Motion passed with a 3 – 0 vote.
- D. Discussion regarding Brady Youth Sports Foundation (BYSF) and Regional Tournaments. Allison said BYSF has been asked to host a regional tournament for baseball. It's a big thing. It will host 8 – 12 teams to come to Brady. She will have schedules in February with Opening Day the end of March. It is an all-star regional tournament. We would hold the 8U tournament. BYSF is trying to do their part also. There is controversy with other teams wanting to get started, but they are willing to work with them. Council Member Phillips said tournaments do bring in revenue to the city. It's a double elimination so people will be wanting to stay and spend the night. James Stewart said it's a good partnership that we've built. Allison said they appreciate all the work that the city puts into it. Allison said we have really good coaches and volunteers. Council Member Phillips said this meant a lot to Council Member Aaron Garcia so he would like to keep it moving in his memory.
- E. Discussion and update on Fire Department plans. James said it would be discussed in Executive Session

8. STAFF REPORTS

- A. **Monthly Financial / Utility Reports**
- B. **Monthly Activity Reports:** Seniors, Golf, BPD, Fire-EMS Calls, BVFD Expense Report, Animal Control, Airport, Code Enforcement, Municipal Court
- C. **Upcoming Special Events/Meetings:**

January 21	Good New Luncheon
February 3	Regular City Council Meeting, 6:00
February 16	President's Day Holiday, City Offices Closed, Altered Trash Schedule – Mon. 2/16 picked up on Tues. 2/17, Tues. 2/17 picked up on Wed. 2/18
February 17	Regular City Council Meeting, 6:00

9. ANNOUNCEMENTS

There were no announcements

10. COMMENTS ON FUTURE ITEMS FOR CONSIDERATION

There were no comments

11. EXECUTIVE SESSION

The City Council of the City of Brady adjourned into Executive Session for the following:

- Pursuant to Section 551.071 (Consultation with Attorney), the City Council will consult with the City Attorney about pending or contemplated litigation or on a matter in which the duty of the attorney to the City under the Texas Disciplinary Rules of Professional Conduct of the State Bar of Texas clearly conflicts with the Texas Open Meetings Act:
- Pursuant to Section 551.074 (Personnel Matters) City Council will meet to deliberate the appointment, employment, evaluation, reassignment, duties, discipline or dismissal of a public officer or employee: City Manager duties & recommendations
- Pursuant to Section 551.072 (Deliberations about Real Property), the City Council will deliberate the purchase, exchange, lease, or value of real properties of the City as the deliberation in an open meeting will have the detrimental effect on the position of the City in negotiations with a third person: Police Station / Fire Station

Open session recessed at 6:52 p.m. Executive Session was opened at 7:05 p.m. and closed at 8:26 p.m. Regular Session resumed at that time.

12. OPEN SESSION ACTION ON ANY ITEMS COMING OUT OF EXECUTIVE SESSION

Council Member Owens moved to authorize the City Manager to (1) continue to look at two sites for the fire station, including expending funds for asbestos assessments and bring back information and/or proposals to the council as appropriate, and (2) to seek designs from Makers Design and Covington Contractors for previously designed fire stations and new designs to expedite process. Seconded by Council Member Roddie. All Council Members vote “aye” and none “nay”. Motion passed with a 3 – 0 vote.

13. ADJOURNMENT

There being no further business, Council Member Phillips moved to adjourn. Seconded by Council Member Owens. Mayor Groves adjourned the meeting at 8:37 p.m.

Anthony Groves, Mayor

Attest: _____
Tina Keys, City Secretary

City Council
City of Brady, Texas
Agenda Action Form for Ordinance

AGENDA DATE:	2-3-26	AGENDA ITEM	7.A.
AGENDA SUBJECT:	Discussion, consideration and possible action regarding second reading of Ordinance 1406 of the City of Brady, Texas, to amend FY 2026 Budget for municipal purposes.		
PREPARED BY:	Lisa McElrath	Date Submitted:	1-21-26
EXHIBITS:	Ordinance 1406 Exhibit A - Amendment Summary*		
BUDGETARY IMPACT:	Required Expenditure:	\$*	
	Amount Budgeted:		
	Appropriation Required:	\$*	
CITY MANAGER APPROVAL:			

SUMMARY:

The City closed on the Council approved sale of the Gas System on October 1, 2025. Now that all transactions have been executed, staff is requesting to reassign budget commitments to other funds and formalize direction on where to transfer the remaining unrestricted Gas Division funds.

Budget commitments for the administrative assistant and property/liability insurance must be transferred to other funds taking over ownership of these expenses. The administrative assistant is now 100% under the Finance Department. Most of the vehicles and heavy equipment owned by the Gas System stayed with the City. Therefore, funds 10(General),20(Electric),30(Water/Sewer) and 60(Solid Waste) will absorb the associated insurance expenditure. Inventory in the amount of \$39,056.34 was purchased from Fund 50 (Utility Support) where the Gas system's inventory is owned until used. (These items were purchased in turn by WTG.) Therefore, staff is requesting to reallocate \$40,000 of budgeted Transfer expense to Fund 50 (40-5-42-910.50) General expense (40-5-42-312.00), reducing the Transfer to Fund 50 to only \$20,000.

The remaining unrestricted Gas funds of \$2,588,484 are available to distribute/transfer to the General Construction Fund (11) or where the council so desires. Staff is assuming that the focus is to transfer unrestricted cash to the General Construction fund to support the cost of future Fire/EMS and Police facilities.

Included with the current amendment is a request to add one new expenditure. After the FY 26 budget process was completed, staff had an opportunity to apply for a 100% grant from the CVCOG (Concho Valley Council of Governments) to obtain a cardboard recycling baler for the Solid Wasted Division in the amount of \$18,000. Staff anticipates that possible award of the grant will be announced this spring. Staff is requesting that the potential transaction be approved in the City's FY 26 budget cycle so that if awarded, staff may immediately purchase the baler. (If the award is denied, the budget funds will not be spent since the approved revenue source did not materialize.)

Exhibit A provides a recap of amending items for Council review and approval.

RECOMMENDED ACTION:

Mayor will ask: “Madam City Secretary please read the Ordinance Preamble for the record in accordance with the City Charter.” “Secretary reads preamble”

Mayor calls for a motion:

Move to approve the **second and final** reading of **Ordinance 1406** with Exhibit A attached.

ORDINANCE NO. 1406

**AN ORDINANCE OF THE CITY OF BRADY, TEXAS AMENDING THE FISCAL
YEAR 2025-2026 BUDGET FOR MUNICIPAL PURPOSES:**

An ordinance amending the 2025-2026 Fiscal Year Budget for municipal purposes as follows:

- Transferring ownership of unrestricted funds from the sale of the Gas Distribution System totaling \$2,588,484 to the General Construction fund and reassigning budget commitments to other municipal funds.
- Allocating \$18,000 for the purchase of a recycling baler should the city be awarded grant funds.

All items by Fund and Division are detailed by Exhibit A, attached.

**NOW, THEREFORE BE IT ORDAINED BY THE CITY COUNCIL OF THE CITY OF
BRADY TEXAS** that the FY 2025-2026 budget be amended accordingly.

APPROVED UPON FIRST READING THIS THE 20th DAY OF January 2026,

**APPROVED AND PASSED UPON SECOND READING THIS THE 3rd DAY OF
February 2026.**

Anthony Groves, Mayor

ATTEST: _____
Tina Keys, City Secretary

CITY OF BRADY
Ordinance 1406 - EXHIBIT A
Budget - FY 26 Amendment Summary
1-20-2026 First reading

REVENUES
EXPENDITURES

<u>REQUEST</u>	<u>AMOUNT</u> INC/(DEC)	<u>BUDGET NUMBER</u>	<u>BUDGET DESCRIPTION</u>	<u>AMENDED BUDGET</u>
GENERAL FUND -10				
Transfer in Gas funds for expenditure commitments	\$ 26,200	10-4-01-910.40	Transfers in from Gas Fund	\$ 26,200
Payroll commitment - Administrative Assistant	\$ 15,000	10-5-44-101.00	Payroll	\$ 297,009
Insurance commitment	\$ 5,000	10-5-44-110.00	Hospital Insurance	\$ 54,680
TMRS commitment	\$ 1,400	10-5-44-111.00	Retirement	\$ 28,116
Payroll tax commitment	\$ 1,200	10-5-44-114.00	Payroll tax	\$ 23,228
Insurance commitment	\$ 3,600	10-5-01-204.00	Property Liability Insurance	\$ 52,100
	<hr/> \$ 26,200			
Fund Balance change:	<hr/> \$ -			
<hr/> GENERAL CONSTRUCTION FUND - 11				
Assign ownership of unrestricted funds	\$ 2,588,484	11-4-28-910.40	Transfers in from Gas Fund	\$ 2,588,484
<hr/> ELECTRIC FUND - 20				
Transfer in Gas funds for expenditure commitments	\$ 15,700	20-4-22-910.40	Transfers in from Gas Fund	\$ 15,700
Insurance commitment	\$ 15,700	20-5-22-204.00	Property Liability Insurance	\$ 37,450
Fund Balance change:	<hr/> \$ -			
<hr/> WATER / SEWER FUND - 30				
Transfer in Gas funds for expenditure commitments	\$ 6,800	30-4-31-910.40	Transfers in from Gas Fund	\$ 6,800
Transfer in Gas funds for expenditure commitments	\$ 6,800	30-4-23-910.40	Transfers in from Gas Fund	\$ 6,800
	<hr/> \$ 13,600			
Insurance commitment	\$ 6,800	30-5-31-204.00	Property Liability Insurance	\$ 24,700
	\$ 6,800	30-5-23-204.00	Property Liability Insurance	\$ 26,000
	<hr/> \$ 13,600			
Fund Balance change:	<hr/> \$ -			
<hr/> SOLID WASTE - 60				
Transfer in Gas funds for expenditure commitments	\$ 13,600	60-4-14-910.40	Transfers in from Gas Fund	\$ 13,600
Grant funding from CVGOG - recycling baler	\$ 18,000	60-4-14-813.00	CVGOG Grant	\$ 18,000
Insurance commitment	\$ 13,600	60-5-14-204.00	Property Liability Insurance	\$ 30,650
Purchase a recycling baler	\$ 18,000	60-5-14-402.00	Capital Equipment	\$ 18,000

Fund Balance change: \$ -

CITY OF BRADY
Ordinance 1406 - EXHIBIT A
Budget - FY 26 Amendment Summary
1-20-2026 First reading

REVENUES
EXPENDITURES

<u>REQUEST</u>	<u>AMOUNT</u> INC/(DEC)	<u>BUDGET NUMBER</u>	<u>BUDGET DESCRIPTION</u>	<u>AMENDED BUDGET</u>
GAS - 40				
Reassign payroll to Finance - Admin Assistant	\$ (15,000)	40-5-42-101.00	Payroll	\$ -
	\$ (5,000)	40-5-42-110.00	Hospital Insurance	\$ -
	\$ (1,400)	40-5-42-111.00	Retirement	\$ -
	\$ (1,200)	40-5-42-114.00	Payroll taxes	\$ -
Transfer funds to support budget commitments	\$ 22,600	40-5-42-910.10	Transfers out to F10	\$ 22,600
Reassign expenditure to funds 10,20,30,60	\$ (46,500)	40-5-42-204.00	Property Liability Insurance	\$ -
Transfer funds to support budget commitments	\$ 3,600	40-5-42-910.10	Transfers out to F10	\$ 26,200
	\$ 15,700	40-5-42-910.20	Transfers out to F20	\$ 15,700
	\$ 13,600	40-5-42-910.30	Transfers out to F30	\$ 13,600
	\$ 13,600	40-5-42-910.60	Transfers out to F60	\$ 13,600
Purchase inventory from Fund 50 (sold to WTG)	\$ 40,000	40-5-42-312.00	General	\$ 40,000
Budgeted transfer-out not needed	\$ (40,000)	40-5-42-910.50	Transfers out to Fund 50	\$ 20,000
Fund Balance change:	\$ -			
Transfer remaining fund balance to Fund 11	\$ 2,588,484	40-5-42-910.11	Transfers out to Fund 11	\$ 2,588,484

**CITY COUNCIL
CITY OF BRADY, TEXAS
AGENDA ACTION FORM for ORDINANCE**

AGENDA DATE:	02/03/2626	AGENDA ITEM	7.B.
AGENDA SUBJECT: Discussion, consideration, and possible action regarding the second and final reading of Ordinance 1407 of the City of Brady, Texas approving request for a SUP (Specific Use Provision) for Entertainment use in the Central Business District for property located at 212 N. Church Street, Fulcher Subdivision, Block 11, Lot 13 (P&Z action 01/13/2026)			
PREPARED BY: Tina Keys		Date Submitted:	01/12/2026
EXHIBITS: Ordinance 1407			
BUDGETARY IMPACT:		Required Expenditure:	\$00.00
		Amount Budgeted:	\$00.00
		Appropriation Required:	\$00.00
CITY MANAGER APPROVAL:			
SUMMARY: Mr. Jonathan Bradford contacted the code office requesting a Specific Use Provision for Entertainment use for property located at 212 N. Church Street. This property is currently zoned as Central Business District. The property to the East, North, and West is zoned Commercial. The property to the South is Central Business District. The zoning application was filed on October 16, 2025. The City published proper notice for property located at 212 N. Church Street, Fulcher Subdivision, Block 11, Lot 13, Brady, Texas, for the purpose to request a Specific Use Provision and gave proper notice to all property owners within 200 feet.			
RECOMMENDED ACTION: Mayor will ask: <u>“Madam City Secretary please read the Ordinance Preamble for the record in accordance with the City Charter.”</u> “Secretary reads preamble” Mayor calls for a motion: Move to approve the second and final reading of Ordinance 1407			

ORDINANCE NO. 1407

AN ORDINANCE OF THE CITY OF BRADY, TEXAS, APPROVING THE REQUEST FOR A SPECIFIC USE PROVISION FOR ENTERTAINMENT USE IN THE CENTRAL BUSINESS DISTRICT FOR PROPERTY LOCATED AT 212 N. CHURCH STREET, FULCHER SUBDIVISION, BLOCK 11, LOT 13.

WHEREAS, Chapter 211 of the Texas Local Government Code empowers the City of Brady, Texas to enact zoning regulations and provide for their administration, enforcement and amendment; and

WHEREAS, the City has previously deemed it necessary and desirable to adopt zoning regulations to provide for the orderly development of property within the City in order to promote the public health, safety, morals and general welfare of the residents of the City, and

WHEREAS, Chapter 14 of the Brady Code of Ordinances constitutes the City's Zoning Regulations and requires property to be zoned in accordance with proper designations as defined by the City; and

WHEREAS, Jonathan Bradford has requested a Specific Use Provision, and

WHEREAS, the Planning and Zoning Commission of the City provided adequate notice and held a public hearing on January 13, 2026 in accordance with the Brady Code of Ordinances and Chapter 211 of the Texas Local Government Code; and

WHEREAS, the Planning and Zoning Commission of the City recommended approval of the Specific Use Provision of the designated property and confirmed that the Specific Use Provision is uniform and conforms to the plan design of the City's Zoning regulations; and

WHEREAS, the City Council believes the Specific Use Provision will not adversely affect the character of the area in which it is proposed; will not substantially depreciate the value of adjacent or nearby properties; will be in keeping with the spirit and intent of the City's Zoning Ordinance; will comply with applicable standards of the district in which located; and will not adversely affect traffic, public health, public utilities, public safety and the general welfare of the residents of the City;

NOW, THEREFORE, BE IT ORDAINED BY THE CITY COUNCIL OF THE CITY OF BRADY, TEXAS, THAT:

A Specific Use Provision is granted for Entertainment use for property located at 212 N. Church St. in the Fulcher Subdivision, Block 11, Lot 13.

PASSED AND APPROVED on its First Reading on this the _____ day of _____ 2026.

PASSED AND APPROVED on its Second reading this the _____ day of _____ 2026.

Anthony Groves, Mayor

ATTEST:

Tina Keys, City Secretary

City Council

City of Brady, Texas

Agenda Action Form

AGENDA DATE:	2/3/2026	AGENDA ITEM	7.C.
AGENDA SUBJECT:	Discussion, consideration and possible action on selecting a firm for development and design of fire department building.		
PREPARED BY:	J. Stewart	Date Submitted:	1/25/2026
EXHIBITS:			
BUDGETARY IMPACT:	Required Expenditure:	\$10,000.00	
	Amount Budgeted:	\$00.00	
	Appropriation Required:	\$10,000.00	
CITY MANAGER APPROVAL:			
SUMMARY: The city has been using an architect firm for the development of several construction projects including the animal control facility and the city hall renovation. The city is ready to proceed with concept development and design that will ultimately provide the professional plans that will become our new fire and EMS station.			

RECOMMENDED ACTION:
Approve selection of a firm to proceed with plan development.



STATEMENT OF QUALIFICATIONS
FOR

CITY OF BRADY
**ARCHITECTURAL SERVICES
FOR FIRE STATION**

JANUARY 27, 2026



SUBMITTED BY

MAKERS DESIGN

MDCO

COLLABORATIVE

Contact:
Briana K. Brandt, AIA, RID
512-964-8869
briana@makersdesignco.com

January 22, 2026

James Stewart
 City Manager
 City of Brady City Hall
 201 E. Main St.
 P.O. Box 351
 Brady, Texas 76825

Dear City of Brady Council Members,

We are pleased to submit our Statement of Qualifications for architectural services related to the City of Brady's new Fire Station project. This project represents a critical investment in public safety and community resilience, and it aligns directly with the experience, approach, and values of Makers Design Co.

Our firm specializes in the design, renovation, and expansion of public-sector facilities across Texas, including fire stations, municipal buildings, and other essential infrastructure. Makers Design Co. has completed more than 75 public projects statewide, and **our project team has experience planning and designing more than 50 fire stations throughout Texas—ranging from small, volunteer-based departments to larger, full-service facilities.** This depth of experience allows us to deliver solutions that are right-sized, operationally efficient, and responsive to both departmental needs and community context.

Makers Design Co. brings a principal-led, hands-on approach to every project. Clients work directly with firm owners Nathan Brandt, AIA, RID, CSI, NCARB, and Briana Brandt, AIA, RID, ensuring consistent communication, responsiveness, and accountability throughout all phases of the work. Our architectural team is supported by a trusted group of engineering consultants with whom we have successfully delivered multiple public-sector projects, including fire stations and other essential facilities.

Our proposed project team includes Dudley Engineering as Structural Engineer, DBR as Mechanical, Electrical, and Plumbing Engineer, and Kimley-Horn and Associates as Civil Engineer. Makers Design Co. has extensive experience collaborating with each of these firms on public projects across Texas, and we are confident in the team's ability to deliver a well-coordinated, durable, and cost-effective facility for the City of Brady. As the project progresses, additional specialty consultants will be selected as needed to support specific project requirements, in close coordination with the City.

We are already familiar with the City of Brady's processes, priorities, and expectations, having previously worked with the City on the City Hall Renovation and Animal Control Facility projects. This established working relationship allows our team to move efficiently, collaborate effectively with City staff, and build upon an understanding of local goals, constraints, and standards.

Our approach emphasizes early collaboration with City leadership and fire department staff to confirm operational needs, staffing models, apparatus requirements, site constraints, and long-term maintenance considerations. We place a strong emphasis on clear, coordinated, and buildable construction documents—reducing RFIs, minimizing change orders, and supporting a smooth construction process.

We believe Makers Design Co. is well suited to support the City of Brady based on the following qualifications:

- Direct experience working with the City of Brady on municipal projects
- Project Team experience on more than 50 fire stations across Texas
- Established consultant team with proven experience delivering public safety facilities
- Strong understanding of small-community and volunteer-based department needs
- Proven ability to deliver cost-effective, right-sized municipal facilities
- Expertise in site development, drainage, and utility coordination
- Principal-led project delivery focused on efficiency, clarity, and accountability

We appreciate the opportunity to be considered for this important project and would be honored to continue our partnership with the City of Brady. This is a short-form Statement of Qualifications, and we would welcome the opportunity to provide additional detail regarding our fire station experience, feasibility studies, or similar municipal projects.

Best,



Nathan Brandt, AIA, RID, CSI, NCARB
 Founding Principal
 Direct: 979-739-3709
 nathan@makersdesignco.com



Briana K. Brandt, AIA, RID
 Founding Principal
 Direct: 512-964-8869
 briana@makersdesignco.com



NATHAN BRANDT AIA, RID, CSI, NCARB

Project Manager, QA/QC



Nathan Brandt is a registered Architect and Interior Designer in the state of Texas with over 13 years of experience. He oversees all aspects of design coordination, working closely with clients, consultants, and contractors to ensure projects stay on track and on budget. Nathan brings a decade of experience assembling comprehensive project manuals, ensuring that documentation is clear, consistent, and aligned with constructability and performance goals. He is a proactive leader who excels at managing large, multidisciplinary teams and is committed to providing transparency and accountability at every stage. Nathan fosters a highly collaborative process—working closely with construction teams to integrate real-time value engineering throughout design. His depth of experience across public-sector projects makes him a reliable and strategic partner from project kickoff through closeout.

CREDENTIALS

Registered Architect, TX
#26840

Registered Interior Designer, TX
#12185

EDUCATION

Master of Architecture
Certificate in Health Systems & Design
Texas A&M University
Bachelor of Environmental Design
Minor in Business Administration
Texas A&M University

EXPERIENCE

Architecture - 13.5 Years
Specifications Writer - 10 Years
Interior Design - 8 Years

FIRE STATION EXPERIENCE

*Hearne Public Safety Building | Hearne, Texas
Fire Station No. 1 Assessment & Renovation | Rosenberg, TX
*Harris County ESD 20 Fire Station No. 44 | Houston, TX
Fire Station No. 1 & EMS | Clute, TX
Simonton Fire Station No. 1 | Fulshear, TX
Fire Station No. 6 | Georgetown, TX
Fire Station No. 7 | Georgetown, TX
*Fire Station No. 3 & Training Facility | Klein, TX
Fire Station No. 8 | Klein, TX
Fire Station, Administration Maintenance, Training Master Plan | Klein, TX
Fire Station No. 1 | Pearland, TX
Fire Station No. 2 | Pearland, TX
Fire Station No. 3 | Pearland, TX
Fire Station No. 2 | Richmond, TX
Fire Station No. 3 | Schertz, TX
Fire Station No. 74 | Spring, TX
Fire Station No. 75 | Spring, TX
Fire Station No. 21 | Aldine, TX
Onion Creek Fire Station No. 1 | Austin, TX
Klein Maintenance Facility | Klein, TX



BRIANA K. BRANDT AIA, RID

Project Architect, Interiors Coordinator



Briana K. Brandt is a registered Architect and Interior Designer in the state of Texas. With 12 years of experience, Briana approaches each project with creativity, efficiency, strong analytical skills, and enthusiasm. Her detail-oriented mindset paired with strong problem-solving skills and technical expertise allow her to develop clear, buildable solutions that align with client needs. Briana has worked on a wide range of projects, including Public, Commercial, Higher Education, Hospitality, K-12, Healthcare, and Residential, guiding them from early design through construction. She is committed to fostering strong client relationships and a collaborative team approach, ensuring that each project is tailored to the unique goals of the owner and end-users. Her focus is always on delivering high-quality, well-coordinated designs that make sense both aesthetically and practically.

CREDENTIALS

Registered Architect, TX
#27338

Registered Interior Designer, TX
#12184


EXPERIENCE

Architecture - 12.5 Years
Interior Design - 8 Years

MAKERS DESIGN CO.

FIRE STATION & PUBLIC PROJECT EXPERIENCE

*Hearne Public Safety Building | Hearne, Texas
Fire Station No. 1 Assessment & Renovation | Rosenberg, TX
*Harris County ESD 20 Fire Station No. 44 | Houston, TX
Brady City Hall Renovation - Phase 1 | Brady, TX
Brady Animal Control Facility | Brady, TX
Brazoria County Courthouse Expansion & Improvements | Angleton, TX
Seabourne Creek Park Nature Center | Rosenberg, TX
Oscar Johnson Jr. Community Center | Conroe, TX

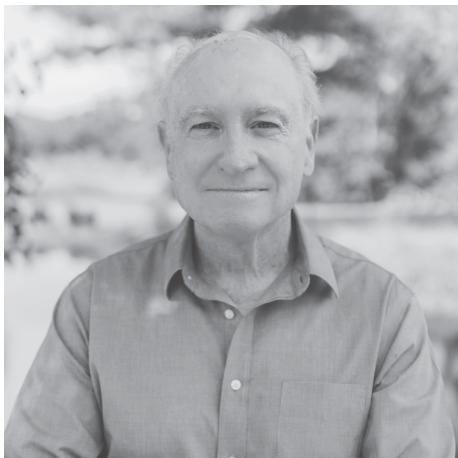

RICK ROBERTSON PE

Advising Principal



Rick has been practicing in Texas for over 40 years, developing strong relationships with architects around the state and building a portfolio of projects ranging from complex auto dealerships to local civic and recreational facilities. Sharing his wealth of knowledge with the next generation of the design community, Rick is known as a mentor to engineers in his firm and has served as a Professor of Practice in Texas A&M's Architecture Department.

CREDENTIALS

Professional Engineer, TX
No. 123798

EDUCATION

Doctor of Engineering
Texas A&M University

Masters of Engineering
Civil Engineering
Texas A&M University

Bachelors in Civil Engineering
Texas A&M University

EXPERIENCE

Structural Engineer - over 40 Years

FIRE STATION EXPERIENCE

Hearne Public Safety Building | Hearne, TX
Fire Station No. 1 Assessment & Renovation | Rosenberg, TX
Harris County ESD 21 Rosenhill Fire Station No. 3 | Cypress, TX
Bexar Co. District 2 Fire Station No. 124 | San Antonio, TX
Montgomery County ESD No. 3 Fire Training Facility | Montgomery, TX
Comal County Fire Station No. 54 | New Braunfels, TX
College Station Fire and EMS No. 6 | College Station, TX
Waco Fire Station and EMS No. 3 | Waco, TX
Harris County ESD 21 Fire Station No. 3 | Hockley, TX
Comal County Fire Station No. 56 | New Braunfels, TX
Bexar Co. District 2 Fire Station No. 125 | San Antonio, TX
Brayton Fire Training School – Marine Training Expansion
| College Station, TX
Brayton Fire Training School – New Chemical Fire
Complex | College Station, TX
Brayton Fire Training School | College Station, TX



DREW DUDLEY PE, SE

Principal in Charge



Since founding the firm in 2017, Drew has expanded the team to over twenty engineers. He continues to wear many hats while running and growing the business, although his most cherished role is teaching and mentoring his employees. Teaching is a persistent theme in his life, as he also works as a Professor of Practice at Texas A&M University's Department of Construction Science and Department of Architecture. Drew has earned several recognitions and awards in the engineering community in the past several years including most recently being named the National Society of Professional Engineers' "Young Engineer of the Year" for the State of Texas in 2020.

CREDENTIALS

Professional Engineer, TX
No. 123798

EXPERIENCE

Structural Engineer - 13 Years
Professor - 12 Years

FIRE STATION EXPERIENCE

*Hearne Public Safety Building | Hearne, TX
Fire Station No. 1 Assessment & Renovation | Rosenberg, TX
Harris County ESD 21 Rosenhill Fire Station No. 3 | Cypress, TX
Bexar Co. District 2 Fire Station No. 124 | San Antonio, TX
Montgomery County ESD No. 3 Fire Training Facility | Montgomery, TX
Comal County Fire Station No. 54 | New Braunfels, TX
College Station Fire and EMS No. 6 | College Station, TX
Comal County Fire Station No. 56 | New Braunfels, TX


EDWARD PUENTES PE, CEM, LEED Green Assoc.

Partner-in-Charge



Edward is responsible for managing projects across Texas. He oversees the design of mechanical, electrical, and plumbing work, making sure that the needs of our clients are met. Edward is also responsible for maintaining design standards and providing quality control.

CREDENTIALS

Professional Engineer, TX
No. 102338

Certified Energy Manager

EDUCATION

Bachelor of Science
Mechanical Engineering
University of Texas-Pan American

EXPERIENCE

MEP Engineer - 28 Years

FIRE STATION EXPERIENCE

Georgetown Fire Station No. 1 Addition/Renovation | Georgetown, TX
Midland Fire Station No. 5 | Midland, TX

Midland Fire Station No. 11 | Midland, TX

City of Horseshoe Bay City Hall | Horseshoe Bay, TX

City of McAllen City Hall Addition & Renovation | McAllen, TX

City of Pearsall City Hall Annex Building | Pearsall, TX

City of New Braunfels Public Works Mun. Serv. Cntr. | New Braunfels, TX

City of McAllen Public Works Admin. Office Renovation | McAllen, TX

City of McAllen Public Utility Office Addition & Renovation | McAllen, TX

City of Kingsville Municipal Building Renovation | Kingsville, TX

City of Eagle Pass Public Works Facility | Eagle Pass, TX

City of El Paso Police Dept. Eastside Reg. Command Cntr. | El Paso, TX

Travis County West Service Center | Austin, TX

Brooks County Dept. of Public Safety Facility Renovation | Falfurrias, TX

El Paso County Vinton Maintenance Facility | El Paso, TX


ANNIE BRISCOE PE

Project Manager



Annie has more than six years of project experience with Kimley-Horn, serving both public and private clients throughout Texas. She specializes in the design of municipal site plans, associated water and sewer infrastructure, detention, and drainage plans. She has ample experience with municipal projects, performing civil engineering design for parking lots, roadways, and associated infrastructure. Annie takes pride in her ability to follow projects from inception through completion and takes an active role in construction phase services. Annie has worked on more than 50 municipal-related projects across Texas. Her breadth of knowledge on the processes and procedures to get these unique types of projects completed, makes her an invaluable asset to the assembled project team.

CREDENTIALS

Professional Engineer, TX
No. 144104

EXPERIENCE

Civil Engineer - 10 Years

FIRE STATION & PUBLIC PROJECT EXPERIENCE

Fire Station No. 1 Assessment & Renovation | Rosenberg, TX

City of College Station Fire Station 7 | College Station TX

Harris County Emergency Service District Station 16 | Klein, TX

City of Waco Fire Station 15 | Waco, TX

City of Marble Falls Fire Station 1 Renovation | Marble Falls, TX

Travis County Emergency Services District 12 Central Station | Manor, TX

City of San Antonio Fire Station 52 Renovation | San Antonio, TX

City of San Antonio Fire Station 53 Renovation | San Antonio, TX

KLEIN FIRE STATION NO. 3 & TRAINING FACILITY

11,000 SF | Klein, TX

**PROJECT DATA****Owner**

Harris County ESD 16

Services Provided

Full Architectural

Budget

\$3.6 million

Completion

2018

Contractor

LDF Construction Inc.



Fire Station Project Type



On-Site Training



Budget-Conscious Design

SCOPE

The Klein Fire Department commissioned the design and construction of Fire Station No. 3 and a companion fire training facility on a shared 7-acre site. The project includes an 11,000 SF fire station paired with a 3,500 SF training facility, providing a **cost-effective solution that maintains operational readiness while keeping firefighters within the district during emergency events.**

A key project objective was maintaining uninterrupted fire service throughout construction. A carefully developed phasing plan allowed the training facility to temporarily function as an active fire station, enabling the existing Fire Station No. 3 to remain operational until the new facility was complete. This approach demonstrates experience in **phased construction planning for essential facilities**, minimizing service disruption—an important consideration for communities with limited response redundancy.

Nathan Brandt served as Project Architect and worked closely with the Client to confirm station programming, budget constraints, and operational goals. His role included **site and building planning, design, engineering coordination, bidding and procurement, and construction administration**, ensuring the project met functional needs while remaining within budget.

The fire station was designed to support a **volunteer-based department staffed for 8 personnel with 3 shift changes**, and includes three pull-through apparatus bays, staff offices, living quarters, PPE storage, fitness room, and associated support spaces. Adjacent site improvements include a covered fueling station for department vehicles and secure storage for training equipment. The training facility provides **flexible indoor and outdoor instructional spaces**, allowing for hands-on training, simulated burn exercises, and post-incident review and debriefing—supporting operational preparedness and ongoing skill development applicable to the City of Brady's fire station and training needs.

HARRIS COUNTY ESD 20 FIRE STATION NO. 44

24,000 SF | Houston, TX

**PROJECT DATA****Owner**

Harris County ESD 20

Services Provided

Full Architectural

Budget

\$7.3 million

Completion

2021

Contractor

Teal Construction Company



Fire Station Project Type



Similar Scope



Budget-Conscious Design

SCOPE

Harris County Emergency Services District No. 20 commissioned the design and construction of a new fire station and training campus to meet the growing operational demands of the district. Nathan Brandt served as Project Manager on the project providing full architectural services for the project, including site planning, building design, and coordination of essential facility requirements. The 9-acre site is organized into three functional zones: Response, Administration, and Training, allowing efficient separation of daily operations, leadership functions, and instructional activities.



Fire Station No. 44 is an approximately 24,000 SF facility designed to support efficient, modern emergency response operations. The station **includes apparatus pull-through bays with four-fold doors to support rapid deployment and return**, along with interior spaces that include sleeping quarters, fitness facilities, kitchen and day room, and operational support spaces—element.

As an essential facility, the fire station incorporates full generator backup and Risk Category IV construction to ensure continuous operation during emergency events. The administrative component provides office space for department leadership, records storage, and future operational flexibility, and includes a conference room designed to function as an incident command and coordination center, **supporting organized response during large-scale or multi-agency emergencies**.

The site also includes maintenance and training support buildings, an instructional pavilion, and provisions for future expansion of training infrastructure, including multi-story training elements for fire, rescue, and high-angle response scenarios. The project demonstrates **experience in designing resilient, adaptable fire stations that balance operational efficiency, long-term flexibility, and budget-conscious planning**, directly applicable to the City of Brady's planned fire station project.

HEARNE PUBLIC SAFETY BUILDING ASSESSMENT & DESIGN

27,000 SF | Hearne, TX

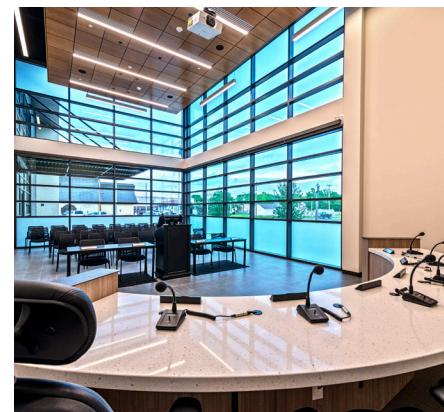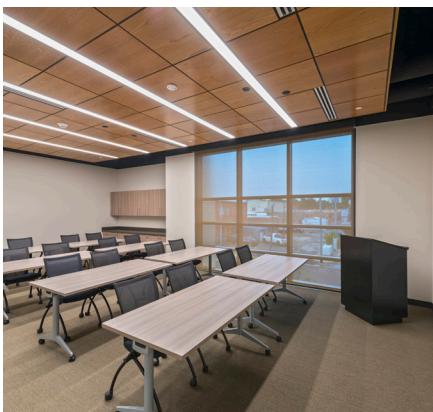**PROJECT DATA****Owner**

City of Hearne

Services Provided

Building Assessment & Architectural, Structural Engineering

Budget

\$7.5 million

Completion

2021

Contractor

Madison Construction



Fire Station Project Type



Comparable Texas Community



Feasibility Assessment Included

SCOPE

Located at the corner of W. 3rd Street and Cedar Street in downtown Hearne, Texas, the Hearne Public Safety Building serves as a consolidated civic facility housing the Fire Department, Police Department, Municipal Courts, Council Chambers, and supporting municipal services.

Prior to design, our team conducted a detailed assessment of the City's existing facilities to identify operational gaps, staffing needs, and long-term growth considerations. **Multiple planning options were developed and evaluated to balance operational functionality with budget constraints.**

The Volunteer Fire Department component was planned to support daily operations, emergency response, and firefighter health and safety. The facility **includes four (4) pull-through apparatus bays (two apparatus deep)** sized for modern fire and EMS vehicles, with **heated bays, floor drains, and integrated air and power drops** to support year-round operations and vehicle maintenance.

Firefighter support spaces include dedicated **bunker gear storage, a gear extractor and decontamination area, restrooms and showers, and air-lock separation between apparatus bays and clean areas**, reinforcing best practices for contaminant control and cancer-prevention measures. A separate watch office allows for operational oversight without interfering with apparatus circulation. The building was also **designed with operational resilience in mind**, incorporating a full-building emergency power system to maintain fire, EMS, and dispatch operations during power outages. A mezzanine level provides additional storage, allowing primary operational spaces to remain efficient and uncluttered.

While the Hearne facility integrates multiple public safety departments, the project demonstrates **our experience planning fire station environments that prioritize apparatus flow, decontamination separation, firefighter support spaces, emergency power resiliency, and long-term adaptability.**

BRAZOS COUNTY ESD 4 FIRE STATION 3

1,910 SF Renovation, 4,800 SF Expansion | Bryan, TX

PROJECT DATA

Owner

Brazos County ESD 4

Services Provided

Structural Engineering

Budget

\$1.2 million

Completion

2025



*Fire Station Project Type
using PEMB as primary structure*



MONTGOMERY COUNTY ESD 1 FIRE STATION NO. 95 LOGISTICS BUILDING

6,010 SF | Willis, TX

PROJECT DATA

Owner

Montgomery County ESD 1

Services Provided

Structural Engineering

Budget

\$2 million

Completion

2022



*Fire Station Project Type
using PEMB as primary structure*



WACO FIRE STATION NO. 3

8,000 SF | Waco, TX

PROJECT DATA

Owner

City of Waco

Services Provided

Structural Engineering

Budget

\$6.8 million

Completion

2012



*Fire Station Project Type
using PEMB as primary structure*



Makers Design Co. (Architecture)

*Hearne Public Safety Building

Location: Hearne, Texas

*Fire Station No. 1 Assessment & Renovation
Location: Rosenberg, Texas

*Harris County ESD 20 Fire Station No. 44
Location: Houston, Texas

Simonton Fire Station No. 1
Location: Fulshear, Texas

Georgetown Fire Station No. 6
Location: Georgetown, Texas

Georgetown Fire Station No. 7
Location: Georgetown, Texas

Klein Fire Station No. 3 & Training Facility
Location: Klein, Texas

Klein Fire Station No. 8
Location: Klein, Texas

Klein Fire Station Masterplan
Location: Klein, Texas

Pearland Fire Station No. 1
Location: Pearland, Texas

Pearland Fire Station No. 2
Location: Pearland, Texas

Pearland Fire Station No. 3
Location: Pearland, Texas

Richmond Fire Station No. 2
Location: Richmond, TX

Schertz Fire Station No. 3
Location: Schertz, Texas

Spring Fire Station No. 74
Location: Spring, Texas

Spring Fire Station No. 75
Location: Spring, Texas

Aldine Fire Station No. 21
Location: Aldine, Texas

Onion Creek Fire Station No. 1
Location: Austin, Texas

Hearne Public Safety Building
Location: Hearne, Texas

Fire Station No. 7 Study
Location: College Station, Texas

Fire Station No. 1 & EMS
Location: Clute, Texas

Dudley Engineering (Structural Engineering)

*Hearne Public Safety Building

Location: Hearne, Texas

Fire Station No. 1 Assessment & Renovation
Location: Rosenberg, Texas

Rosehill Fire Station No. 3 at Harris County ESD 21
Location: Cypress, Texas

*Montgomery County ESD No. 3 Fire Training Facility
Location: Montgomery, Texas

City of College Station Fire Station No. 6
Location: College Station, Texas

Dudley Engineering (Structural Engineering) *Continued.*

Bexar County ESD No. 2 Fire Station No. 124

Location: San Antonio, Texas

*Fire Station No. 1 Assessment & Renovation
Location: Rosenberg, Texas

*Waco Fire Station and EMS No. 3
Location: Waco, TX

Comal County Fire Station No. 56
Location: New Braunfels, TX

Brayton Fire Training School – Marine Training Expansion
Location: College Station, TX

Brayton Fire Training School – New Chemical Fire Comp.
Location: College Station, TX

Brayton Fire Training School
Location: College Station, TX

DBR (MEP Engineering)

City of El Paso Fire Station 36

Location: El Paso, Texas

Harris County ESD 13 Cypress Creek Fire Station 25
Location: Houston, Texas

City of Midland Fire Station 5
Location: Midland, Texas

Williamson County ESD 4 Fire Station 2
Location: Liberty Hill, Texas

Harris County ESD 9 Cy-Fair Fire Department
Location: Cypress, Texas

Crosby Fire Station No. 1 & No. 2
Crosby, Texas

The Woodlands Central Fire Station
The Woodlands, Texas

The Woodlands Fire Station 6
The Woodlands, Texas

Champions Area Volunteer Fire & EMS Station
Houston, Texas

Cypress Creek EMS - Station 9
Cypress, Texas

Kimley-Horn and Associates (Civil Engineering)

Fire Station No. 1 Assessment & Renovation

Location: Rosenberg, Texas

College Station Fire Station 7
Location: College Station, Texas

Harris County Emergency Service District Station 16
Location: Klein, TX

City of Waco Fire Station 15
Location: Waco, TX

City of Marble Falls Fire Station 1 Renovation
Location: Marble Falls, TX

City of San Antonio Fire Station 52 Renovation
Location: San Antonio, TX

City of San Antonio Fire Station 53 Renovation
Location: San Antonio, TX

City of Denton Fire Station 5
Location: Denton, TX

January 22, 2026

James Stewart
 City Manager
 City of Brady City Hall
 201 E. Main St.
 P.O. Box 351
 Brady, Texas 76825

Dear City of Brady Council Members,

We are pleased to submit our Statement of Qualifications for architectural services related to the City of Brady's new Fire Station project. This project represents a critical investment in public safety and community resilience, and it aligns directly with the experience, approach, and values of Makers Design Co.

Our firm specializes in the design, renovation, and expansion of public-sector facilities across Texas, including fire stations, municipal buildings, and other essential infrastructure. We have completed more than 75 public projects statewide, and our key personnel have **experience planning and designing more than 20 fire stations throughout Texas, ranging from small, volunteer-based departments to larger essential facilities**. This depth of experience allows us to tailor solutions that are right-sized, operationally efficient, and responsive to community needs.

Makers Design Co. brings a principal-led, hands-on approach to every project. Clients work directly with firm owners Nathan Brandt, AIA, RID, CSI, NCARB, and Briana Brandt, AIA, RID, ensuring consistent communication, responsiveness, and accountability throughout all phases of the work. Our team is supported by trusted consultants, allowing us to provide full architectural, site planning, interior design, and specifications services while remaining efficient and cost-conscious.

We are already familiar with the City of Brady's processes, priorities, and expectations, having previously worked with the City on the City Hall Renovation and the Animal Control Facility projects. This established working relationship allows us to move quickly, collaborate effectively with City staff, and build on an understanding of local goals, constraints, and standards.

Our approach emphasizes early collaboration with City leadership and fire department staff to confirm operational needs, staffing models, apparatus requirements, site constraints, and long-term maintenance considerations. Our construction documents are clear, coordinated, and buildable—reducing RFIs and minimizing change orders during construction.

We believe we are well suited to support the City of Brady based on the following qualifications:

- Direct experience working with the City of Brady on municipal projects
- Key personnel experience on more than 20 fire stations across Texas
- Strong understanding of small-community and volunteer-based department needs
- Proven ability to deliver cost-effective, right-sized municipal facilities
- Expertise in site development, drainage, and utility coordination
- Principal-led project delivery focused on efficiency and accountability
- Thorough knowledge of Texas Accessibility Standards (TAS) and applicable codes

We appreciate the opportunity to be considered for this important project and would be honored to continue our partnership with the City of Brady. This is a short-form SOQ, and we would be happy to answer any additional questions or provide further detail regarding our experience with fire stations, feasibility studies, or similar municipal projects.

Best,



Nathan Brandt, AIA, RID, CSI, NCARB
 Founding Principal
 Direct: 979-739-3709



Briana K. Brandt, AIA, RID
 Founding Principal
 Direct: 512-964-8869



NATHAN BRANDT AIA, RID, CSI, NCARB

Project Manager, QA/QC



Nathan Brandt is a registered Architect and Interior Designer in the state of Texas with over 13 years of experience. He oversees all aspects of design coordination, working closely with clients, consultants, and contractors to ensure projects stay on track and on budget. Nathan brings a decade of experience assembling comprehensive project manuals, ensuring that documentation is clear, consistent, and aligned with constructability and performance goals. He is a proactive leader who excels at managing large, multidisciplinary teams and is committed to providing transparency and accountability at every stage. Nathan fosters a highly collaborative process—working closely with construction teams to integrate real-time value engineering throughout design. His depth of experience across public-sector projects makes him a reliable and strategic partner from project kickoff through closeout.

CREDENTIALS

Registered Architect, TX
#26840

Registered Interior Designer, TX
#12185

EDUCATION

Master of Architecture
Certificate in Health Systems & Design
Texas A&M University
Bachelor of Environmental Design
Minor in Business Administration
Texas A&M University

EXPERIENCE

Architecture - 13.5 Years
Specifications Writer - 10 Years
Interior Design - 8 Years

FIRE STATION EXPERIENCE

*Hearne Public Safety Building | Hearne, Texas
Fire Station No. 1 Assessment & Renovation | Rosenberg, TX
*Harris County ESD 20 Fire Station No. 44 | Houston, TX
Fire Station No. 1 & EMS | Clute, TX
Simonton Fire Station No. 1 | Fulshear, TX
Fire Station No. 6 | Georgetown, TX
Fire Station No. 7 | Georgetown, TX
*Fire Station No. 3 & Training Facility | Klein, TX
Fire Station No. 8 | Klein, TX
Fire Station, Administration Maintenance, Training Master Plan | Klein, TX
Fire Station No. 1 | Pearland, TX
Fire Station No. 2 | Pearland, TX
Fire Station No. 3 | Pearland, TX
Fire Station No. 2 | Richmond, TX
Fire Station No. 3 | Schertz, TX
Fire Station No. 74 | Spring, TX
Fire Station No. 75 | Spring, TX
Fire Station No. 21 | Aldine, TX
Onion Creek Fire Station No. 1 | Austin, TX
Klein Maintenance Facility | Klein, TX



BRIANA K. BRANDT AIA, RID

Project Architect, Interiors Coordinator

Briana K. Brandt is a registered Architect and Interior Designer in the state of Texas. With 12 years of experience, Briana approaches each project with creativity, efficiency, strong analytical skills, and enthusiasm. Her detail-oriented mindset paired with strong problem-solving skills and technical expertise allow her to develop clear, buildable solutions that align with client needs. Briana has worked on a wide range of projects, including Public, Commercial, Higher Education, Hospitality, K-12, Healthcare, and Residential, guiding them from early design through construction. She is committed to fostering strong client relationships and a collaborative team approach, ensuring that each project is tailored to the unique goals of the owner and end-users. Her focus is always on delivering high-quality, well-coordinated designs that make sense both aesthetically and practically.

CREDENTIALS

Registered Architect, TX
#27338

Registered Interior Designer, TX
#12184

EXPERIENCE

Architecture - 12.5 Years
Interior Design - 8 Years

FIRE STATION & PUBLIC PROJECT EXPERIENCE

*Hearne Public Safety Building | Hearne, Texas
Fire Station No. 1 Assessment & Renovation | Rosenberg, TX
*Harris County ESD 20 Fire Station No. 44 | Houston, TX
Brazoria County Courthouse Expansion & Improvements | Angleton, TX
Seabourne Creek Park Nature Center | Rosenberg, TX
Oscar Johnson Jr. Community Center | Conroe, TX
Westside Recreation Center Roof Replacement | Conroe, TX
Hitchcock EDC Building Assessment | Hitchcock, TX

KLEIN FIRE STATION NO. 3 & TRAINING FACILITY

11,000 SF | Klein, TX

**PROJECT DATA****Owner**

Harris County ESD 16

Services Provided

Full Architectural

Budget

\$3.6 million

Completion

2018

Contractor

LDF Construction Inc.

*Fire Station Project Type**On-Site Training**Budget-Conscious Design***SCOPE**

The Klein Fire Department commissioned the design and construction of Fire Station No. 3 and a companion fire training facility on a shared 7-acre site. The project includes an 11,000 SF fire station paired with a 3,500 SF training facility, providing a **cost-effective solution that maintains operational readiness while keeping firefighters within the district during emergency events.**

A key project objective was maintaining uninterrupted fire service throughout construction. A carefully developed phasing plan allowed the training facility to temporarily function as an active fire station, enabling the existing Fire Station No. 3 to remain operational until the new facility was complete. This approach demonstrates experience in **phased construction planning for essential facilities**, minimizing service disruption—an important consideration for communities with limited response redundancy.

Nathan Brandt served as Project Architect and worked closely with the Client to confirm station programming, budget constraints, and operational goals. His role included **site and building planning, design, engineering coordination, bidding and procurement, and construction administration**, ensuring the project met functional needs while remaining within budget.

The fire station was designed to support a **volunteer-based department staffed for 8 personnel with 3 shift changes**, and includes three pull-through apparatus bays, staff offices, living quarters, PPE storage, fitness room, and associated support spaces. Adjacent site improvements include a covered fueling station for department vehicles and secure storage for training equipment. The training facility provides **flexible indoor and outdoor instructional spaces**, allowing for hands-on training, simulated burn exercises, and post-incident review and debriefing—supporting operational preparedness and ongoing skill development applicable to the City of Brady's fire station and training needs.

HARRIS COUNTY ESD 20 FIRE STATION NO. 44

24,000 SF | Houston, TX

**PROJECT DATA****Owner**

Harris County ESD 20

Services Provided

Full Architectural

Budget

\$7.3 million

Completion

2021

Contractor

Teal Construction Company



Fire Station Project Type



Similar Scope



Budget-Conscious Design

SCOPE

Harris County Emergency Services District No. 20 commissioned the design and construction of a new fire station and training campus to meet the growing operational demands of the district. Nathan Brandt served as Project Manager on the project providing full architectural services for the project, including site planning, building design, and coordination of essential facility requirements. The 9-acre site is organized into three functional zones: Response, Administration, and Training, allowing efficient separation of daily operations, leadership functions, and instructional activities.




Fire Station No. 44 is an approximately 24,000 SF facility designed to support efficient, modern emergency response operations. The station **includes apparatus pull-through bays with four-fold doors to support rapid deployment and return**, along with interior spaces that include sleeping quarters, fitness facilities, kitchen and day room, and operational support spaces—element.

As an essential facility, the fire station incorporates full generator backup and Risk Category IV construction to ensure continuous operation during emergency events. The administrative component provides office space for department leadership, records storage, and future operational flexibility, and includes a conference room designed to function as an incident command and coordination center, **supporting organized response during large-scale or multi-agency emergencies**.

The site also includes maintenance and training support buildings, an instructional pavilion, and provisions for future expansion of training infrastructure, including multi-story training elements for fire, rescue, and high-angle response scenarios. The project demonstrates **experience in designing resilient, adaptable fire stations that balance operational efficiency, long-term flexibility, and budget-conscious planning**, directly applicable to the City of Brady's planned fire station project.

HEARNE PUBLIC SAFETY BUILDING ASSESSMENT & DESIGN

27,000 SF | Hearne, TX

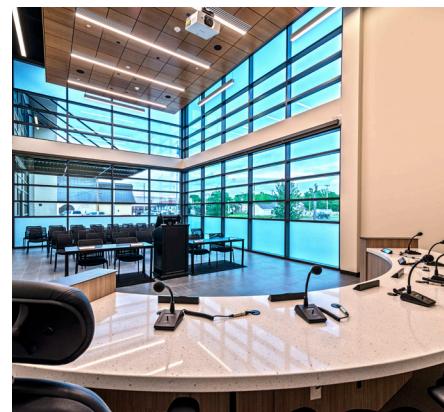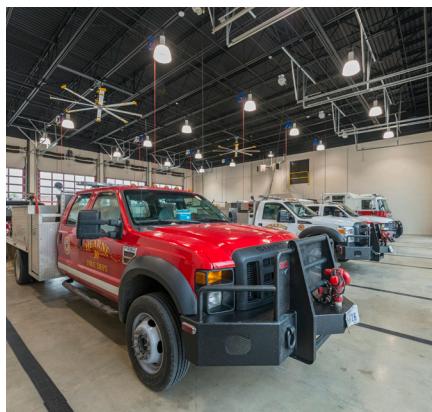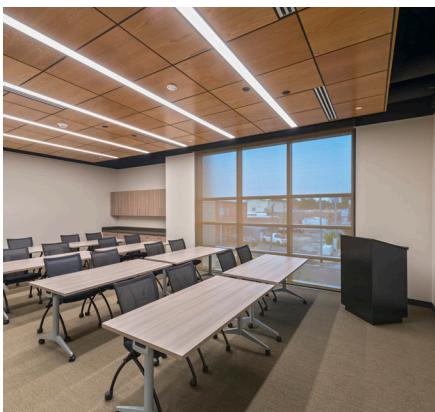**PROJECT DATA****Owner**

City of Hearne

Services Provided

Building Assessment & Architectural

Budget

\$7.5 million

Completion

2021

Contractor

Madison Construction



Fire Station Project Type



Comparable Texas Community



Feasibility Assessment Included

SCOPE

Located at the corner of W. 3rd Street and Cedar Street in downtown Hearne, Texas, the Hearne Public Safety Building serves as a consolidated civic facility housing the Fire Department, Police Department, Municipal Courts, Council Chambers, and supporting municipal services.

Prior to design, our team conducted a detailed assessment of the City's existing facilities to identify operational gaps, staffing needs, and long-term growth considerations. **Multiple planning options were developed and evaluated to balance operational functionality with budget constraints.**



The Volunteer Fire Department component was planned to support daily operations, emergency response, and firefighter health and safety. The facility **includes four (4) pull-through apparatus bays (two apparatus deep)** sized for modern fire and EMS vehicles, with **heated bays, floor drains, and integrated air and power drops** to support year-round operations and vehicle maintenance.

Firefighter support spaces include dedicated **bunker gear storage, a gear extractor and decontamination area, restrooms and showers, and air-lock separation between apparatus bays and clean areas**, reinforcing best practices for contaminant control and cancer-prevention measures. A separate watch office allows for operational oversight without interfering with apparatus circulation. The building was also **designed with operational resilience in mind**, incorporating a full-building emergency power system to maintain fire, EMS, and dispatch operations during power outages. A mezzanine level provides additional storage, allowing primary operational spaces to remain efficient and uncluttered.

While the Hearne facility integrates multiple public safety departments, the project demonstrates **our experience planning fire station environments that prioritize apparatus flow, decontamination separation, firefighter support spaces, emergency power resiliency, and long-term adaptability.**


AN E.M.S. FACILITY DESIGNED FOR THE CITY OF DUBLIN

EAST ELM STREET, DUBLIN, TEXAS 76446

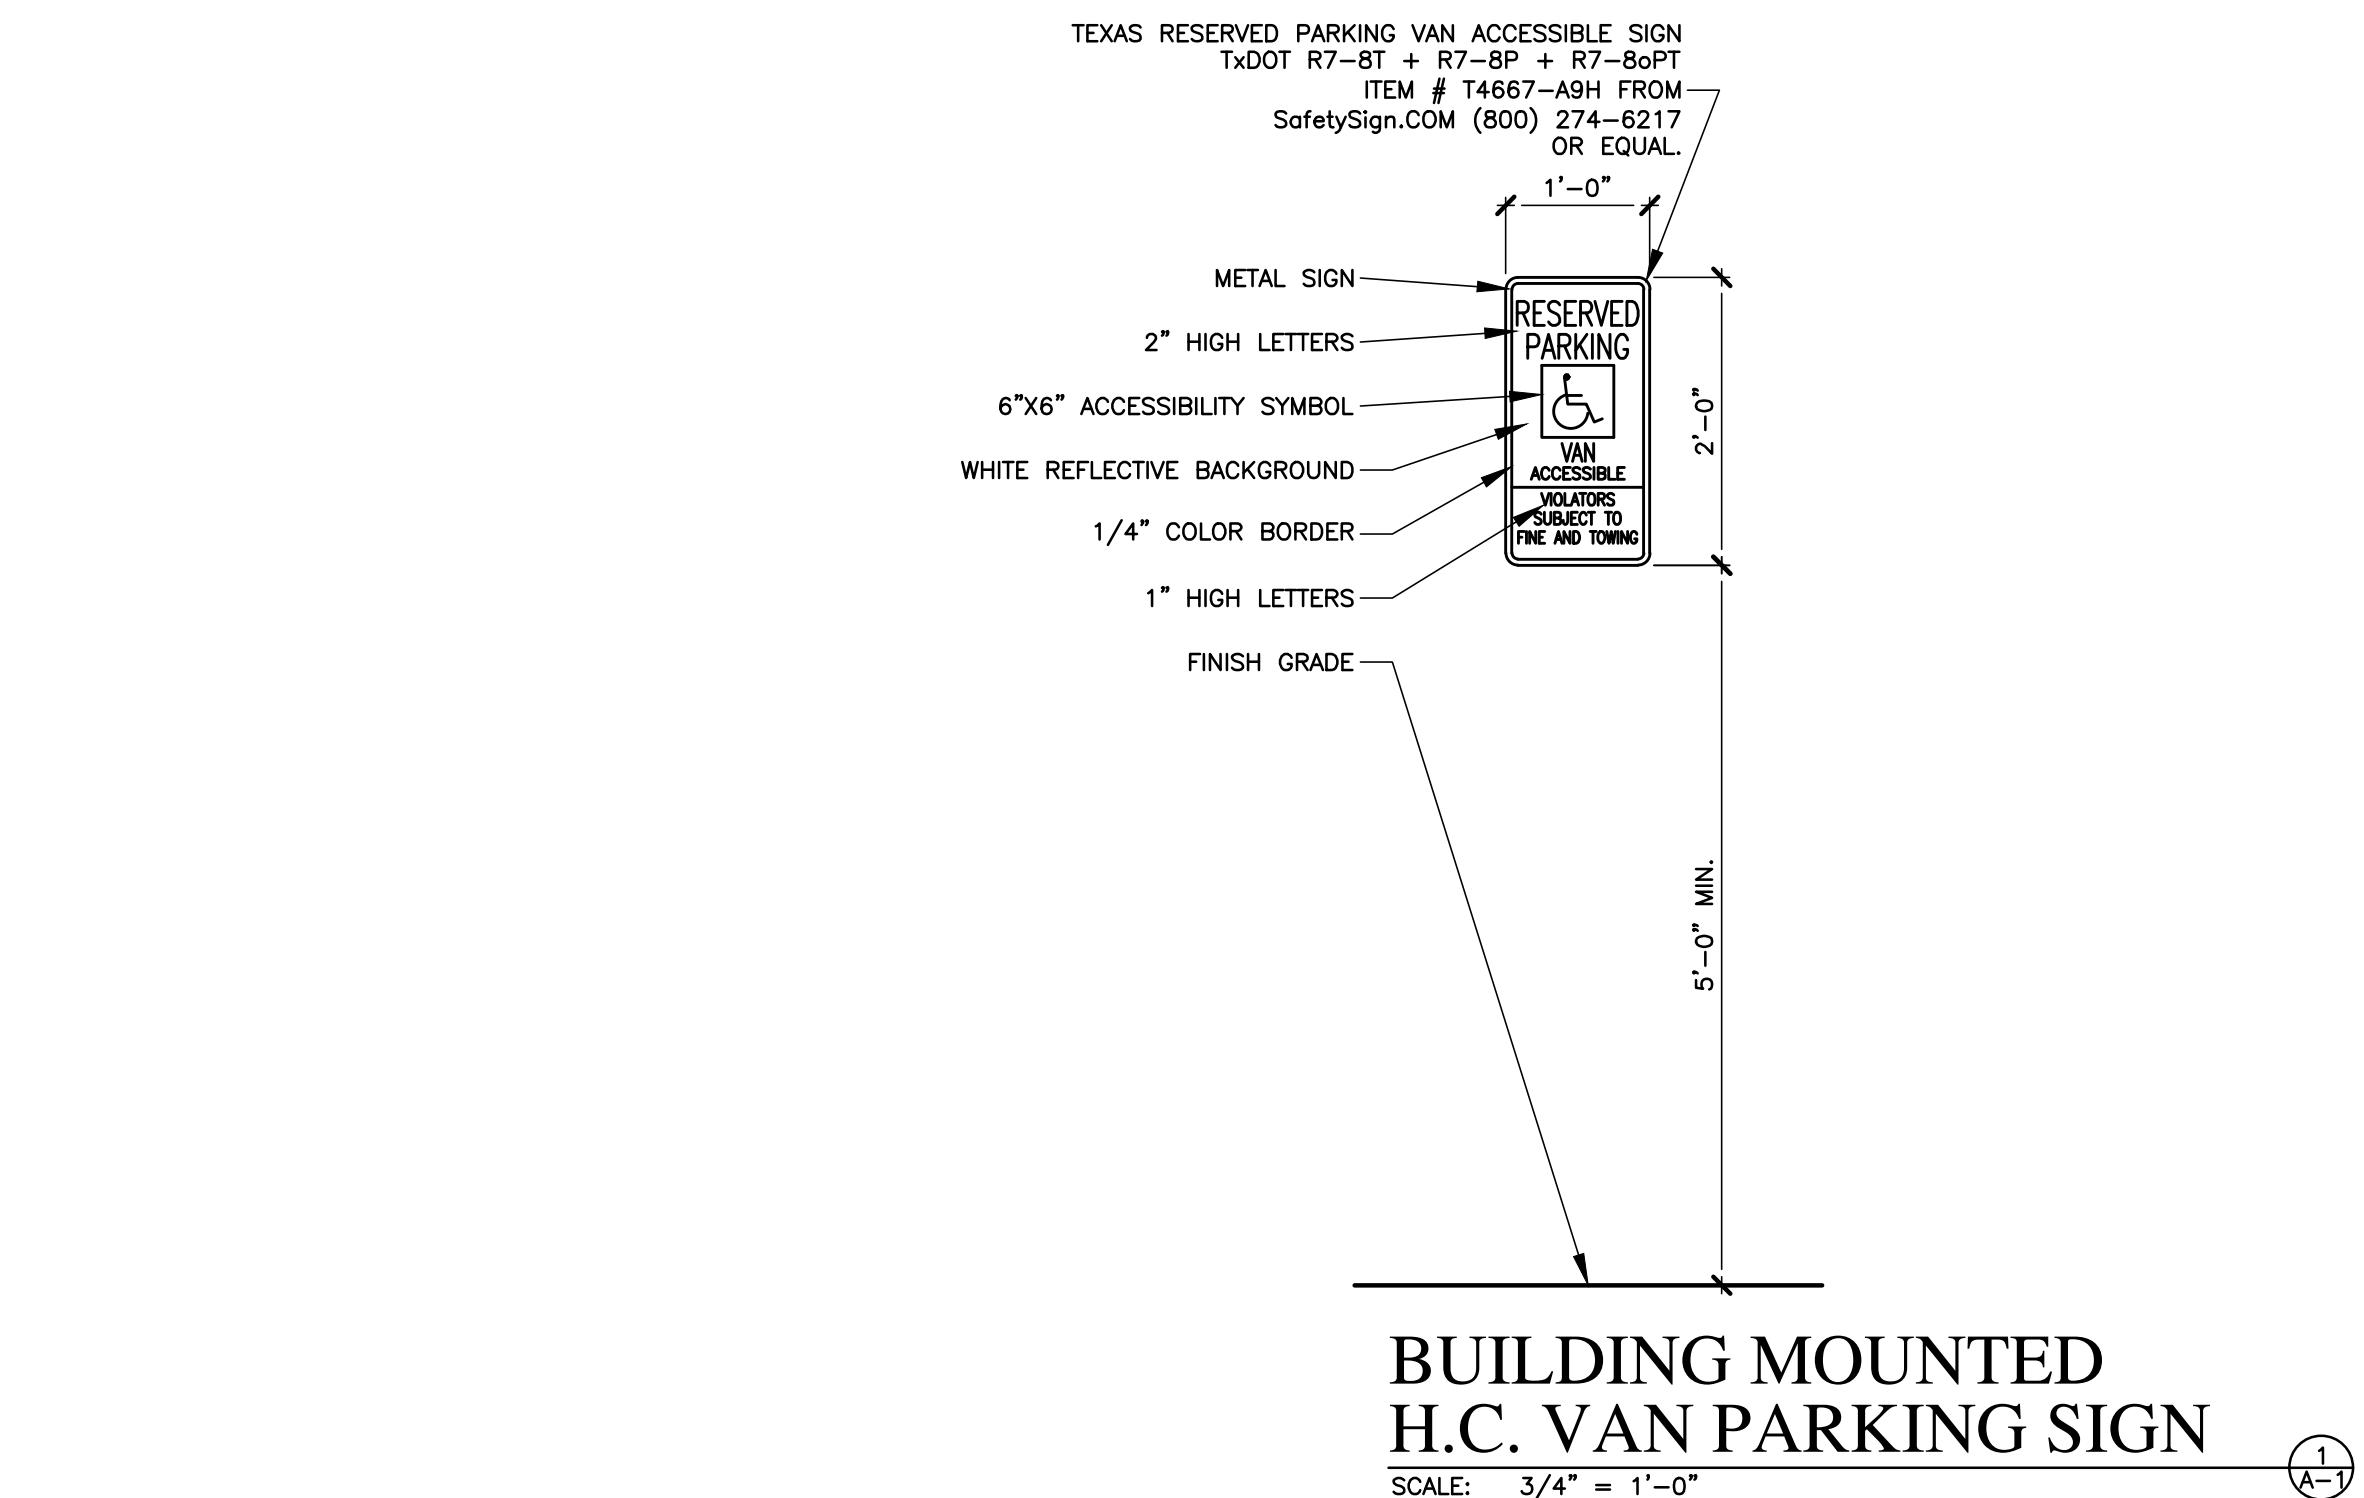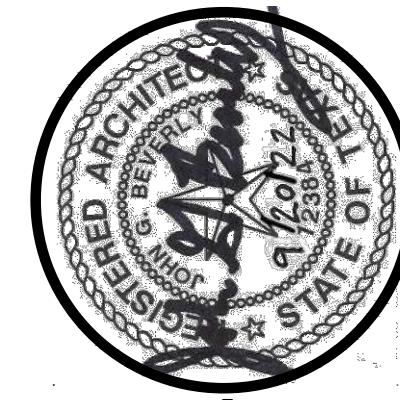


SITE NOTES:

- ALL WORK SHALL BE PERFORMED IN ACCORDANCE WITH REQUIREMENTS SET FORTH IN APPLICABLE SECTIONS OF THE 2015 IBC (INTERNATIONAL BUILDING CODE).
- CONTRACTOR SHALL VERIFY EXISTING SITE CONDITIONS PRIOR TO SUBMITTING A BID OR STARTING CONSTRUCTION.
- CONTRACTOR SHALL VERIFY LOCATION OF UTILITIES WITH LOCAL UTILITY COMPANIES AND CITY PRIOR TO SUBMITTING BID OR STARTING CONSTRUCTION.
- CONTRACTOR SHALL VERIFY ALL SITE DIMENSIONS PRIOR TO SUBMITTING BID OR STARTING CONSTRUCTION.
- CONTRACTOR SHALL REMOVE ANY VEGETATION, ROCKS, OR OTHER UNWANTED ITEMS FROM THE STRUCTURES LOCATION ON THE BUILDING SITE PRIOR TO STARTING EARTHWORK.
- SOILS AT THE STRUCTURES LOCATION SHALL BE SCARIFIED TO A DEPTH OF 6". THE SCARIFIED SOILS SHALL THEN BE RE-COMPACTED TO BETWEEN 92 PERCENT AND 98 PERCENT OF STANDARD PROCTOR DENSITY (ASTM D-698). THE MOISTURE CONTENT OF THE SOIL SHALL BE MAINTAINED AT OR ABOVE THE OPTIMUM MOISTURE VALUE.
- FILL MATERIAL SHALL BE 'SELECT FILL' AND SHALL BE COMPAKTED IN 8" MAXIMUM LIFTS. FILL MATERIAL SHALL THEN BE COMPACTED TO BETWEEN 95 PERCENT AND 100 PERCENT OF STANDARD PROCTOR DENSITY (ASTM D-698). THE MOISTURE CONTENT OF THE SOIL SHALL BE MAINTAINED AT OR ABOVE THE OPTIMUM MOISTURE VALUE.
- ALL PARKING STRIPING SHALL BE LOCATED AS SHOWN ON SITE PLAN AND SHALL BE MARKED WITH 4" WIDE PAINTED STRIPES.
- FINE GRADE ALL LANDSCAPED AREAS AT COMPLETION OF PROJECT.
- CONTRACTOR SHALL KEEP SITE CLEAR OF RUBBISH AND TRASH AT ALL TIMES.
- CONTRACTOR SHALL BE RESPONSIBLE FOR CONTROLLING SITE EROSION DURING CONSTRUCTION AND SHALL INSTALL SILT FENCING IF REQUIRED.
- CONTRACTOR SHALL BE RESPONSIBLE FOR ESTABLISHING FINAL GRADING IN ORDER TO MAINTAIN NATURAL FLOW OF SURFACE WATER. WATER MUST NOT BE ALLOWED TO STAND AROUND BUILDING DURING CONSTRUCTION OR UPON COMPLETION OF PROJECT.

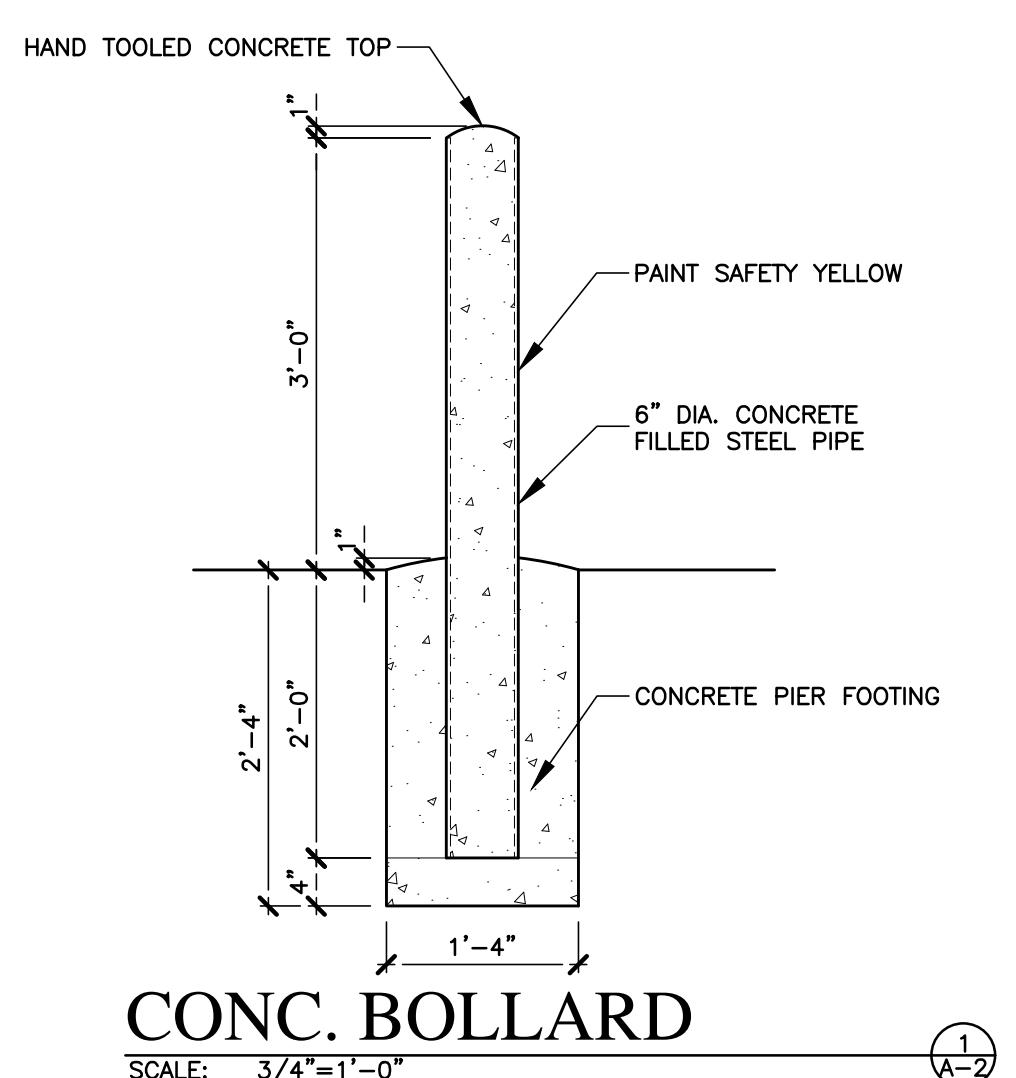

ENGINEERING REQUIREMENT NOTE:

THIS ADDITION WAS LESS THAN 5,000 SQUARE FEET AND DID NOT HAVE A SPAN THAT EXCEEDED 24', THEREFORE ENGINEERING WAS NOT REQUIRED BY THE "TEXAS STATE ENGINEERING PRACTICE ACT" FOR THIS PORTION OF THE PROJECT, AND THE DRAWINGS FOR THIS PORTION OF THE PROJECT DO NOT NEED TO BE SEALED BY AN ENGINEER LICENSED IN THE STATE OF TEXAS. THIS DRAWING IS A NON-ENGINEERED DESIGN PROVIDED AND SEALED BY THE ARCHITECT.

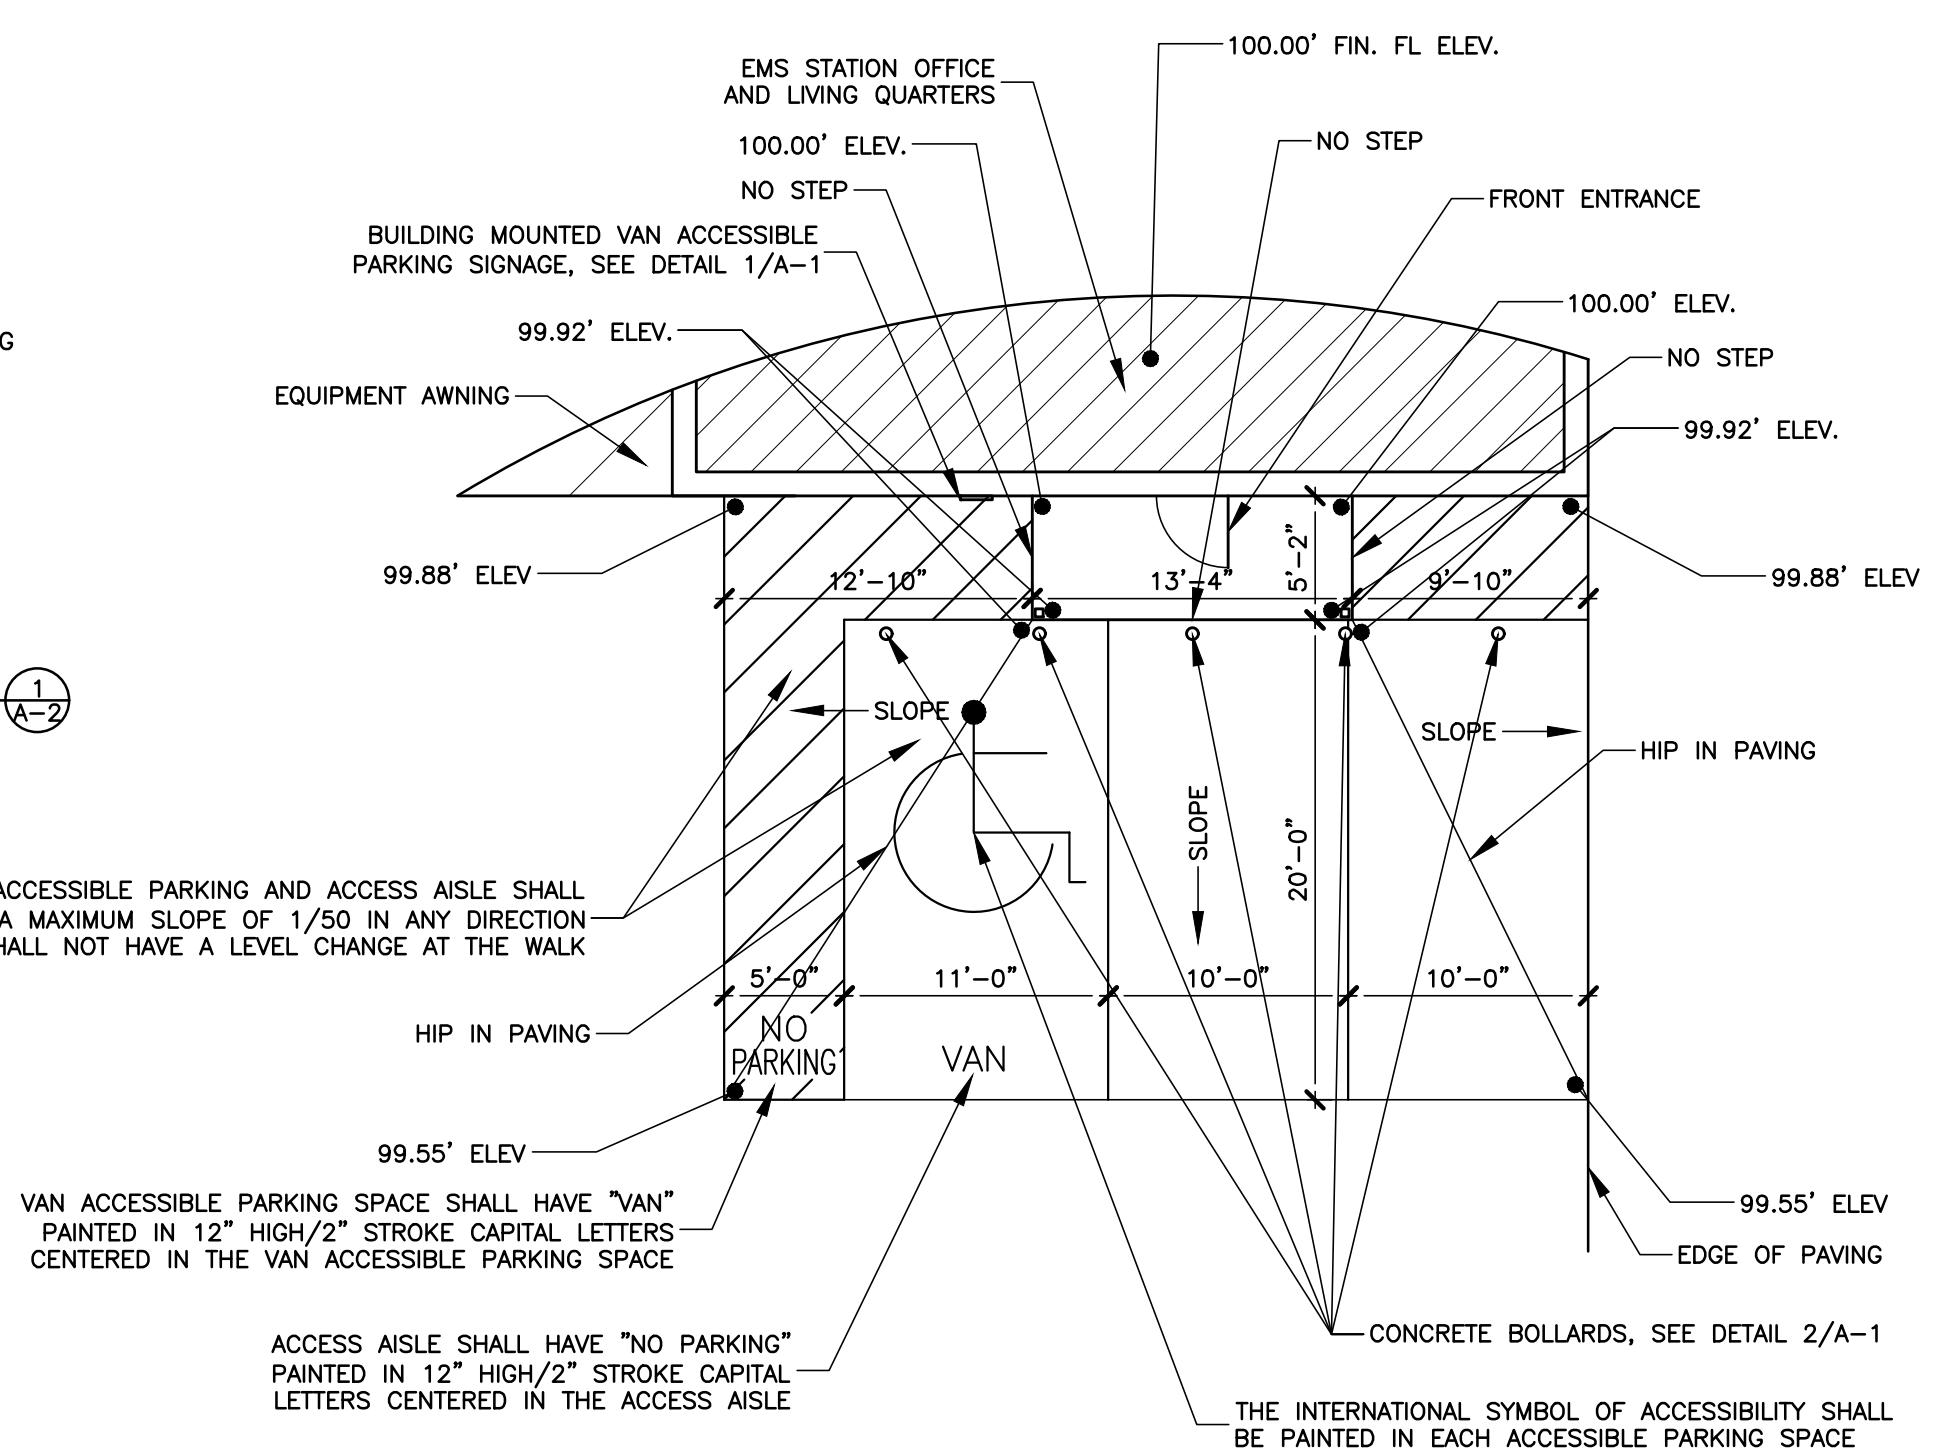

LIST OF CONTACTS:

ARCHITECT:

JOHN G. BEVERLY - ARCHITECT
P.O. BOX 1990
STEPHENVILLE, TEXAS 76401
(254) 396-9999


OWNER/DEVELOPER:

CITY OF DUBLIN
213 E. BLACKJACK ST.
DUBLIN, TEXAS 76446
(254) 445-3331

LIST OF DRAWINGS:

ARCHITECTURAL:

A-1 COVER, SITE PLAN, SITE NOTES & DETAILS
A-2 FLOOR PLAN SCHEDULES & NOTES
A-3 ENLARGED PLANS & INTERIOR ELEVATIONS
A-4 ACCESSIBILITY COMPLIANCE PLAN
A-5 EXTERIOR ELEVATIONS
TAS-1 TEXAS ACCESSIBILITY STANDARDS SHEET 1
TAS-2 TEXAS ACCESSIBILITY STANDARDS SHEET 2
TAS-3 TEXAS ACCESSIBILITY STANDARDS SHEET 3
TAS-4 TEXAS ACCESSIBILITY STANDARDS SHEET 4
TAS-5 TEXAS ACCESSIBILITY STANDARDS SHEET 5
TAS-6 TEXAS ACCESSIBILITY STANDARDS SHEET 6

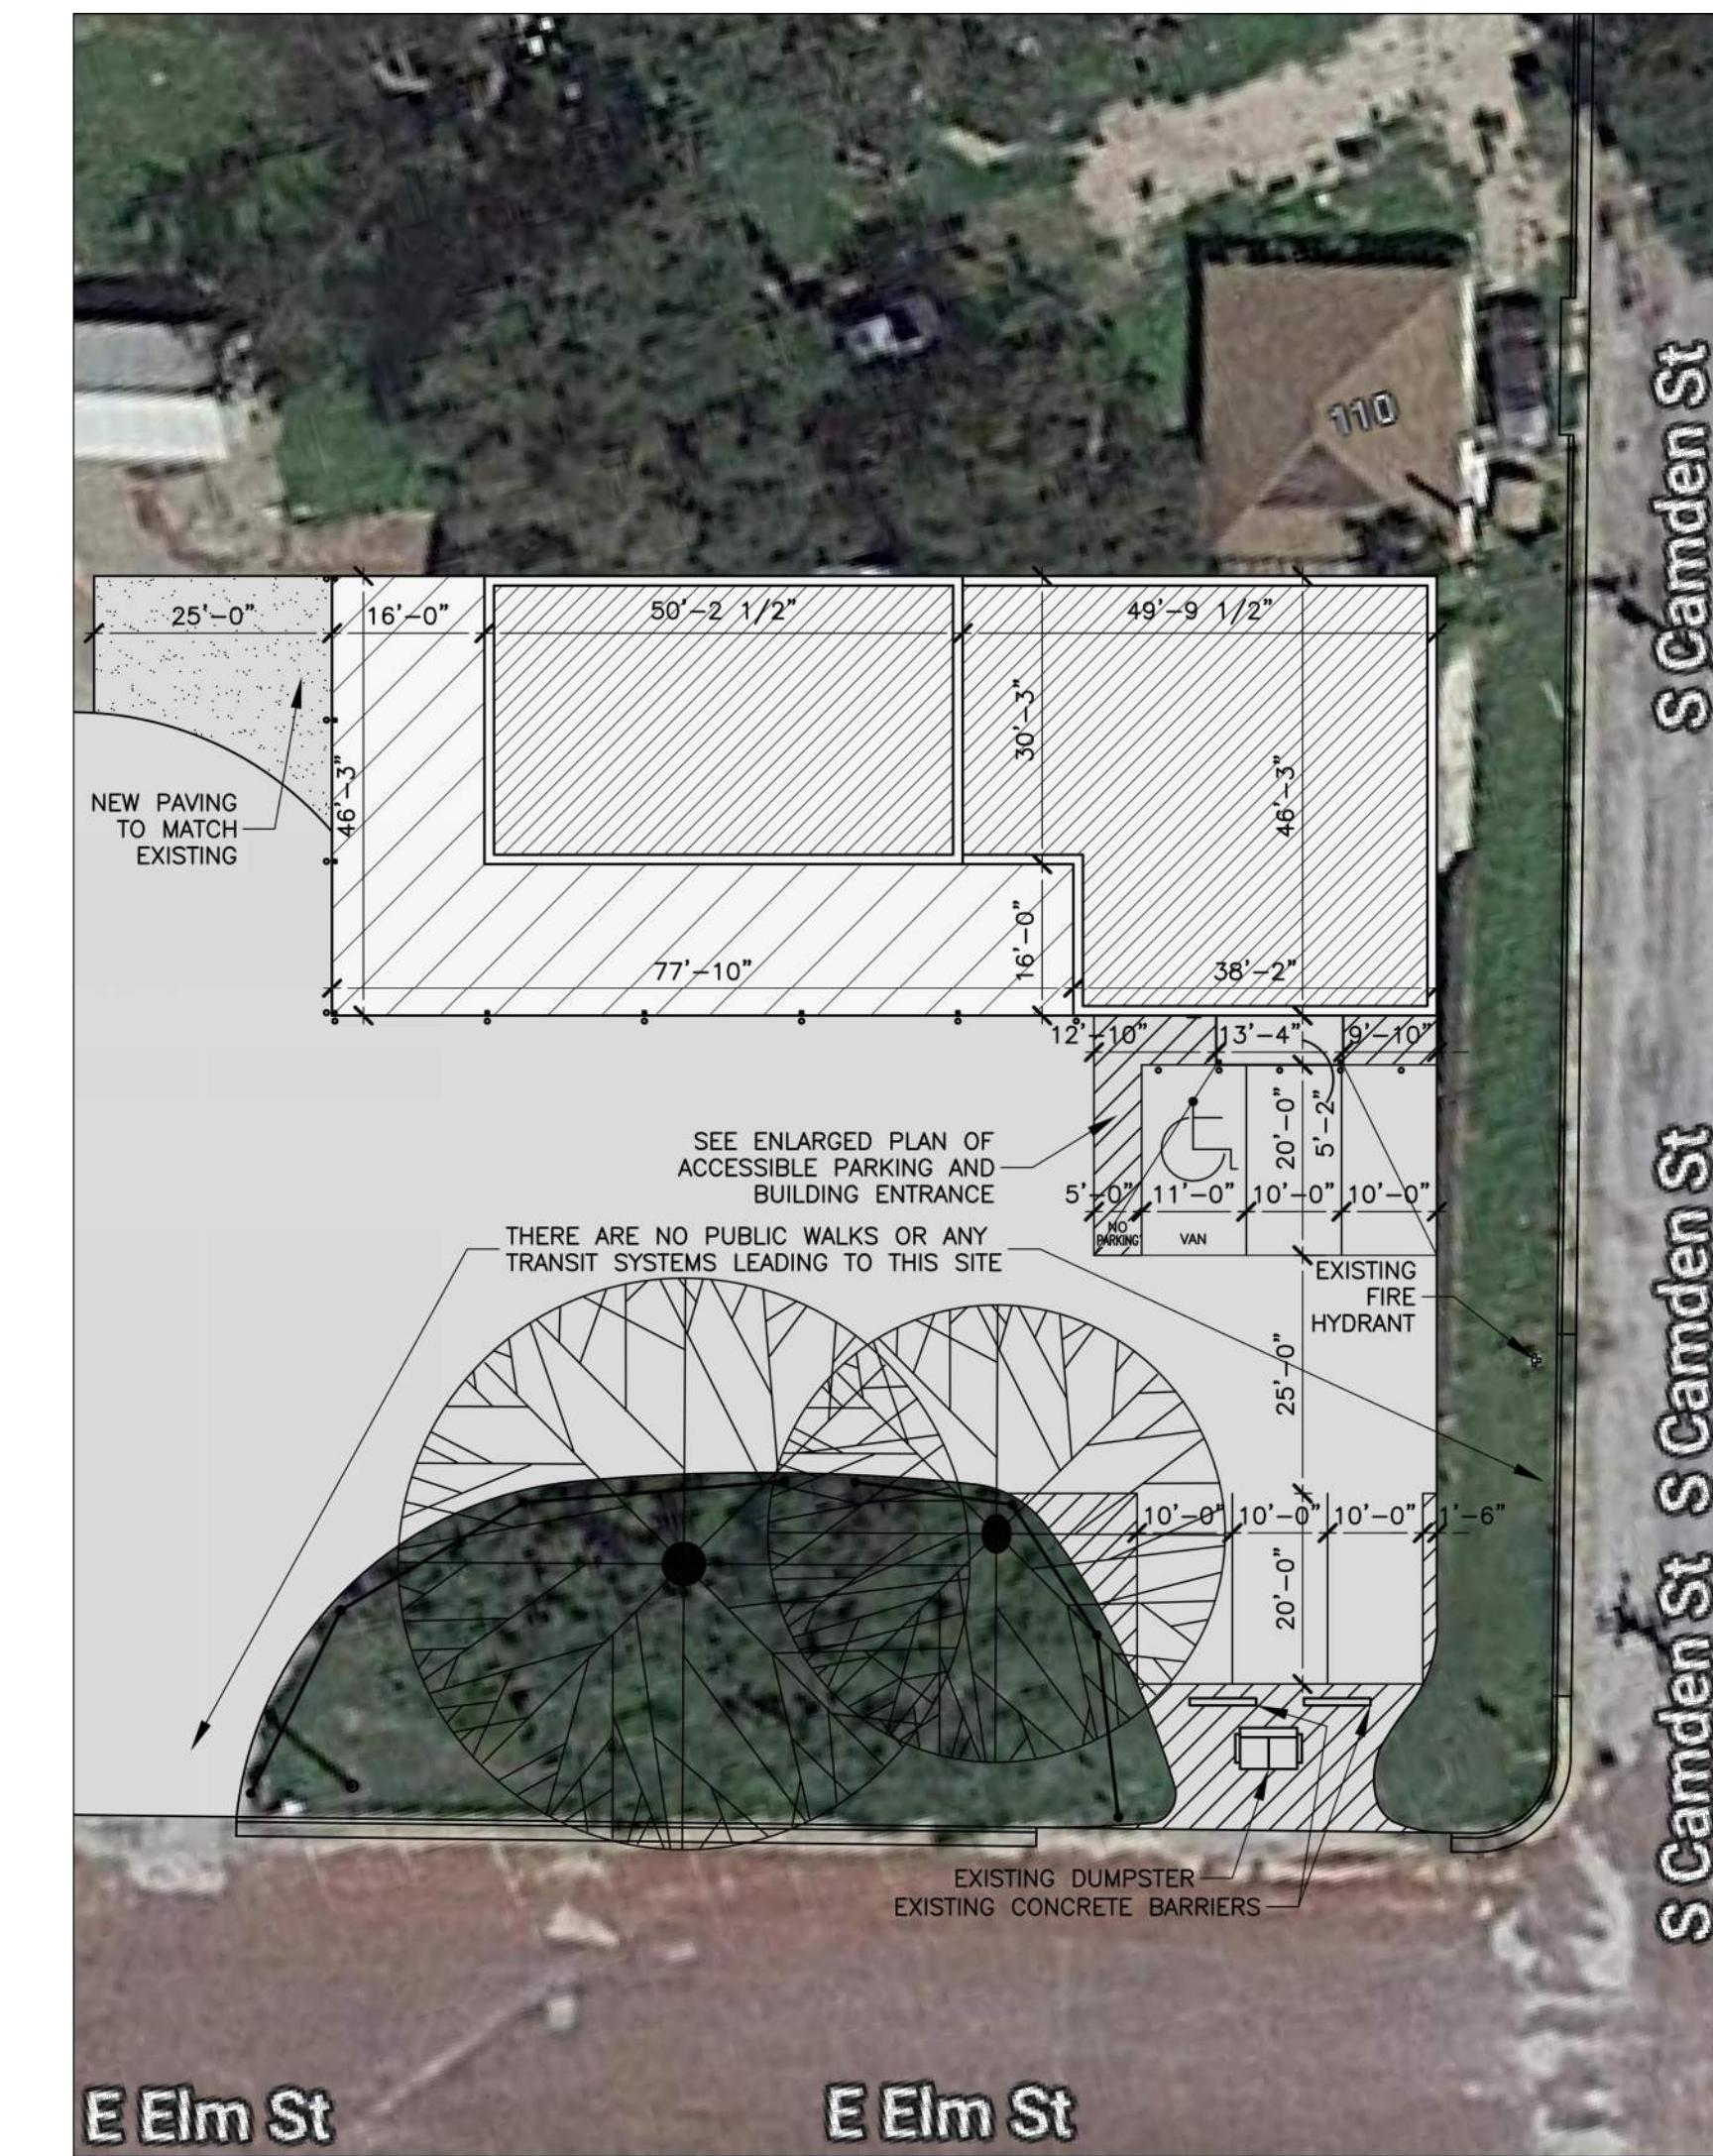

SITE PLAN
SCALE: 1/4" = 20'-0"

A FACILITY DESIGNED FOR
DUBLIN EMS
DUBLIN, TEXAS
JOHN G. BEVERLY • ARCHITECT
STEPHENVILLE, TEXAS 76401
john@jgbarch.com



DRAWINGS THIS SHEET:
JOHN G. BEVERLY • ARCHITECT
P.O. BOX 1990
(254) 396-9999 M.

1 SHEET NO.
22C10
3 DATE:
3/31/22
4 REVISED:
9/20/22
5 DRAWN BY:
J.G.B.
6 ARCHITECT

1 SHEET NO.
A-1
2 DATE:
22C10
3 DRAWN BY:
J.G.B.
4 REVISED:
9/20/22
5 SITE PLAN
6 SITE DETAILS
7 SITE NOTES

EMPLOYEE WORK AREA SCHEDULE:

MK.	SPACE NAME	MK.	SPACE NAME
EX	EXISTING TRUCK BAY	106	STORAGE
100	EQUIPMENT AWNING	121	STORAGE

ACCESSIBLE KITCHEN SHELVING:

TYPE	LOCATION	CALCULATION	TOTAL	PERCENT
ACCESSIBLE	LOWER	(5.46'+8.83'+1.50') LONG X (2' WIDE) X (1 SHELF HIGH*)	31.58 SQ.FT.	63.97%
NON ACCESSIBLE	UPPER	(6.46'+9.83'+1.50') LONG X (1' WIDE) X (1 SHELF HIGH*)	17.79 SQ.FT.	36.03%
ALL CABINETS	BOTH	(TOTAL OF ABOVE)	49.37 SQ.FT.	100.00%

* NOTE THAT UPPER CABINET ADJUSTABLE SHELVES NOT INSTALLED AND THE BOTTOM OF THE LOWER CABINET IS BLOCKED FROM USE AS A SHELF WHEN A DISABLED EMS WORKER IS PRESENT.

ACCESSIBLE UTILITY SHELVING:

TYPE	LOCATION	CALCULATION	TOTAL	PERCENT
ACCESSIBLE	LOWER	(8.46' LONG) X (2' WIDE) X (1 SHELF HIGH*)	16.92 SQ.FT.	64.14%
NON ACCESSIBLE	UPPER	(9.46' LONG) X (1' WIDE) X (1 SHELF HIGH*)	9.46 SQ.FT.	35.86%
ALL CABINETS	BOTH	(TOTAL OF ABOVE)	26.38 SQ.FT.	100.00%

* NOTE THAT UPPER CABINET ADJUSTABLE SHELVES NOT INSTALLED AND THE BOTTOM OF THE LOWER CABINET IS BLOCKED FROM USE AS A SHELF WHEN A DISABLED EMS WORKER IS PRESENT.


ACCESSIBLE STUDY SHELVING:

TYPE	LOCATION	CALCULATION	TOTAL	PERCENT
ACCESSIBLE	LOWER	(6.00'+1.00' LONG) X (2' WIDE) X (1 SHELF HIGH*)	14.00 SQ.FT.	63.64%
NON ACCESSIBLE	UPPER	(7.00'+1.00' LONG) X (1' WIDE) X (1 SHELF HIGH*)	8.00 SQ.FT.	36.36%
ALL CABINETS	BOTH	(TOTAL OF ABOVE)	22.00 SQ.FT.	100.00%

* NOTE THAT UPPER CABINET ADJUSTABLE SHELVES NOT INSTALLED AND THE BOTTOM OF THE LOWER CABINET IS BLOCKED FROM USE AS A SHELF WHEN A DISABLED EMS WORKER IS PRESENT.



ACCESSIBILITY NOTES:

- GENERAL:** THE PROJECT SHALL FULLY COMPLY WITH THE 2012 TAS "TEXAS ACCESSIBILITY STANDARDS" A PDF FORMAT FILE OF THE COMPLETE 2012 TAS REGULATIONS IS AVAILABLE AS A DOWNLOAD FROM THE TDLR "TEXAS DEPARTMENT OF LICENSING AND REGULATION" ARCHITECTURAL BARRIERS WEB SITE AT... <http://www.tdlr.state.tx.us/ab/2012TAS/2012tascomplete.pdf>
- FLOOR OR GROUND SURFACES:** FLOOR AND GROUND SURFACES SHALL BE STABLE, FIRM, AND SLIP RESISTANT AND SHALL COMPLY WITH SECTION 302 OF THE 2012 TAS.
- CHANGES IN LEVEL:** WHERE CHANGES IN LEVEL ARE PERMITTED IN FLOOR OR GROUND SURFACES, THEY SHALL COMPLY WITH SECTION 303 OF THE 2012 TAS.
- TURNING SPACE:** TURNING SPACE SHALL COMPLY WITH SECTION 304 OF THE 2012 TAS.
- CLEAR FLOOR OR GROUND SPACE:** CLEAR FLOOR OR GROUND SPACE SHALL COMPLY WITH SECTION 305 OF THE 2012 TAS.
- KNEE AND TOE CLEARANCE:** WHERE SPACE BEHIND AN ELEMENT IS INCLUDED AS PART OF CLEAR FLOOR OR GROUND SPACE OR TURNING SPACE, THE SPACE SHALL COMPLY WITH SECTION 306 OF THE 2012 TAS. ADDITIONAL SPACE SHALL NOT BE PROHIBITED BEHIND AN ELEMENT BUT SHALL NOT BE CONSIDERED PART OF THE CLEAR FLOOR OR GROUND SPACE OR TURNING SPACE.
- PROTRUDING OBJECTS:** PROTRUDING OBJECTS SHALL COMPLY WITH SECTION 307 OF THE 2012 TAS.
- REACH RANGES:** REACH RANGES SHALL COMPLY WITH SECTION 308 OF THE 2012 TAS.
- OPERABLE PARTS:** OPERABLE PARTS SHALL COMPLY WITH SECTION 309 OF THE 2012 TAS.
- ACCESSIBLE ROUTES:** ACCESSIBLE ROUTES SHALL COMPLY WITH SECTION 402 OF THE 2012 TAS.
- WALKING SURFACES:** WALKING SURFACES THAT ARE A PART OF AN ACCESSIBLE ROUTE SHALL COMPLY WITH SECTION 403 OF THE 2012 TAS.
- DOORS, DOORWAYS, AND GATES:** DOORS, DOORWAYS, AND GATES THAT ARE PART OF AN ACCESSIBLE ROUTE SHALL COMPLY WITH SECTION 404 OF THE 2012 TAS.
- RAMPS:** THERE ARE NO RAMPS ON THIS PROJECT SECTION 405.
- CURB RAMPS:** THERE ARE NO CURB RAMPS ON THIS PROJECT SECTION 406.
- ELEVATORS OF ANY KIND OR PLATFORM LIFTS:** THERE ARE NO ELEVATORS ON THIS PROJECT SECTION 407, 408, 409 & 410.
- PARKING SPACES:** CAR AND VAN PARKING SPACES SHALL COMPLY WITH SECTION 502 OF THE 2012 TAS. WHERE PARKING SPACES ARE MARKED, LINES WITHIN MEASUREMENTS OF PARKING SPACES AND ACCESS AREAS SHALL BE MADE FROM THE CENTERLINE OF THE MARKINGS.
- PASSENGER LOADING ZONES:** THERE ARE NO PASSENGER LOADING ZONES ON THIS PROJECT SECTION 503.
- STAIRWAYS:** THERE ARE NO STAIRS ON THIS PROJECT SECTION 504.
- HANDRAILS:** THERE ARE NO HANDRAILS ON THIS PROJECT SECTION 505.
- DRINKING FOUNTAINS:** THERE ARE NO DRINKING FOUNTAINS ON THIS PROJECT SECTION 602.
- TOILET AND BATHING ROOMS:** TOILET AND BATHING ROOMS SHALL COMPLY WITH SECTION 603 OF THE 2012 TAS.
- WATER CLOSETS AND TOILET COMPARTMENTS:** WATER CLOSETS AND TOILET COMPARTMENTS SHALL COMPLY WITH SECTION 604.2 THROUGH 604.8 OF THE 2012 TAS.
- URINALS:** THERE ARE NO URINALS ON THIS PROJECT SECTION 605.
- LAVATORIES AND SINKS:** LAVATORIES AND SINKS SHALL COMPLY WITH SECTION 606 OF THE 2012 TAS.
- BATHTUBS:** THERE ARE NO BATHTUBS ON THIS PROJECT SECTION 607.
- SHOWER COMPARTMENTS:** SHOWER COMPARTMENTS SHALL COMPLY WITH SECTION 608 OF THE 2012 TAS.
- GRAB BARS:** GRAB BARS IN TOILET FACILITIES AND BATHING FACILITIES SHALL COMPLY WITH SECTION 609 OF THE 2012 TAS.
- SEATS:** SEATS IN BATHTUBS AND SHOWER COMPARTMENTS SHALL COMPLY WITH SECTION 610 OF THE 2012 TAS.
- WASHING MACHINES AND CLOTHES DRYERS:** WASHING MACHINES AND CLOTHES DRYERS SHALL COMPLY WITH SECTION 611 OF THE 2012 TAS.
- SAUNAS AND STEAM ROOMS:** THERE ARE NO SAUNAS AND STEAM ROOMS ON THIS PROJECT SECTION 612.
- FIRE ALARM SYSTEMS:** THERE ARE NO FIRE ALARM SYSTEMS ON THIS PROJECT SECTION 702.

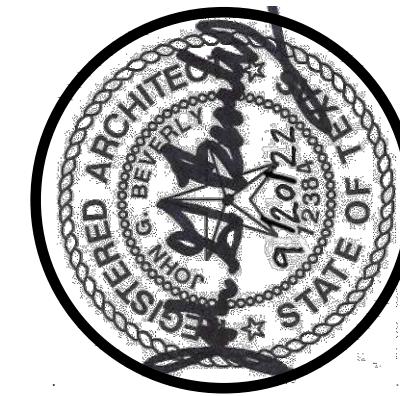




A FACILITY DESIGNED FOR
DUBLIN EMS
DUBLIN, TEXAS
JOHN G. BEVERLY • ARCHITECT
STEPHENVILLE, TEXAS 76401
john@jgbarch.com

DRAWINGS THIS SHEET:
22C10 3/31/22
DRAWN BY: J.G.B.
REvised: 9/20/22
ACCESSIBILITY NOTES
ACCESSIBILITY SCHEDULES

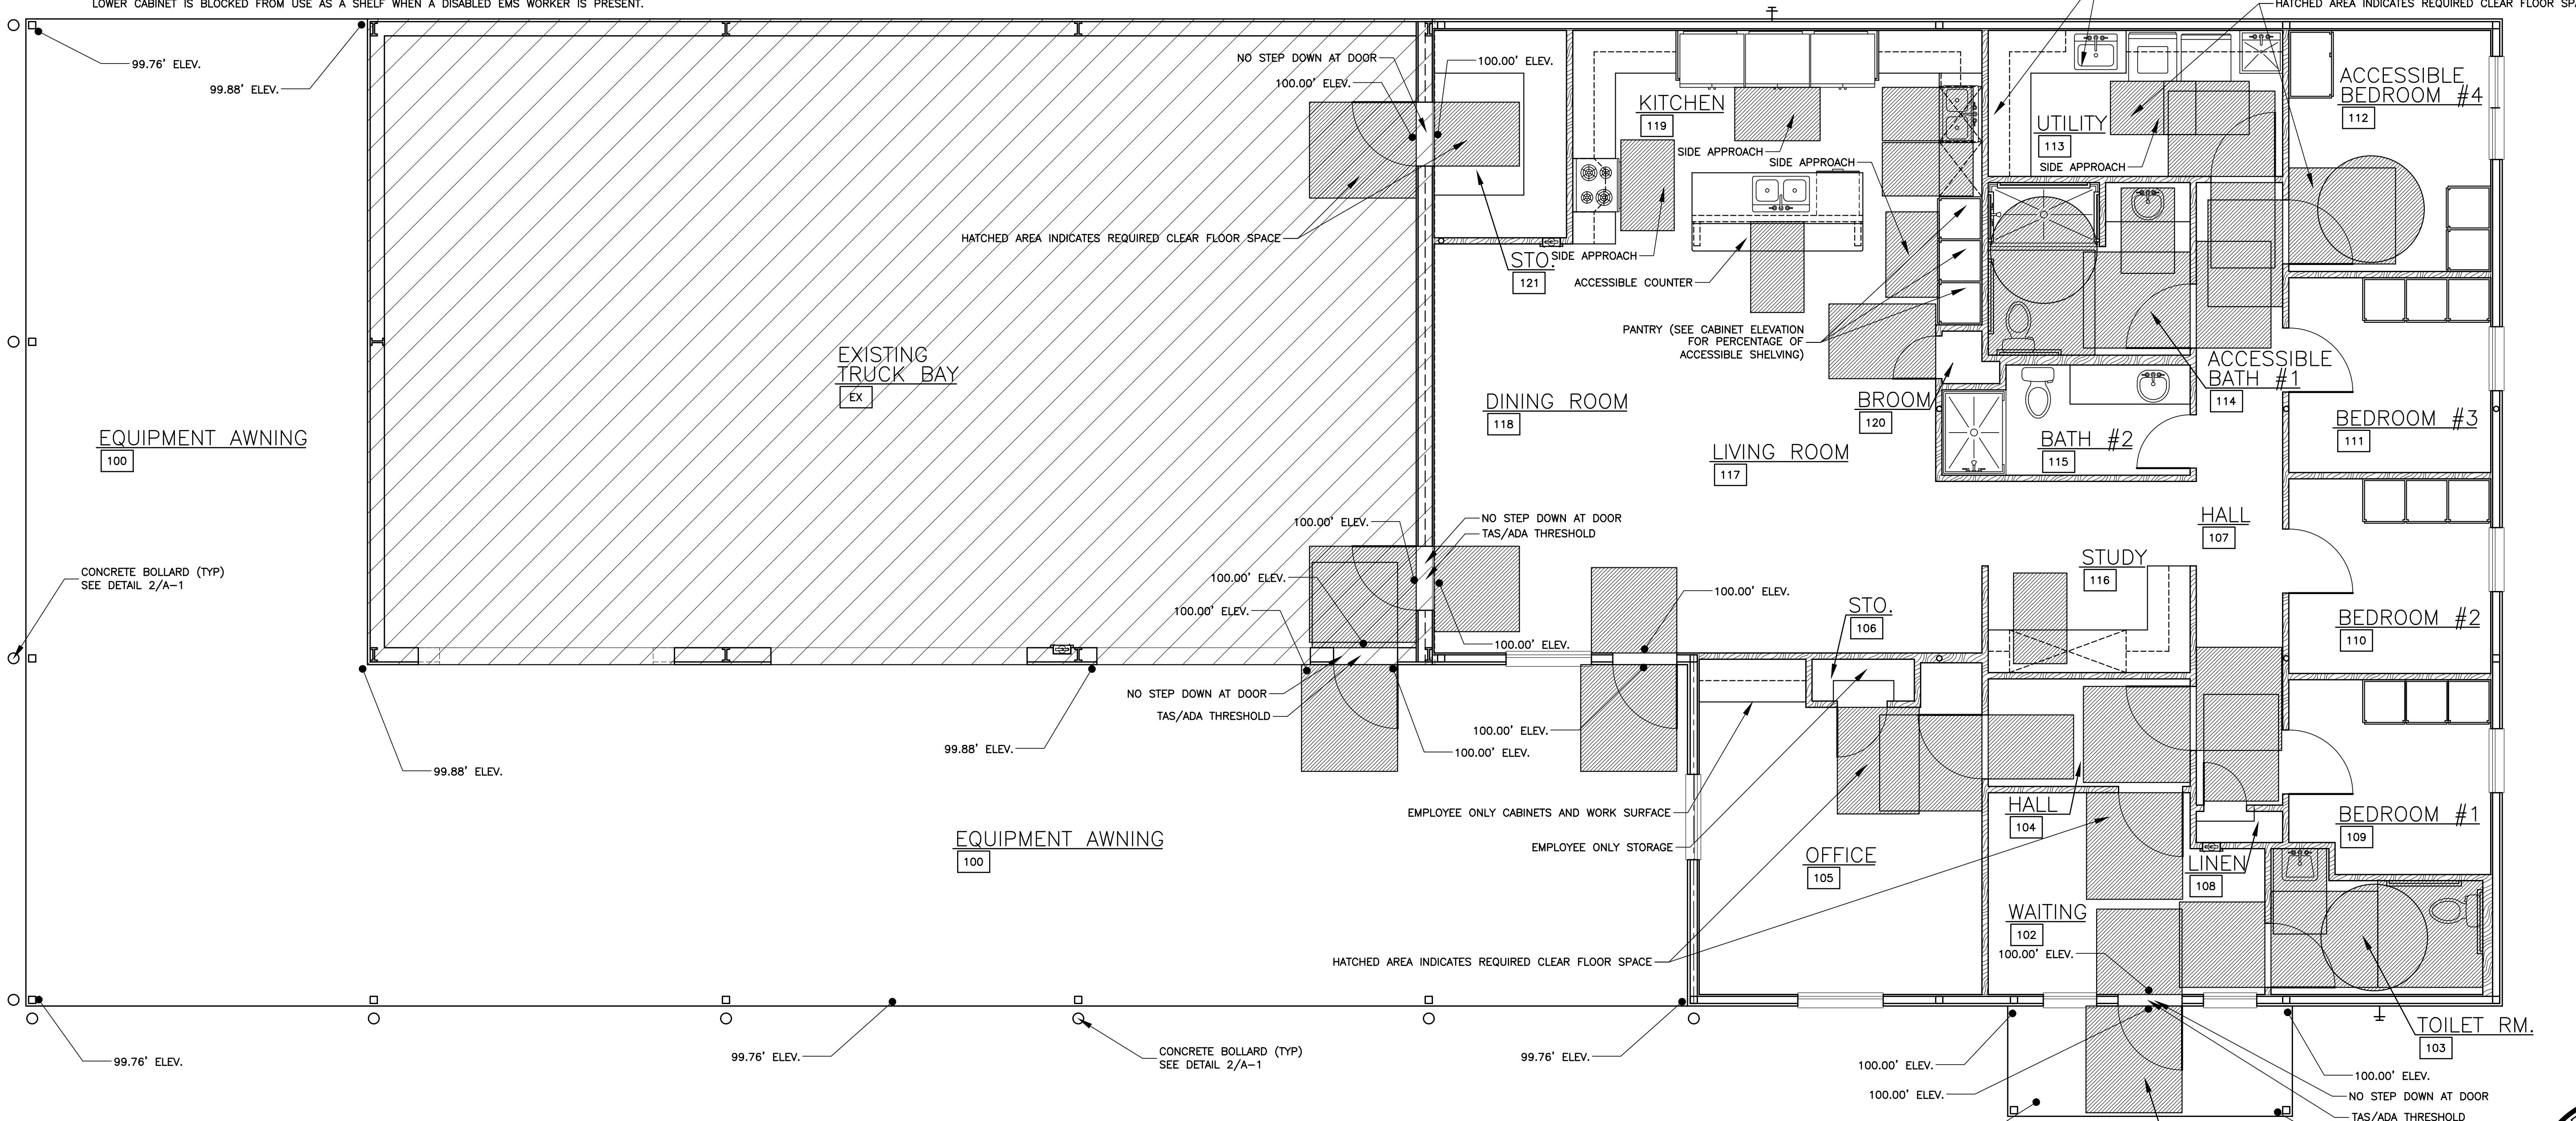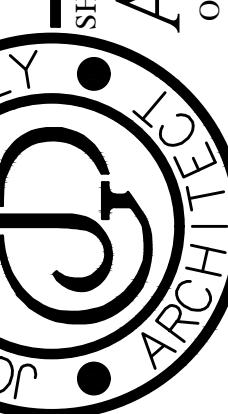

ACCESSIBILITY COMPLIANCE PLAN

SCALE: 1/4'=1'-0"

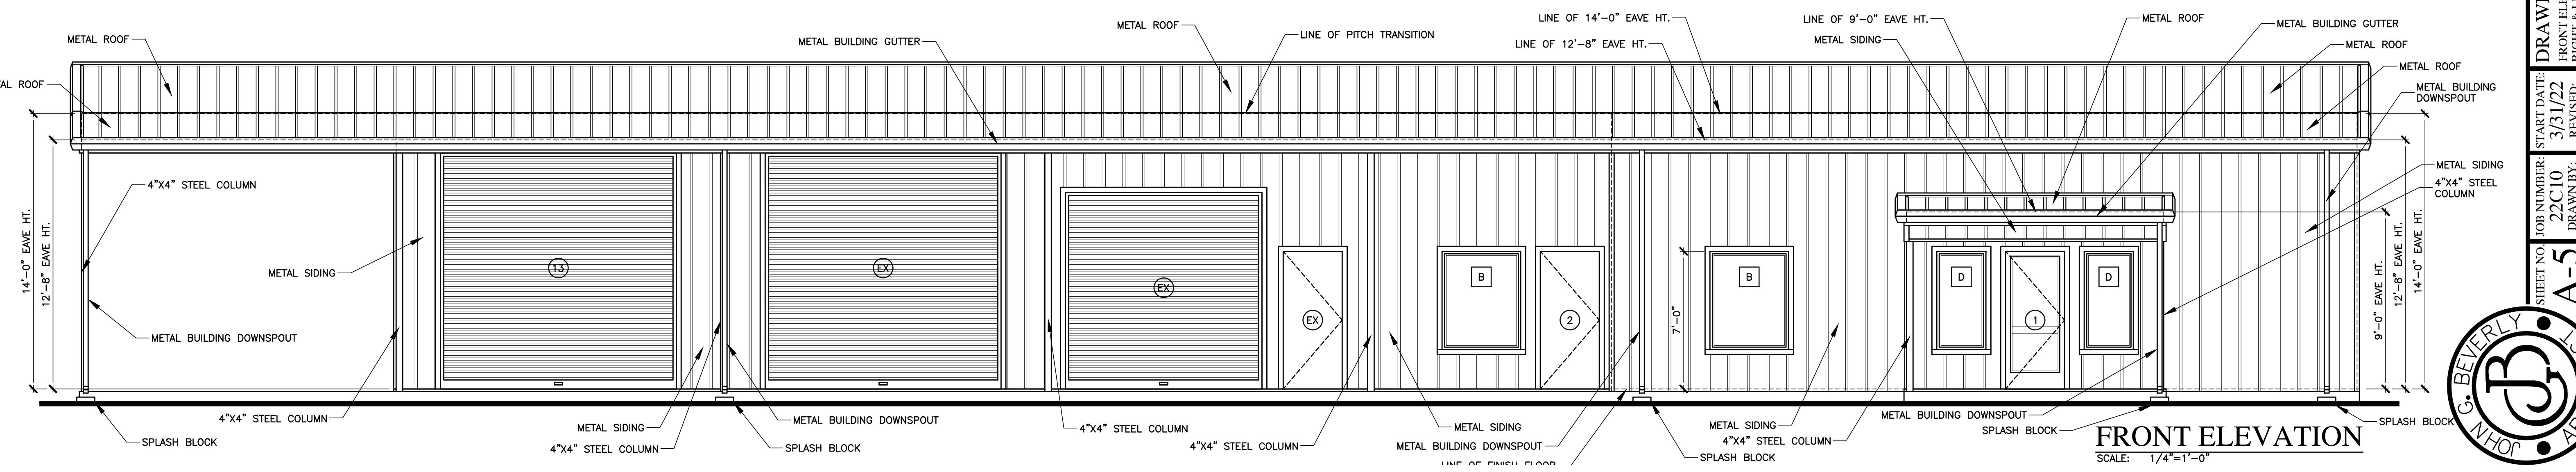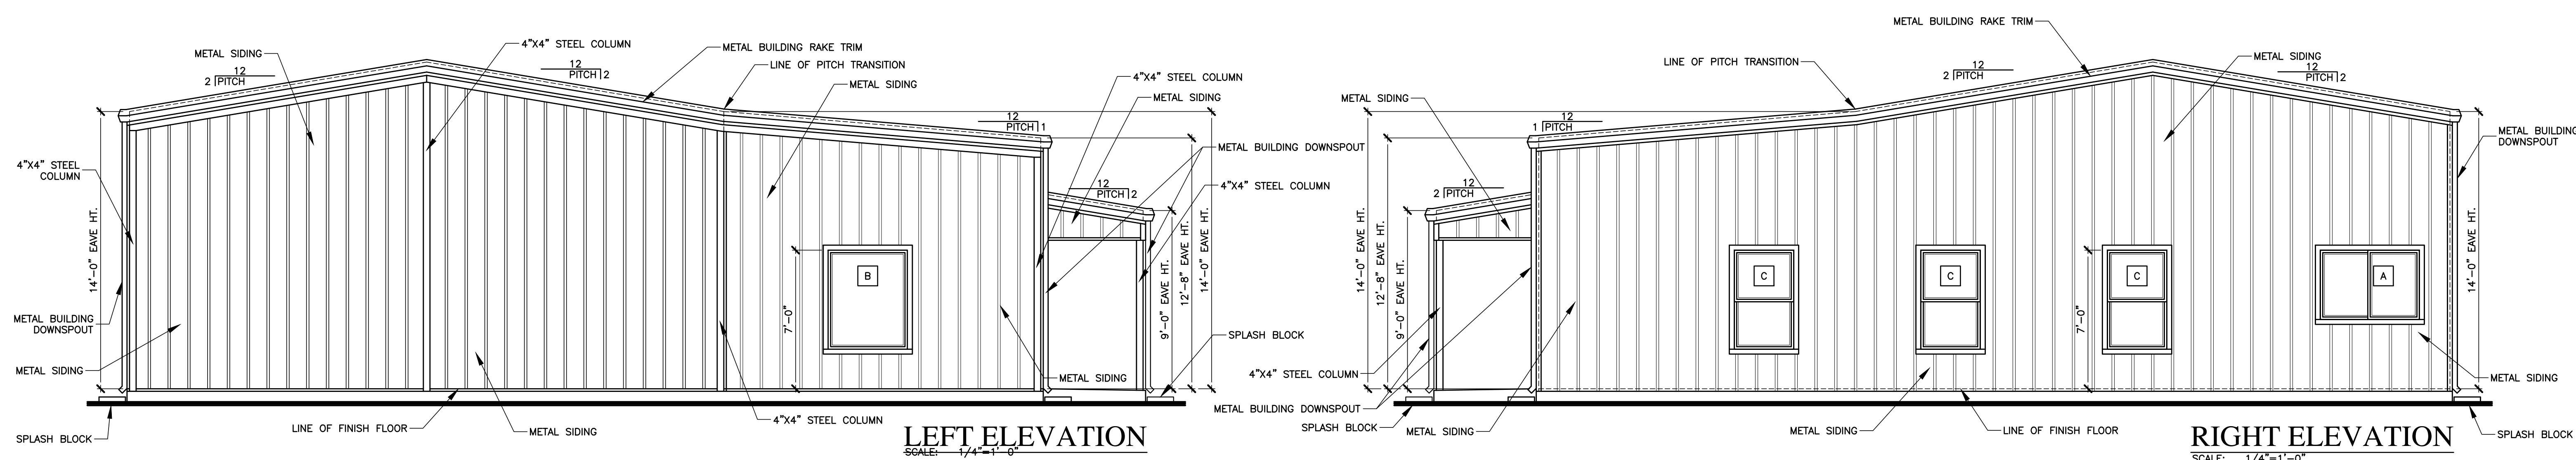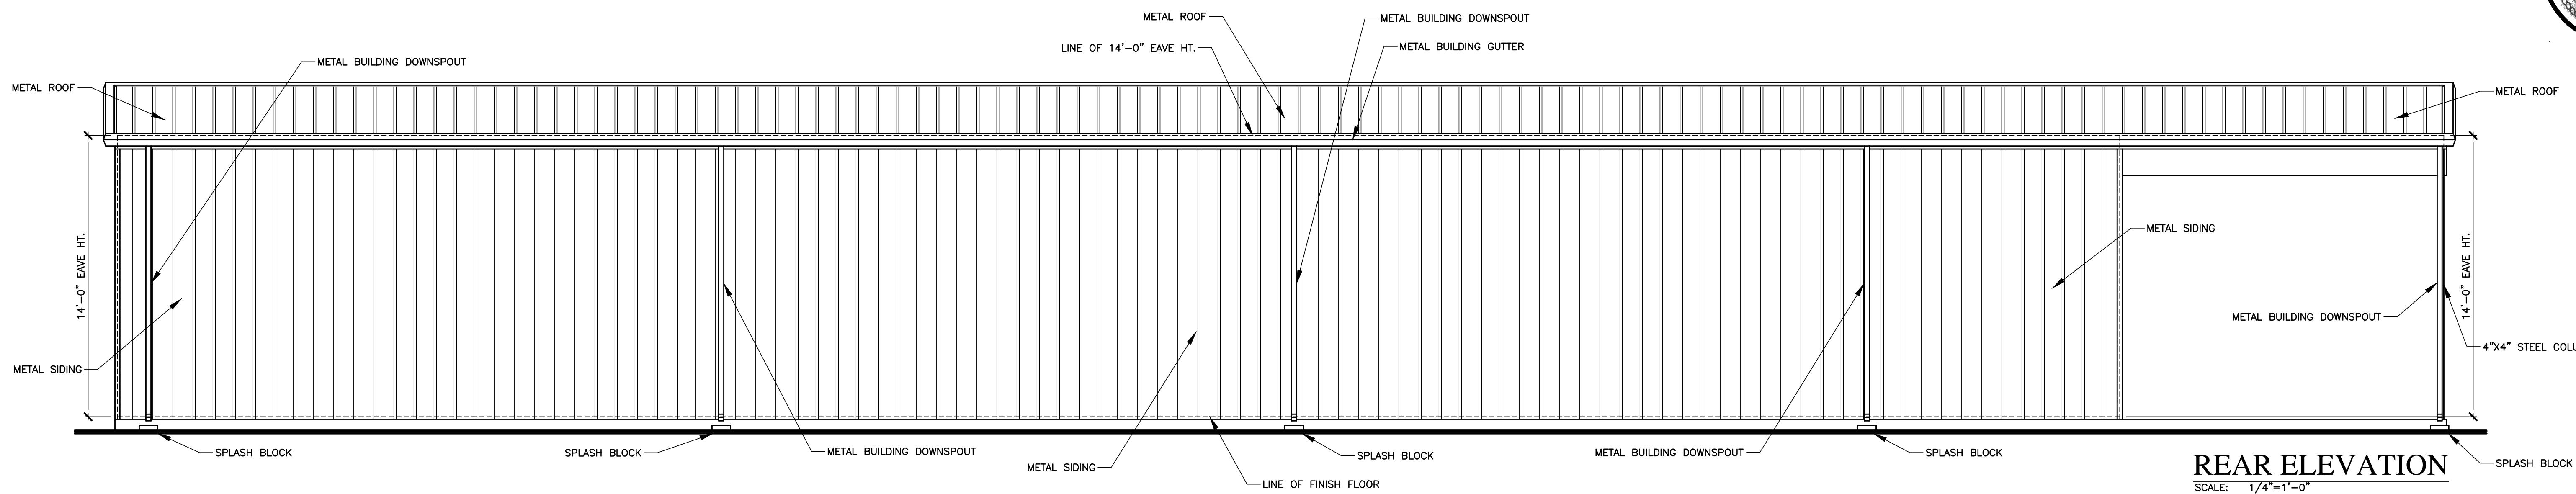

A FACILITY DESIGNED FOR
DUBLIN EMS
DUBLIN, TEXAS
john@gibarch.com

JOHN G. BEVERLY • ARCHITECT
STEPHENVILLE, TEXAS 76401
P.O. BOX 1990
(254) 396-9999 M.

DRAWINGS THIS SHEET:
FRONT ELEVATION
RIGHT & LEFT ELEVATIONS
REAR ELEVATION

SHEET NO. A-5
JOB NUMBER: 22C10
DRAWN BY: J.G.B.
REVISED: 9/20/22
O.F. -



A NEW FIRE STATION FOR THE CITY OF ASHFORD ASHFORD, ALABAMA

CODE INFORMATION

CODE REVIEW DATA

REQUIRED FIRE RATINGS FOR WALLS AND OPENINGS:
(PER FBC TABLE 601)

ELEMENT:

PRIMARY STRUCTURAL FRAME: 0 HOURS.

BEARING WALLS: EXTERIOR: 0 HOURS.
INTERIOR: 0 HOURS.

NONBEARING WALLS & PARTITIONS: EXTERIOR: SEE TABLE 602
INTERIOR: 0 HOURS.

FLOOR CONSTRUCTION AND ASSOCIATED SECONDARY MEMBERS:
0 HOURS.

ROOF CONSTRUCTION AND ASSOCIATED SECONDARY MEMBERS:
0 HOURS.

USE AND OCCUPANCY CLASSIFICATION:
IBC, BUSINESS GROUP B / STORAGE GROUP S-2 (2015 IBC-CHAPTER 3)

TYPES OF CONSTRUCTION:
IBC, TYPE V, (B) UNPROTECTED (2015 IBC-CHAPTER 5 & 6)

AUTOMATIC SPRINKLER SYSTEM:
NON-SPRINKLERED - ENTIRE BUILDING

MAXIMUM TRAVEL TO EXIT (NON-SPRINKLERED): TABLE 1006.2.1 & 1017.2 (2015 IBC)
COMMON PATH OF TRAVEL - 75

MAXIMUM TRAVEL DISTANCE TO EXIT - 200'

BUSINESS B: REQUIRED PER TABLE 2902.1 OF THE 2015 IBC

WATER CLOSETS		LAVATORIES		WATER FOUNTAINS	OTHER
MALE	FEMALE	MALE	FEMALE	1 PER 100	SERVICE SINK
1 PER 25 FOR THE FIRST 50		1 PER 40 FOR THE 1ST 80		= 1	(S.S.)
= 1		= 1			1
TOTAL PROVIDED:					
WATER CLOSETS		LAVATORIES		WATER FOUNTAINS	
2		2		2	
SERVICE SINK 1					

GENERAL NOTES

- APPLICABLE CODES:
 - 2015 INTERNATIONAL BUILDING CODE
 - 2015 INTERNATIONAL PLUMBING CODE
 - 2015 INTERNATIONAL MECHANICAL CODE
 - 2015 INTERNATIONAL FUEL GAS CODE
 - 2015 INTERNATIONAL FIRE CODE
 - 2014 INTERNATIONAL ELECTRIC CODE
 - THE 2010 ADA STANDARDS FOR ACCESSIBLE DESIGN
 - LOCAL BUILDING OFFICIALS REQUIREMENTS
 - LOCAL AND STATE HEALTH DEPARTMENT REGULATIONS
 - LOCAL ENGINEERING DEPARTMENT REGULATIONS AND REQUIREMENTS
- CODES REFERENCE A MINIMUM STANDARD OF WORK TO BE ACHIEVED. IN ALL CASES, THE MOST RESTRICTIVE REQUIREMENTS OF NATIONAL CODES, LOCAL CODES, OR THE CONSTRUCTION DOCUMENTS SHALL PREVAIL.
- PERMITS AND LICENSES: AS REQUIRED FOR THE WORK, THE CONTRACTOR SHALL OBTAIN ALL NECESSARY PERMITS AND/OR LICENSES FROM ALL GOVERNING AGENCIES.
- DEFINITIONS:
 - FURNISH: SUPPLY AND DELIVER TO PROJECT SITE, READY FOR INSPECTION.
 - INSTALL: PLACE IN POSITION FOR SERVICE OR USE.
 - PROVIDE: FURNISH AND INSTALL, COMPLETE AND READY FOR INTENDED USE.
- ALL WORK SHALL COMPLY WITH "EXECUTION REQUIREMENTS" IN THE CONSTRUCTION SPECIFICATIONS.
- ALL WORK SHALL COMPLY WITH "CUTTING AND PATCHING" IN THE CONSTRUCTION SPECIFICATIONS.
- TEMPORARY FACILITIES: PROVIDE FACILITIES AS CALLED FOR IN "TEMPORARY FACILITIES AND CONTROLS" IN THE CONSTRUCTION FACILITIES.
- COORDINATION OF THE WORK: COMPLY WITH "PROJECT MANAGEMENT AND COORDINATION" AND "EXECUTION REQUIREMENTS" IN THE CONSTRUCTION SPECIFICATIONS.
- SCHEDULE DISRUPTION OF UTILITY SERVICES TO THE SITE AND SURROUNDING AREAS WITH THE OWNER AT LEAST ONE WEEK IN ADVANCE.
- ALL FINISHES ARE TO BE SELECTED BY THE ARCHITECT. FURNISH ALL MANUFACTURER'S STANDARD RANGES OF COLORS, FINISHES, AND LUSTERS TO THE ARCHITECT FOR REVIEW, SELECTION, AND APPROVAL. SEE "SUBMITTAL PROCEDURES" IN THE CONSTRUCTION SPECIFICATIONS FOR ADDITIONAL INFORMATION.
- PROJECT CONDITIONS, INCLUDING DIMENSIONAL INFORMATION AND QUALITY CONDITIONS, SHALL BE VERIFIED AT THE SITE PRIOR TO BIDDING AND PERFORMING THE WORK. NOTIFY THE ARCHITECT OF ALL DISCOVERED DISCREPANCIES BEFORE BIDDING THE WORK, ORDERING MATERIALS, OR PERFORMING THE WORK.

SHEET INDEX

GENERAL

G1.1 TITLE SHEET

CIVIL

- COVER SHEET / INDEX
- GENERAL NOTES
- EXISTING CONDITIONS / DEMO PLAN
- AYOUT PLAN
- GRADING PLAN
- EROSION CONTROL PLAN
- UTILITIES PLAN
- MISC. CONSTRUCTION DETAILS
- MISC. CONSTRUCTION DETAILS

STRUCTURAL

- GENERAL NOTES & DETAILS
- FOUNDATION PLAN

ARCHITECTURE

- FLOOR PLAN, DOOR, FINISH SCHEDULES & DETAILS
- REFLECTED CEILING AND ROOF PLANS
- EXTERIOR ELEVATIONS AND SECTIONS
- BUILDING SECTION
- INTERIOR ELEVATIONS AND SECTIONS

PLUMBING

- PLUMBING PLAN - WASTE
- PLUMBING PLAN - WATER & GAS
- SCHEDULES
- PLUMBING DETAILS
- WASTE & VENT RISER DIAGRAM

MECHANICAL

- HVAC PLAN
- HVAC DETAILS
- HVAC SCHEDULES

ELECTRICAL

- ELECTRICAL LEGEND, NOTES & DETAILS
- POWER RISER DIAGRAM & SCHEDULES
- POWER & SIGNAL PLAN
- LIGHTING PLAN
- ELECTRICAL SITE PLAN

architecture

jml

J MICHAEL LEE ASSOCIATES
ARCHITECTURE
179 Honeysuckle Road, Suite 1
Dothan, Alabama 36305
334.792.4726

CONSULTANTS



A NEW FIRE STATION
FOR THE
CITY OF ASHFORD
ASHFORD, ALABAMA

OWNER:

CITY OF ASHFORD
525 N BROADWAY STREET
ASHFORD, ALABAMA 36312

ISSUE: APRIL 19, 2022
MARK DATE DESCRIPTION

PROJECT NO: 21-20
DRAWN BY: JAMEY AVERY
CHECKED BY: CHAD BROWN
SHEET TITLE

TITLE SHEET

G1.1
SHEET 1 OF 1


S I T E C O N S T R U C T I O N P L A N S
F O R

ASHFORD FIRE STATION

U. S. H W Y . 8 4 E A S T
ASHFORD, ALABAMA

APRIL, 2022

PROJECT LOCATION

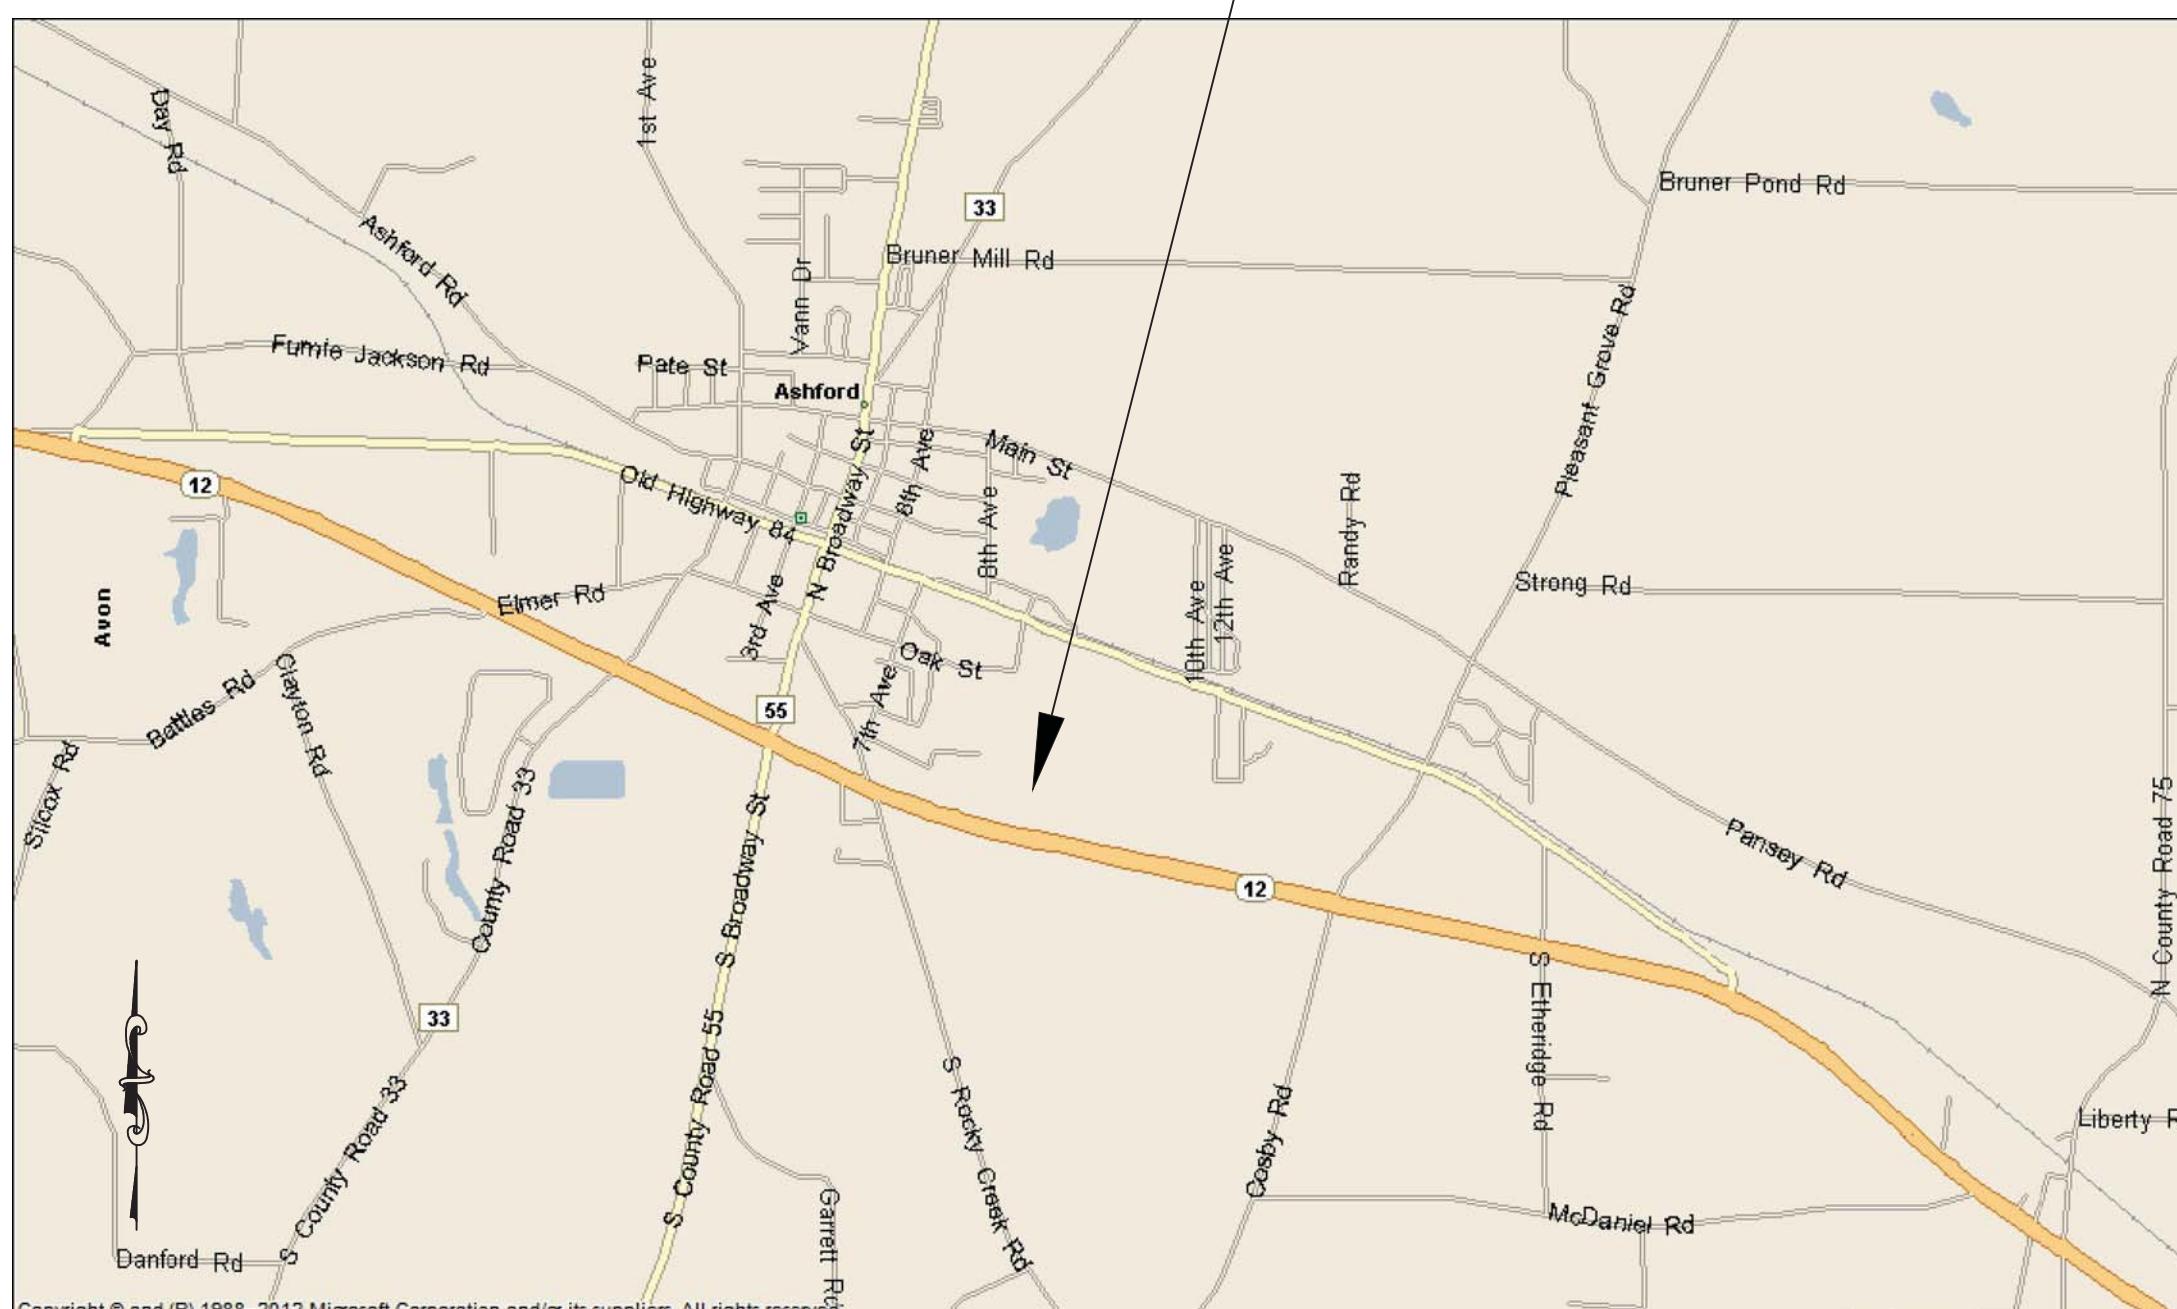

VICINITY MAP

NOT TO SCALE

INDEX TO SHEETS

COVER SHEET/INDEX	1
GENERAL NOTES	2
EXISTING CONDITIONS/DEMO PLAN	3
LAYOUT PLAN	4
GRADING PLAN	5
EROSION CONTROL PLAN	6
UTILITIES PLAN	7
MISC. CONSTRUCTION DETAILS	8-9

OWNER/DEVELOPER:

CITY OF ASHFORD
525 N. BROADWAY ST.
ASHFORD, AL. 36312

NES PROJECT NO. 40-2107



(P)334.673.9895 (F)334.673.1846
2431 Hartford Hwy Dothan, AL. 36305
web: www.northstarengineering.com



GENERAL NOTES

- Existing conditions and utilities shown are from field observations at the time of survey and available records. No guarantee is made that other underground utilities do not exist.
- The Contractor shall be responsible for contacting the appropriate municipal authorities and utility companies to obtain their assistance in locating underground utilities. The Contractor shall be responsible for the protection of all utilities throughout the construction period. The costs for repairing utilities damaged by construction activities shall be the responsibility of the Contractor.
- The Contractor shall comply with local, state, and federal regulations. An NPDES permit will be obtained by the owner. The contractor is responsible for the inspections, testing, etc. AS REQUIRED by the NPDES permit. The contractor shall employ a QCP or QCI AS REQUIRED by the permit. Other permits or licenses required for the construction activities shall be responsibility of the contractor.
- The Contractor shall be responsible for construction stake out and field engineering.
- The Contractor shall protect existing control points and benchmarks, whether public or private. The owners of control points and benchmarks that will be disturbed by construction activities shall be contacted prior to disturbance of the markers.
- Traffic control devices shall be installed and maintained in accordance with Alabama Department of Transportation specifications and the "Manual on Uniform Traffic Control Devices."
- The Contractor shall be responsible for the repair of any roadways or haul routes damaged by construction operations.
- Prior to beginning earthwork operations, the site grading area shall be cleared and grubbed and stripped of topsoil. Topsoil shall be stockpiled on site to be reused in landscaped areas, and/or areas outside pavements and building structures.
- Debris from clearing and grubbing operations shall be removed from the project site and legally disposed of by the Contractor. Burning on site will not be allowed.
- REFERENCE THE REPORT OF GEOTECHNICAL SUBSURFACE INVESTIGATION No. G22-6412 DATED FEBRUARY 26, 2022, BY CARMICHAEL ENGINEERING REGARDING UNDERCUTTING OF WEAK SURFACE SOILS IN THE PLANNED BUILDING AREAS. THE CONTRACTOR SHALL ADHERE TO THE GEOTECHNICAL REPORT FOR SOIL PREPARATION IN ALL BUILDING AND PAVEMENT AREAS.
- All debris and organic materials shall be removed from areas receiving fill and the owner's engineer shall be notified before beginning any backfill operations. An inspection shall be performed to determine stability of existing material. Should un-suitable material be encountered, the contractor shall remove same, at the direction of the engineer, and replace with embankment material. Fill material shall be suitable on-site material or a sand-clay mixture suitable for structural fill. Embankment fill shall be accomplished in lifts of 8 inch maximum compacted thickness. Each lift shall be compacted to a minimum of 98% Standard Proctor Density (ASTM D 698). The top 6" layer of fill in pavement and building areas, and the top 6" of sub-grade in cut areas shall be processed and compacted to 100% Standard Proctor Density (ASTM D 698). Embankment fill is any fill placed to obtain finish sub-grade elevation.
- The Contractor shall employ an independent testing laboratory approved by the owner with recommendation of the Engineer to perform density tests. Testing will be required as follows:
 - test every 200 L.F. for trenches per lift underneath paving.
 - test every 700 S.Y. per lift of subgrade, base and asphalt processed or placed.
 - There shall be no subsequent layers placed before the underlying layer has all passing density tests.
 Test locations shall be approved by the Engineer.
- Concrete shall develop a minimum 28-day compressive strength of 3,000 psi.
- Subgrade, base, paving, and pavement markings shall be constructed in accordance with Alabama Department of Transportation specifications as referenced.
- Pipe bedding and installation shall be in accordance with the minimum recommendations of the supplier. Pipe trenches shall be backfilled and properly compacted so that excessive trench settlement does not occur. Storm Drainage Pipe beneath roadways & paved areas shall be Class III Reinforced Concrete Pipe.
- The Contractor shall be responsible for compliance with all OSHA guidelines and regulations. The use of a trench box may be required where space for trench side slopes is limited. If a trench box is used, the Contractor shall be responsible for providing a box which is properly designed for the protection of workers and property.
- The final grades of all appurtenances, i.e. manholes, valve boxes, cleanouts, etc., shall be adjusted to match final grades.
- The contractor is responsible for all drainage and erosion control during construction.
- The Developer shall be responsible for the relocation of any conflicting utilities within or related to the development of this property.
- It is the contractor's responsibility to restrict public access to this site during construction.
- In all landscaping areas adjacent to the building, the site contractor shall provide a minimum topsoil thickness of 2 feet between the building and curb.

EROSION & SEDIMENT CONTROL NOTES

- AN ADEM NPDES PERMIT FOR CONSTRUCTION ACTIVITIES SHALL BE OBTAINED BY THE OWNER PRIOR TO ANY CONSTRUCTION OR LAND DISTURBANCE.
- PRIOR TO ANY LAND DISTURBANCE, A COPY OF THE ADEM PERMIT AND RAIN GAUGE SHALL BE POSTED BY THE CONTRACTOR AT THE CONSTRUCTION ENTRANCE OR OUTSIDE THE TEMPORARY CONSTRUCTION OFFICE.
- A COPY OF THE CONSTRUCTION BEST MANAGEMENT PRACTICES PLAN (CBMPP) SHALL BE MAINTAINED ONSITE DURING NORMAL OPERATING HOURS WHEN LAND DISTURBING ACTIVITIES ARE OCCURRING.
- ALL EROSION AND SEDIMENT CONTROL PRACTICES ARE TO BE INSTALLED IN ACCORDANCE WITH THE ALABAMA HANDBOOK FOR EROSION CONTROL, SEDIMENT CONTROL, AND STORMWATER MANAGEMENT ON CONSTRUCTION SITES.
- SEDIMENT CONTROL DEVICES SHALL BE INSTALLED AT THE BEGINNING OF SITE GRADING AS SOON AS PRACTICAL. THESE DEVICES WILL REQUIRE PERIODIC MAINTENANCE AND REPAIR AND SHALL REMAIN IN PLACE AND FUNCTIONAL UNTIL SITE HAS BEEN ADEQUATELY STABILIZED WITH VEGETATION. THE EROSION AND SEDIMENT CONTROL MEASURES REPRESENTED IN THESE DRAWINGS SHALL BE CONSIDERED MINIMUM REQUIREMENTS, AND ADDITIONAL MEASURES COULD BE REQUIRED DEPENDING ON SITE CONDITIONS, WEATHER, CONSTRUCTION METHODS, ETC...
- EACH DAY THERE IS ACTIVITY AT THE SITE, THE CONTRACTOR SHALL VISUALLY INSPECT THE TEMPORARY SEDIMENT CONTROL DEVICES AND SHALL MAINTAIN A LOG OF ALL DAILY INSPECTIONS AND NOTE ANY BMP DEFICIENCIES OBSERVED.
- CONTRACTOR SHALL MAINTAIN A LOG OF ALL RAINFALL MEASUREMENTS DURING CONSTRUCTION.
- SITE INSPECTIONS SHALL BE PERFORMED BY A QUALIFIED CREDENTIAL INSPECTOR (QCI), QUALIFIED CREDENTIALED PROFESSIONAL (QCP) OR QUALIFIED PERSON UNDER THE DIRECT SUPERVISION OF THE QCP. INSPECTIONS SHALL BE PERFORMED ONCE EACH MONTH OR AFTER ANY RAIN EVENT PRODUCING MORE THAN 3/4 INCHES OF RAIN WITHIN A 24 HOUR PERIOD. INSPECTIONS SHALL BE DONE NO LATER THAN 72-HOURS FOLLOWING THE RAIN EVENT. COPIES OF THE INSPECTION REPORTS SHALL BE KEPT ONSITE AT THE TEMPORARY CONSTRUCTION OFFICE AND SHALL BE AVAILABLE FOR REVIEW BY ADEM PERSONNEL.
- MODIFICATIONS OF THE EROSION AND SEDIMENT CONTROL PLAN CAN BE EXPECTED AS THE PROJECT IS CONSTRUCTED & ADDITIONAL MEASURES SHALL BE IDENTIFIED IF NEEDED AS A RESULT OF SITE INSPECTIONS.
- FOLLOW MANUFACTURER SPECIFICATIONS FOR INSTALLATION OF EROSION & SEDIMENT CONTROL DEVICES.
- MINIMIZE DISTURBANCE BY RESTRICTING CLEARING LIMITS TO NECESSARY CONSTRUCTION/GRADED AREAS ONLY.
- PROVIDE AND MAINTAIN A 25 FOOT NATURAL RIPARIAN BUFFER AROUND SURFACE WATERS.
- INSTALL 50'X20' (MINIMUM) GRAVEL PAD AT CONSTRUCTION ENTRANCE/EXIT TO REDUCE OFF-SITE VEHICLE TRACKING.
- INSTALL SILT FENCE AT TOE OF SLOPES ON PERIMETER OF CONSTRUCTION AREAS PRIOR TO EARTHWORK. REINFORCE WITH WIRE FENCE (TYPE "A") OR HAY BALES ON ALL SILT FENCING LOCATED BELOW SLOPES THAT HAVE ELEVATION DIFFERENCES GREATER THAN 10 FEET.
- PROVIDE INLET PROTECTION USING TYPE "A" SILT FENCE OR "SILT SAVER" DOMES FOR EXCAVATED DROP INLET PROTECTION. INSTALL BLOCK AND GRAVEL OR "SILT SAVER" CURB INLET PROTECTION AROUND EXISTING CURB INLETS. INLET PROTECTION SHALL BE ADEQUATELY MAINTAINED.
- ALL DISTURBED AREAS AND SLOPES NOT CURRENTLY UNDERGOING GRADED/CONSTRUCTION FOR A PERIOD GREATER THAN 13 DAYS SHALL BE STABILIZED WITH TEMPORARY OR PERMANENT VEGETATION. ALL DISTURBED AREAS THAT HAVE BEEN GRADED AND NOT RECEIVING PAVEMENT, LANDSCAPING, OR OTHER PERMANENT IMPROVEMENTS SHALL RECEIVE TOPSOIL AND SODDING.
- PROTECT ALL TREES THAT ARE NOT TO BE REMOVED FROM SITE. DO NOT PARK VEHICLES, CONSTRUCTION EQUIPMENT, OR STOCKPILE MATERIALS WITHIN DRIP LINE OF TREES.
- MINIMIZE THE GENERATION OF DUST THROUGH THE APPROPRIATE APPLICATION OF WATER OR OTHER DUST SUPPRESSION TECHNIQUES.
- WASTEWATER FROM WASHOUT OF CONCRETE TRUCKS OR EQUIPMENT SHALL BE PROPERLY MANAGED. A CONCRETE WASHOUT PIT SHALL BE CONSTRUCTED ONSITE AND ALL CONCRETE WASTE MATERIALS SHALL BE ADEQUATELY CONTAINED.
- ALL EROSION CONTROL MEASURES SHALL BE IN PLACE AS REQUIRED BY THE ENGINEER, PLANS AND CITY REPRESENTATIVE. SILT FENCING SHALL BE MEASURED AND DATED ON EACH RUN. AN INSPECTION LOG WILL BE REQUIRED TO BE SUBMITTED TO THE CITY. SEDIMENT CONTROL MEASURES SHALL BE INSPECTED AFTER EACH RAIN EVENT AND AT MINIMUM ONCE A MONTH. ANY DEFICIENCIES SHALL BE CORRECTED IMMEDIATELY AND NO FURTHER WORK WILL PROCEED UNTIL SAID DEFICIENCIES ARE CORRECTED AS PER THE CITY OR ENGINEER'S APPROVAL.
- ANY BMP DEFICIENCIES NOTED DURING INSPECTIONS SHALL BE CORRECTED WITHIN 5 DAYS OF THE INSPECTION UNLESS PREVENTED BY UNSAFE WEATHER CONDITIONS. IF UNSAFE WEATHER CONDITIONS ARE PRESENT, THEY SHOULD BE DOCUMENTED WITHIN THE DAILY INSPECTION LOG.
- THE CONTRACTOR SHALL PROMPTLY TAKE ALL STEPS TO REMOVE, TO THE MAXIMUM EXTENT PRACTICAL, SEDIMENT ACCUMULATIONS OR OTHER POLLUTANTS DEPOSITED OFFSITE OR IN ANY WATERBODY OR STORMWATER CONVEYANCE STRUCTURE.

PROJECT DEVELOPER/OWNER

CITY OF ASHFORD
525 N. BROADWAY ST.
ASHFORD, AL 36312

UTILITY OWNERS

WATER
CITY OF ASHFORD
518 BROADWAY ST.
ASHFORD, AL 36312
(334) 899-5171

ELECTRIC
ALABAMA POWER
518 BROADWAY ST.
ASHFORD, AL 36312
(334) 899-5171

GAS
SOUTHEAST GAS
2390 ROSS CLARK CIRCLE
DOOTHAN, AL 36301
(334) 794-0567

TELEPHONE & CABLE SERVICES

LUMEN (CENTURYLINK)
206 W. TROY ST.
DOOTHAN, AL 36305-4455
(334) 500-4010
CONTACT PERSON: CHRIS HAWK

TIME WARNER CABLE
104 SOUTH WOODBURN DRIVE
DOOTHAN, AL 36305
(334) 793-1752
CONTACT PERSON: WENDELL JONES

COMCAST
557 S. OATES ST.
DOOTHAN, AL 36301
(334) 794-3171

WOW!
1676 MONTGOMERY HIGHWAY
DOOTHAN, AL 36303
(334) 699-3333




TBM #1

A EXISTING IRON PIN (EIP)(POLY CA0018LS)
LOCATED AT THE NORTHWEST CORNER OF
THE PROPERTY
N = 245322.5660
E = 846202.8520
ELEV = 221.50

TBM #2

AN EXISTING IRON PIN (EIP)(POLY HAD 8842)
LOCATED AT THE SOUTHEAST CORNER OF THE
PROPERTY (AS SHOWN)
N = 244978.8010
E = 846620.5250
ELEV = 214.91

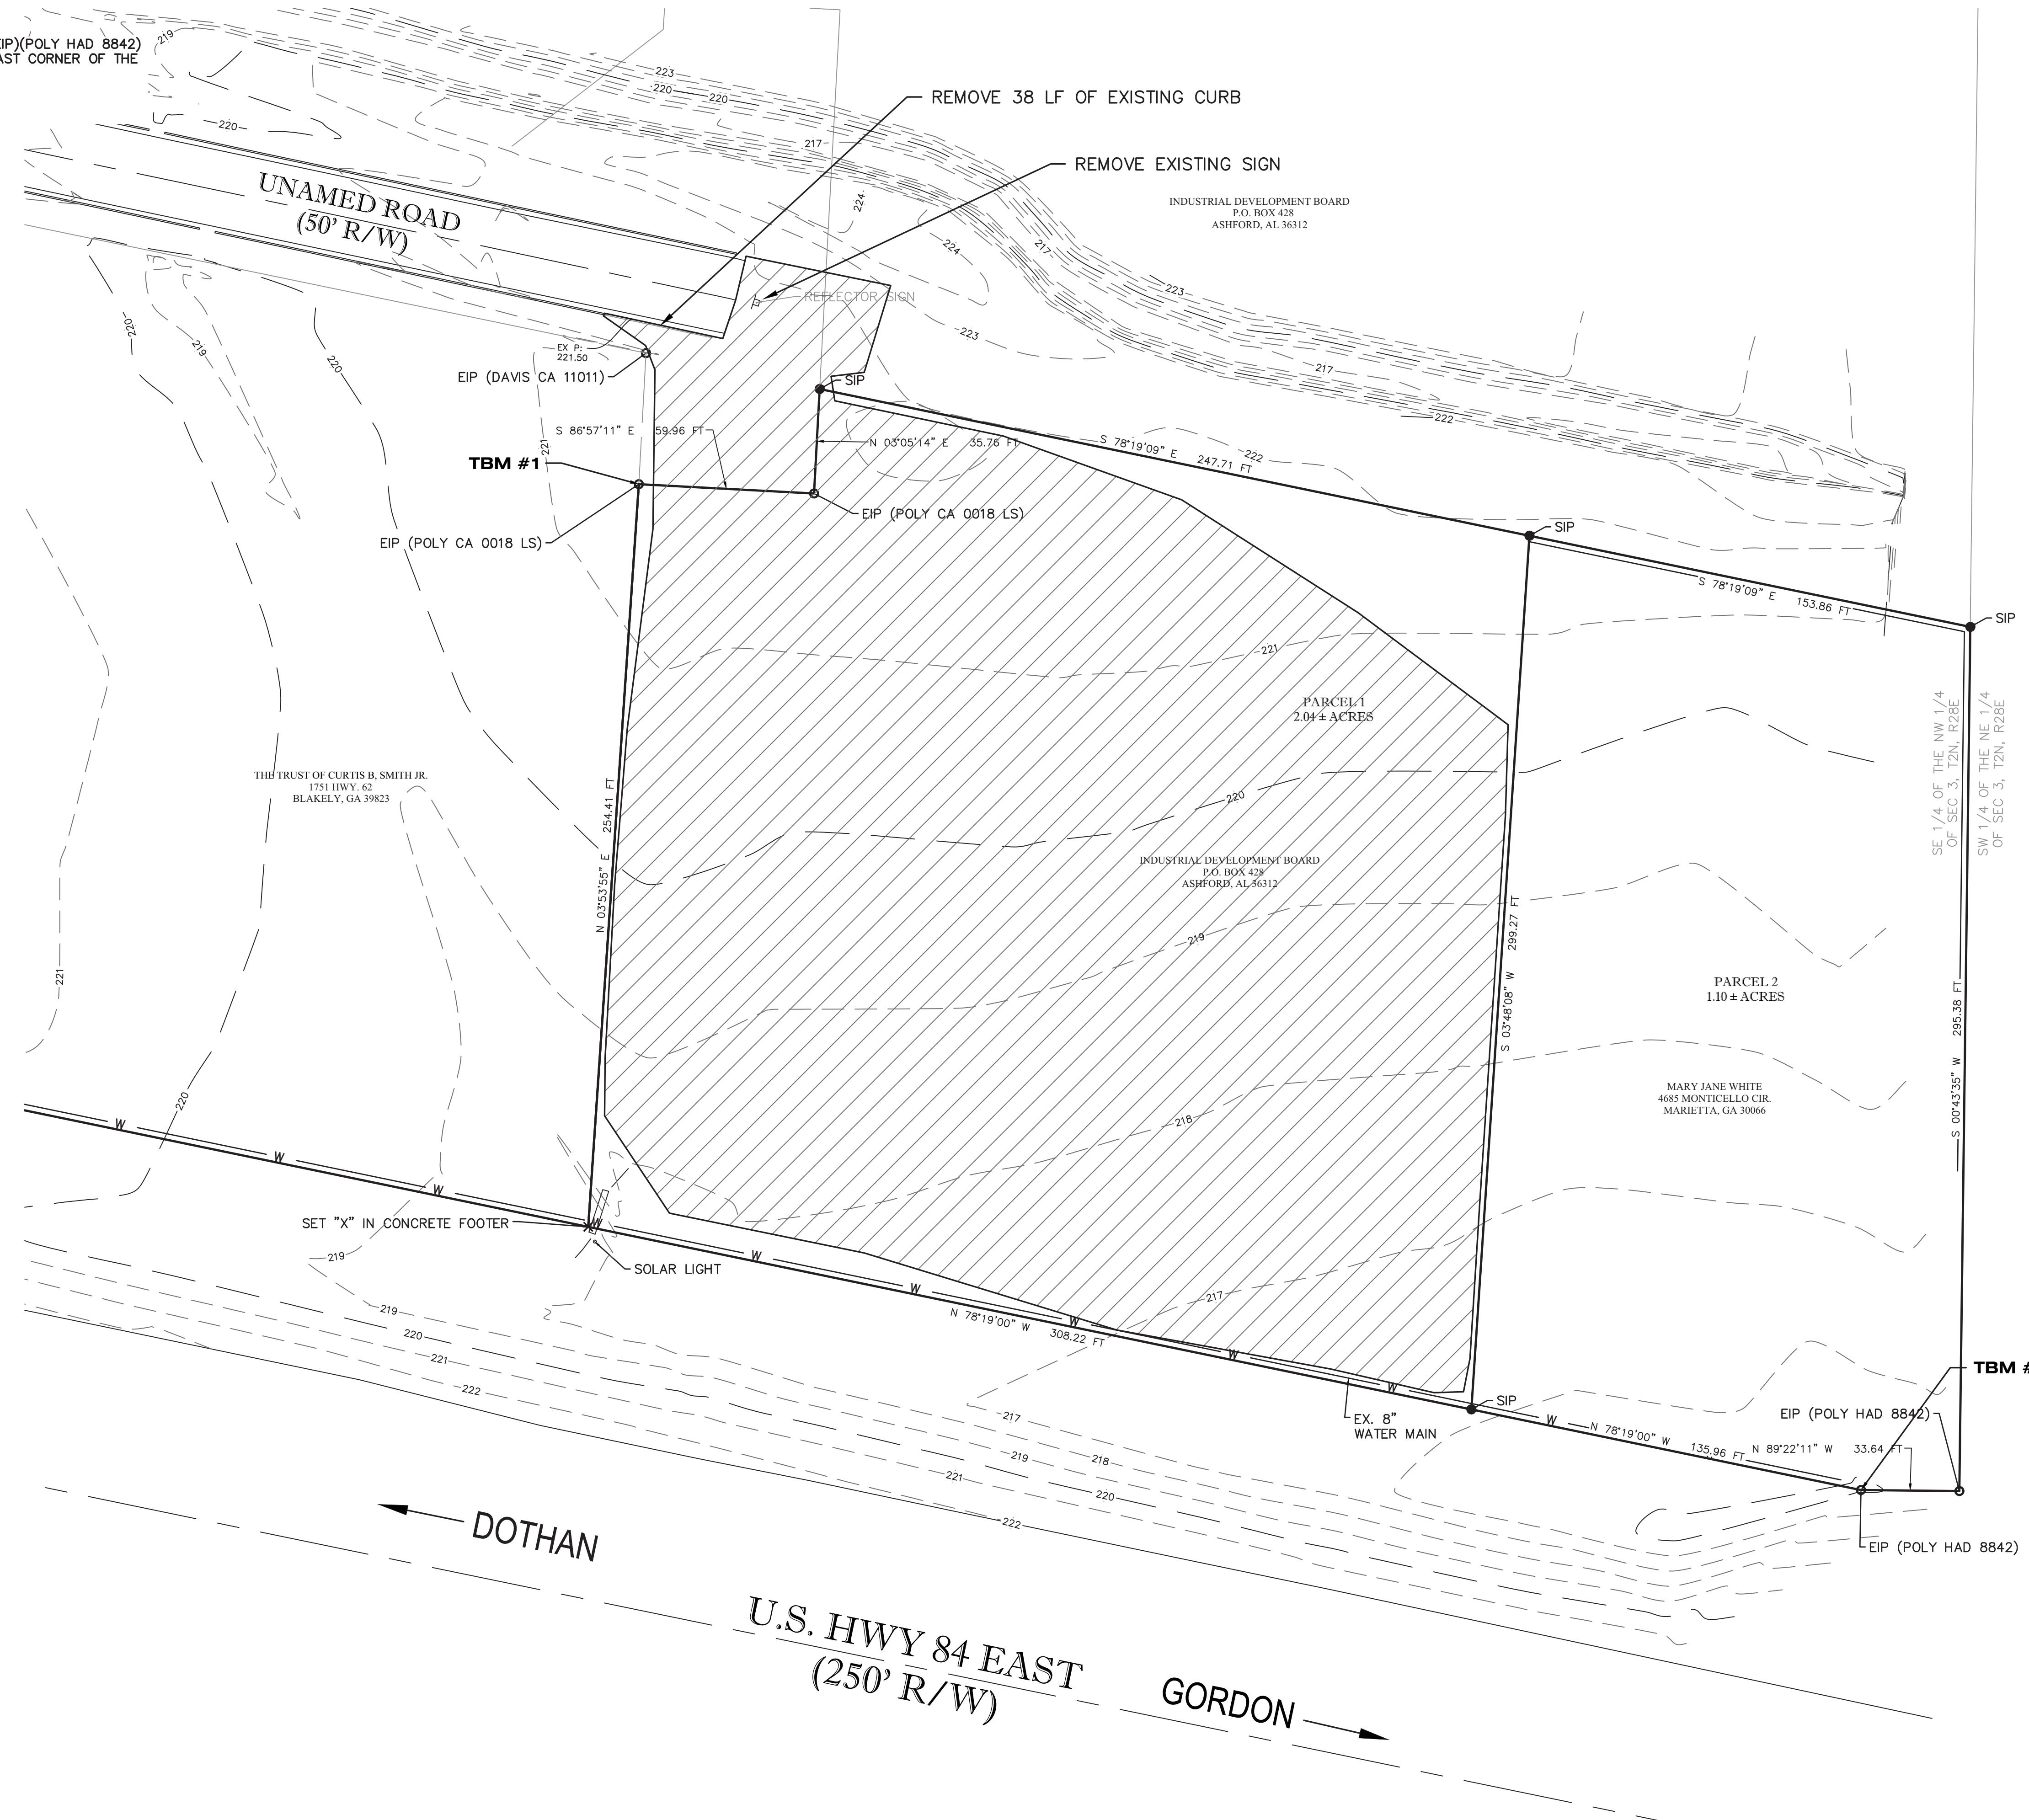

LEGEND

○	FIRE HYDRANT
PP ○	POWER POLE
LP ○	LIGHT POLE
WV	WATER VALVE
WM	WATER METER
GM	GAS METER
GV	GAS VALVE
○	SANITARY MANHOLE
□	TELEPHONE BOX
■	SIGN
ECM	EXISTING CONCRETE MONUMENT
EIP ○	EXISTING IRON PIN
■	MAILBOX
GW	GUYWIRE
●	CONTROL POINT
○	TELEPHONE RISER
○	CABLE RISER
R/W	RIGHT OF WAY
RCP	REINFORCED CONCRETE PIPE
●	PROPOSED FIRE HYDRANT
○	PROPOSED GATE VALVE
SCM ■	CONCRETE MONUMENT TO BE SET
SIP ●	IRON PIN TO BE SET
■	PROPOSED WATER METER
UT	UNDERGROUND TELEPHONE
OE — OE	OVERHEAD ELECTRIC
— SS —	EXIST. SANITARY SEWER LINE
— W — W	EXIST. WATER MAIN
— — — —	EXIST. STORM DRAIN LINE
— GAS —	EXIST. GAS MAIN
— X —	EXISTING FENCE
— 325 —	EXISTING CONTOUR
— 325 —	PROPOSED CONTOURS
PRO SS	PROPOSED SANITARY SEWER LINE
PRO W	PROPOSED WATER LINE
MBL — MBL	MINIMUM BUILDING LINE
— PROPERTY LINE	PROPERTY LINE
■	CLEARING, GRUBBING & GRADING AREA 1.05± ACRES

NOTES:

1. NO WORK SHALL BE DONE ON THE ALDOT RIGHT OF WAY WITHOUT AN APPROVED PERMIT AND DRAWINGS.
2. CONTRACTOR SHALL RETAIN AND PROTECT ALL EXISTING UTILITIES AND STORM DRAINAGE STRUCTURES UNLESS OTHERWISE NOTED.
3. INSTALL EROSION AND SEDIMENT CONTROL DEVICES AS SOON AS CLEARING AND GRUBBING OPERATIONS ARE BEGUN. SEE EROSION CONTROL PLAN. EROSION CONTROL MEASURES SHALL BE MAINTAINED AND PROTECTED DURING CONSTRUCTION.
4. CONTRACTOR SHALL ADHERE TO CLEARING AND GRUBBING LIMITS UNLESS OTHERWISE INSTRUCTED BY THE ENGINEER.
5. ALL DISTURBED AREAS SHALL BE GRASSED AND MULCHED IMMEDIATELY AFTER CONSTRUCTION IS COMPLETED. THE FINAL PAYMENT SHALL NOT BE RELEASED UNTIL ALL AREAS HAVE STAND OF PERMANENT GRASS.

NORTHSTAR
ENGINEERING SERVICES
(P)334-671-9895 (F)334-673-1846
2411 Hartford Hwy. Dothan, AL 36305
web: www.northstarengineering.com

AL CERT. OF AUTH.
CA-1896E, CA-0621LS
FL CERT. OF AUTH.
26312-E, 7858-S
GA CERT. OF AUTH.
003129
MS CERT. OF AUTH.
E-00001825

SHEET
OF
3
9

30 0 30 60 90
SCALE: 1" = 30'

SITE CONSTRUCTION PLANS FOR
ASHFORD FIRE STATION
CITY OF ASHFORD
HOUSTON COUNTY, ALABAMA
EX. CONDITIONS/DEMO. PLAN

PROJECT No.
40-2107
DATE: APRIL, 2022
SCALE: 1" = 30'
DRAWN BY:
M. AMAN
APPROVED BY:
P. SANTORA
REVISIONS:

TBM #1

A EXISTING IRON PIN (EIP)(POLY CA0018LS)
LOCATED AT THE NORTHWEST CORNER OF
THE PROPERTY
N = 245322.5660
E = 846202.8520
ELEV = 221.50

TBM #2

AN EXISTING IRON PIN (EIP)(POLY H
LOCATED AT THE SOUTHEAST CORNER
PROPERTY (AS SHOWN)
N = 244978.8010
E = 846620.5250
ELEV = 214.91

NO

NOTE:

1. THE BASE BID SHALL INCLUDE ALL SITE WORK AND CONCRETE PAVING AS SHOWN ON THE PLANS.
2. BIDDERS SHALL PROVIDE A DEDUCTIVE ALTERNATE FOR THE BUILDING PAD, COMPACTED BASE COURSE AND SUBGRADE.
3. BIDDERS SHALL PROVIDE A DEDUCTIVE ALTERNATE FOR THE 8" CONCRETE PAVEMENT AND COMPACTED BASE COURSE PER DETAIL.
4. THE HOUSTON COUNTY ROAD & BRIDGE DEPARTMENT SHALL PROVIDE THE CITY OF ASHFORD WITH A MATERIALS PRICE FOR INSTALLING THE BASE AND ASPHALT PAVING IN ACCORDANCE WITH THE ASPHALT PAVEMENT DETAIL SHOWN ON THE CONSTRUCTION PLANS AND THE CARMICHAEL ENGINEERING GEOTECHNICAL REPORT DATED FEBRUARY 26,2022. THE HOUSTON COUNTY ROAD & BRIDGE DEPARTMENT WILL PROVIDE LABOR FOR ALL GRADING, SAND CLAY BASE INSTALLATION (COMPACTED TO SPECIFICATIONS), AND ASPHALT PAVING INSTALLATION (PER SPECIFICATIONS FOR THICKNESS AND COMPACTION). THE HOUSTON COUNTY ROAD & BRIDGE DEPARTMENT WILL PROVIDE THE CITY OF ASHFORD WITH A MATERIAL COSTS QUOTE FOR APPROVAL PRIOR TO BEGINNING CONSTRUCTION ACTIVITIES.
5. THE HOUSTON COUNTY ROAD & BRIDGE WILL GRADE AND COMPACT THE BUILDING PAD TO FINISH FLOOR ELEVATION MINUS 4" FOR THE OFFICE PORTION OF THE BUILDING AND FINISH

NOTES:

1. NO WORK SHALL BE DONE ON THE ALDOT RIGHT OF WAY WITHOUT AN APPROVED PERMIT AND DRAWINGS.
2. CONTRACTOR SHALL RETAIN AND PROTECT ALL EXISTING UTILITIES AND STORM DRAINAGE STRUCTURES UNLESS OTHERWISE NOTED.
3. INSTALL EROSION AND SEDIMENT CONTROL DEVICES AS SOON AS CLEARING AND GRUBBING OPERATIONS ARE BEGUN. SEE EROSION CONTROL PLAN. EROSION CONTROL MEASURES SHALL BE MAINTAINED AND PROTECTED DURING CONSTRUCTION.
4. CONTRACTOR SHALL ADHERE TO CLEARING AND GRUBBING LIMITS UNLESS OTHERWISE INSTRUCTED BY THE ENGINEER.
5. ALL DISTURBED AREAS SHALL BE GRASSED AND MULCHED IMMEDIATELY AFTER CONSTRUCTION IS COMPLETED. THE FINAL PAYMENT SHALL NOT BE RELEASED UNTIL ALL AREAS HAVE A STAND OF PERMANENT GRASS.
6. DIMENSIONS SHOWN ARE TO THE FACE OF CURB, EDGE OF PAVEMENT, OUTSIDE EDGE OF BUILDING, OR PROPERTY LINE UNLESS OTHERWISE NOTED.
7. PRIOR TO ANY SITE WORK CONSTRUCTION, VERIFY THE BUILDING DIMENSIONS WITH THE ARCHITECTURAL DRAWINGS. COORDINATES PROVIDED ON "BUILDING CORNERS CHART" ARE FOR BUILDING PAD BUILD UP AND NOT INTENDED TO BE USED AS THE FOUNDATION STAKEOUT POINTS.
8. PRIOR TO SITE PAVING, COORDINATE THE PLACEMENT OF CONCRETE ELECTRICAL PADS, HVAC PADS, DUCTS, IRRIGATION CHASES, AND AREA LIGHTING WITH ARCHITECTURAL DRAWINGS AND THE OWNER.
9. ON SITE PAVEMENT MARKINGS SHALL BE CLASS I, TYPE "A" (REFLECTIVE PAINT) IN ACCORDANCE WITH ALABAMA DEPARTMENT OF TRANSPORTATION SPECIFICATIONS. PAVEMENT MARKINGS ON U.S. HWY 231 RIGHT OF WAY SHALL BE CLASS 2, TYPE "A" (REFLECTIVE THERMOPLASTIC) IN ACCORDANCE WITH ALABAMA DEPARTMENT OF TRANSPORTATION SPECIFICATIONS. DIRECTIONAL ARROWS SHALL COMPLY WITH ALDOT SPECIAL DRAWING TCM-703.
10. PRIOR TO CONSTRUCTION THE CONTRACTOR SHALL FIELD VERIFY THE INVERTS OF ALL EXISTING SANITARY SEWER AND STORM SEWER STRUCTURES.
11. REFERENCE THE REPORT OF GEOTECHNICAL SUBSURFACE INVESTIGATION No. G22-6412 DATED FEBRUARY 26, 2022, BY CARMICHAEL ENGINEERING REGARDING UNDERCUTTING OF WEAK SURFACE SOILS IN THE PLANNED BUILDING AREAS. THE CONTRACTOR SHALL ADHERE TO THE GEOTECHNICAL REPORT FOR SOIL PREPARATION IN ALL BUILDING AND PAVEMENT AREAS.

PROJECT No.
40-2107

DATE: APRIL, 2022

SCALE: 1" = 30'


LEGEND

-○-	FIRE HYDRANT
PP -○-	POWER POLE
LP -○-	LIGHT POLE
WV ☒	WATER VALVE
WM 田	WATER METER
GM 田	GAS METER
GV ☒	GAS VALVE
(S)	SANITARY MANHOLE
□	TELEPHONE BOX
—	SIGN
ECM □	EXISTING CONCRETE MONUMENT
EIP ●	EXISTING IRON PIN
■	MAILBOX
GW ←	GUYWIRE
○	CONTROL POINT
①	TELEPHONE RISER
②	CABLE RISER
R/W	RIGHT OF WAY
RCP	REINFORCED CONCRETE PIPE
●	PROPOSED FIRE HYDRANT
⊗	PROPOSED GATE VALVE
SCM ■	CONCRETE MONUMENT TO BE SET
SIP ●	IRON PIN TO BE SET
W ■	PROPOSED WATER METER
UT ———	UNDERGROUND TELEPHONE
— OE ——	OVERHEAD ELECTRIC
— ss ——	EXIST. SANITARY SEWER LINE
— w ——	EXIST. WATER MAIN
— — —	EXIST. STORM DRAIN LINE
— GAS ——	EXIST. GAS MAIN
~~~~~	EXISTING TREE LINE
— x ——	EXISTING FENCE
— 325 — —	EXISTING CONTOUR
— 325 ——	PROPOSED CONTOURS
— PRO ss ——	PROPOSED SANITARY SEWER LINE
— PRO w ——	PROPOSED WATER LINE
— MBL ——	MINIMUM BUILDING LINE
—————	PROPERTY LINE
	PROPOSED CONCRETE SIDEWALK (SEE DETAIL)
	PROPOSED CONCRETE PAVING (SEE DETAIL)
	PROPOSED ASPHALT PAVING (SEE DETAIL)
0.00	PROPOSED SPOT ELEVATION P=PAVEMENT SW=SIDEWALK TC=TOP OF CURB

**THE CONSTRUCTION PLAN FOR  
ASHFORD FIRE STATION  
CITY OF ASHFORD  
HOUSTON COUNTY, ALABAMA  
GRADING PLAN**

AL CERT. OF AUTH.  
A-1896E, CA-0621LS  
FL CERT. OF AUTH.  
26312-E, 7858-S  
GA CERT. OF AUTH.  
003129  
MS CERT. OF AUTH.  
E-00001825

SHEET 5  
OF 9

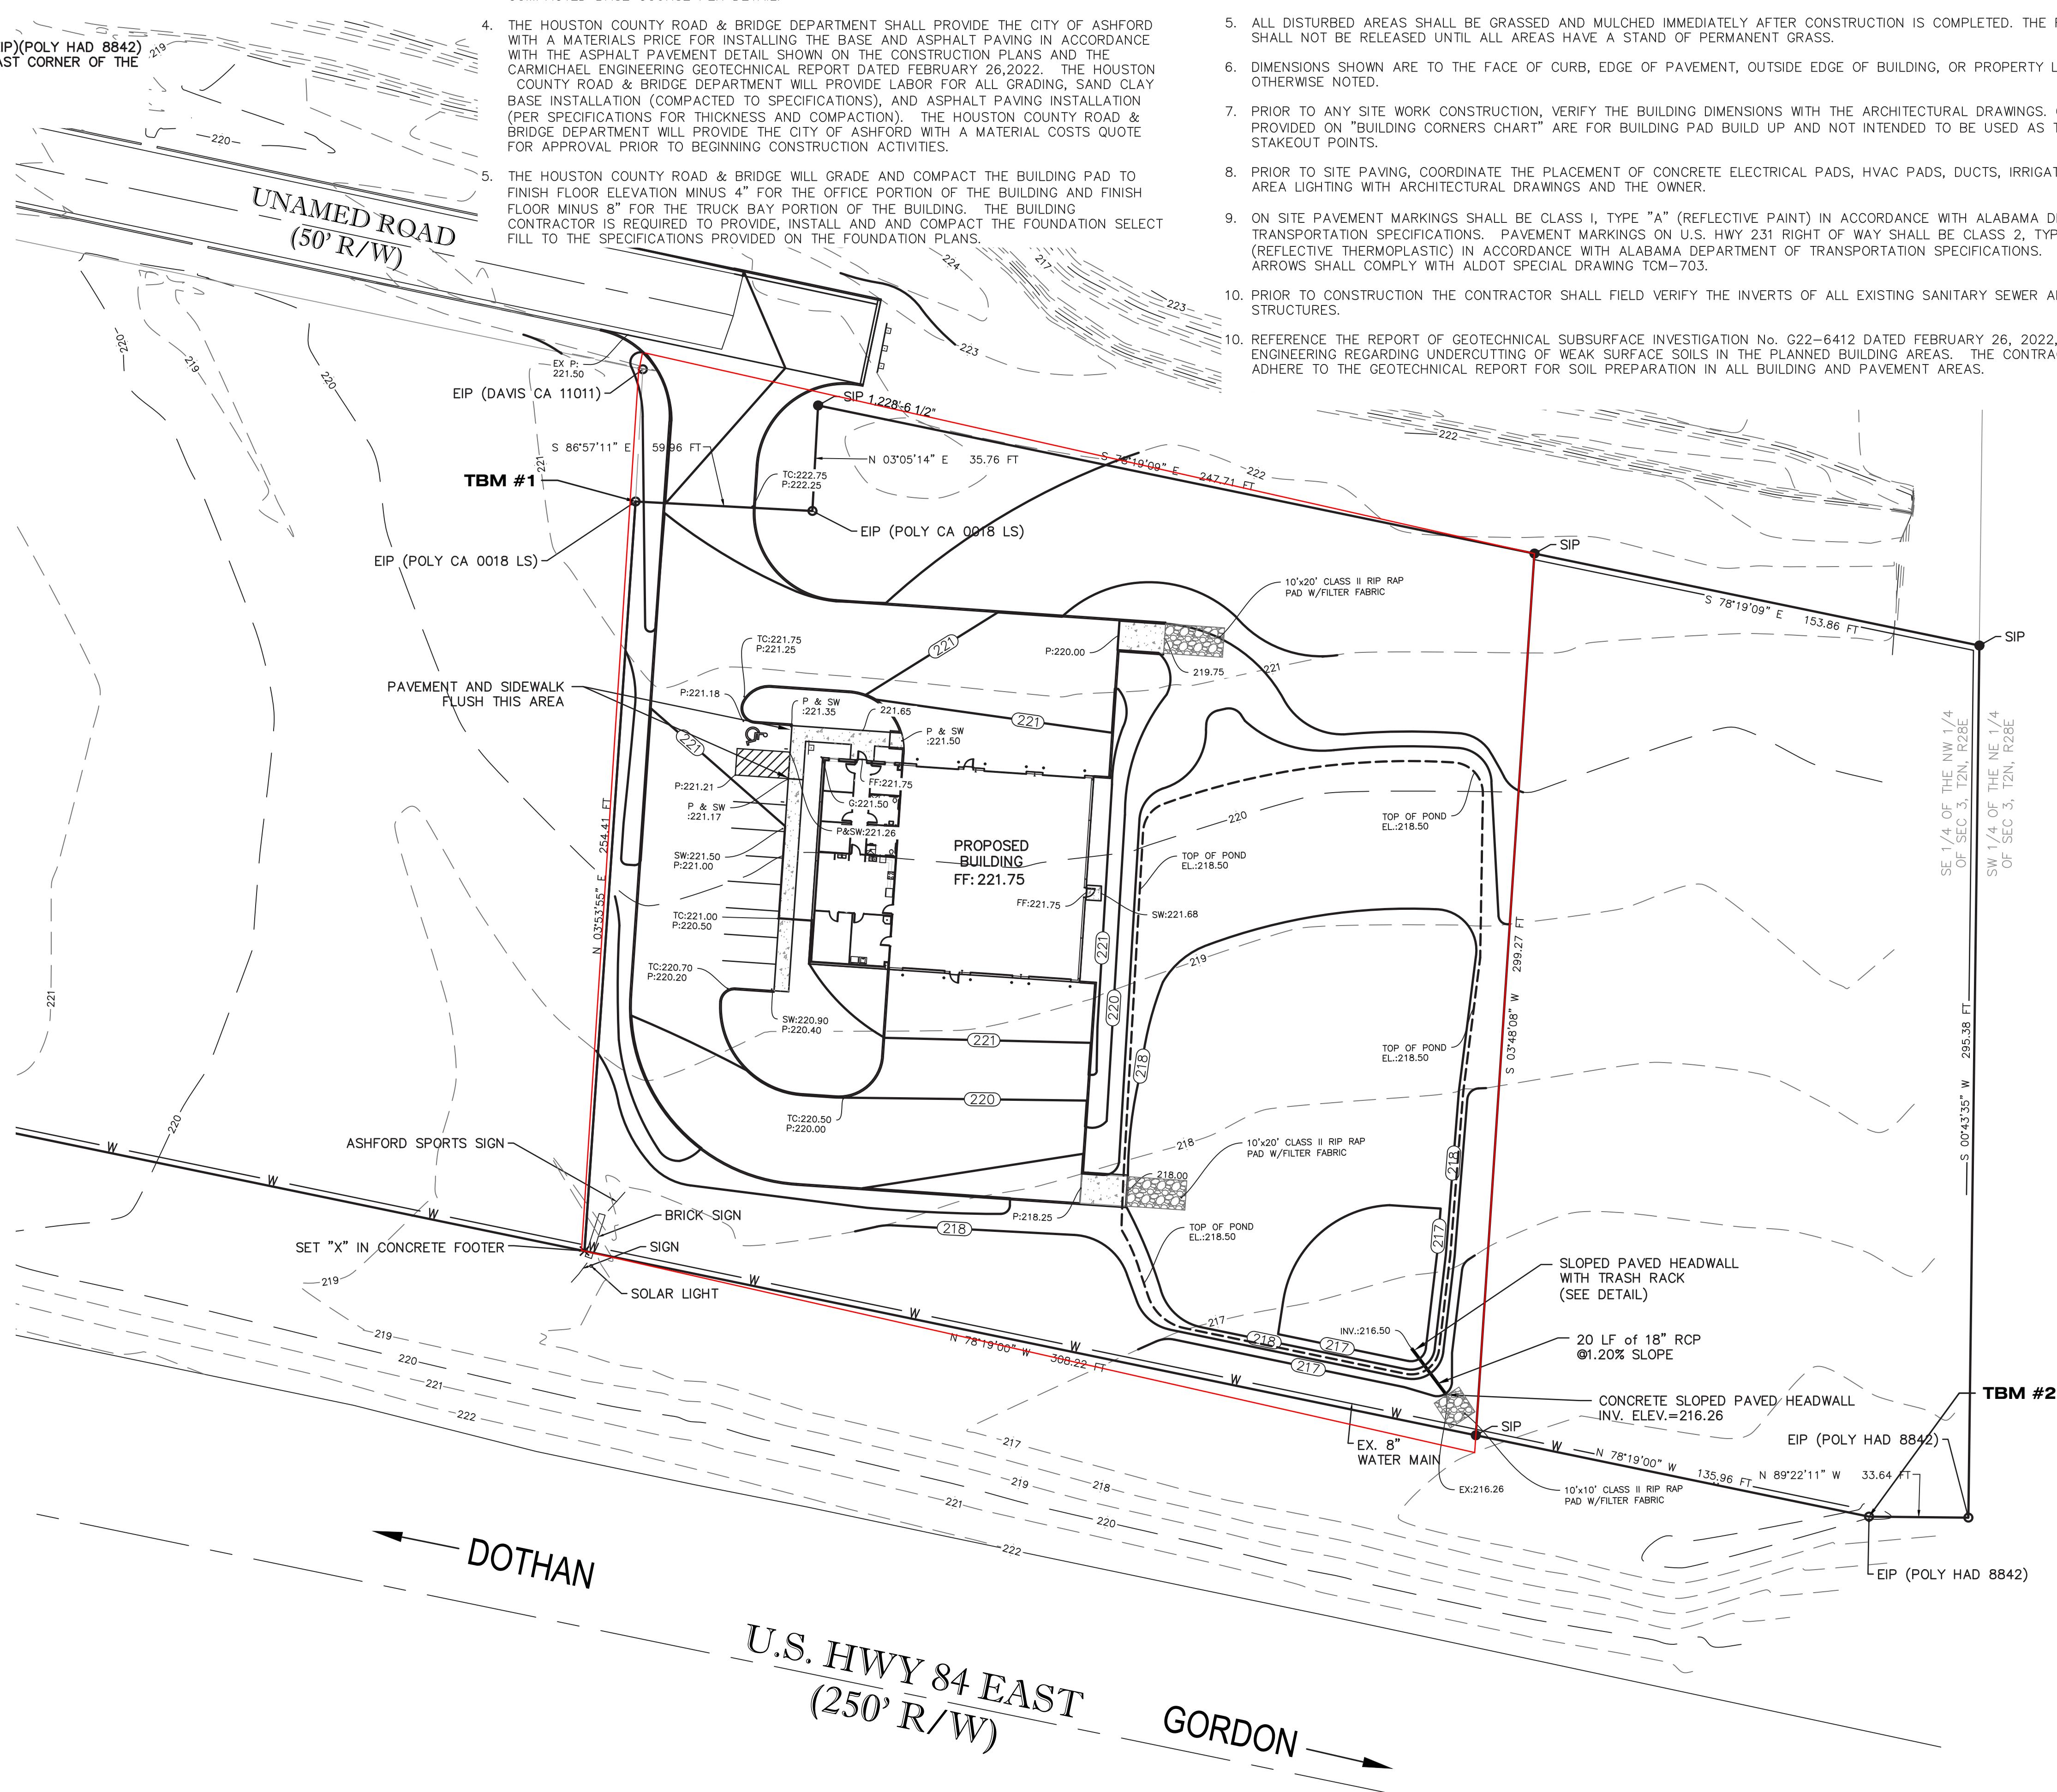

GRID NORTH BASED ON THE ALABAMA STATE

A scale bar diagram for a map. It features a horizontal line with tick marks at 0, 30, 60, and 90. The segment from 0 to 30 is highlighted in red. A red double-headed arrow spans this segment, with the label "00'-0"" positioned below it. To the right of the 30 mark, the text "SCALE: 1"=30'" is written.





PROJECT No.  
40-2107  
DATE: APRIL, 2022  
SCALE: N.T.S.

DRAWN BY:  
M. AMAN  
APPROVED BY:  
P. SANTORA













REVISIONS:

**SITE CONSTRUCTION PLANS FOR**  
**ASHFORD FIRE STATION**  
**CITY OF ASHFORD**  
**HOUSTON COUNTY, ALABAMA**  
**MISC. CONSTRUCTION DETAILS**





**NORTHSTAR**  
**ENGINEERING SERVICES**  
(P)334-673-3895 (F)334-673-1846  
2431 Hartford Hwy. Dothan, AL 36305  
web: www.northstarengineering.com

AL CERT. OF AUTH.  
CA-1896, CA-0621L  
FL CERT. OF AUTH.  
26312-E, 7858-S  
GA CERT. OF AUTH.  
003129  
MS CERT. OF AUTH.  
E-00001825

SHEET  
8  
OF  
9

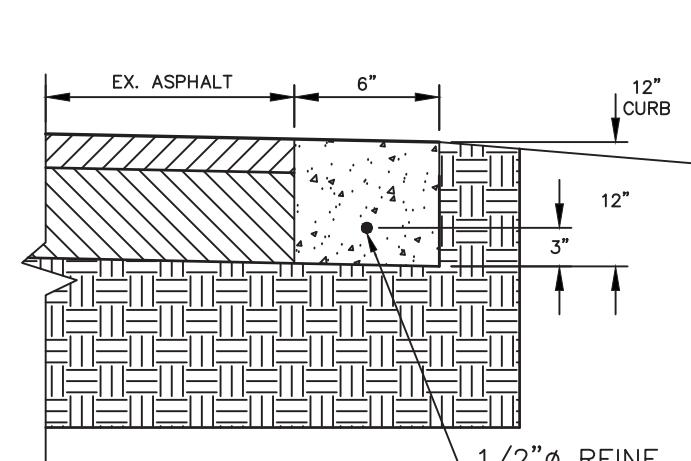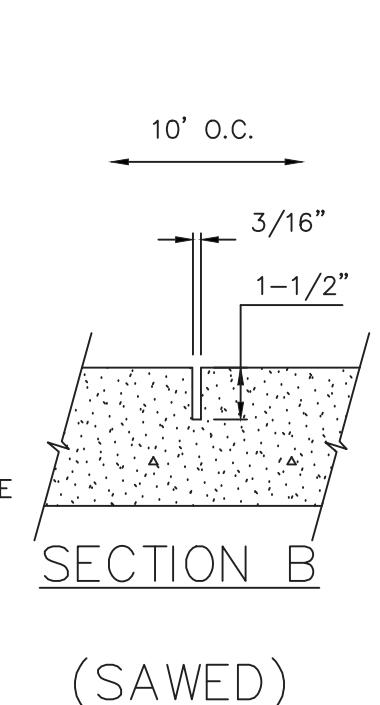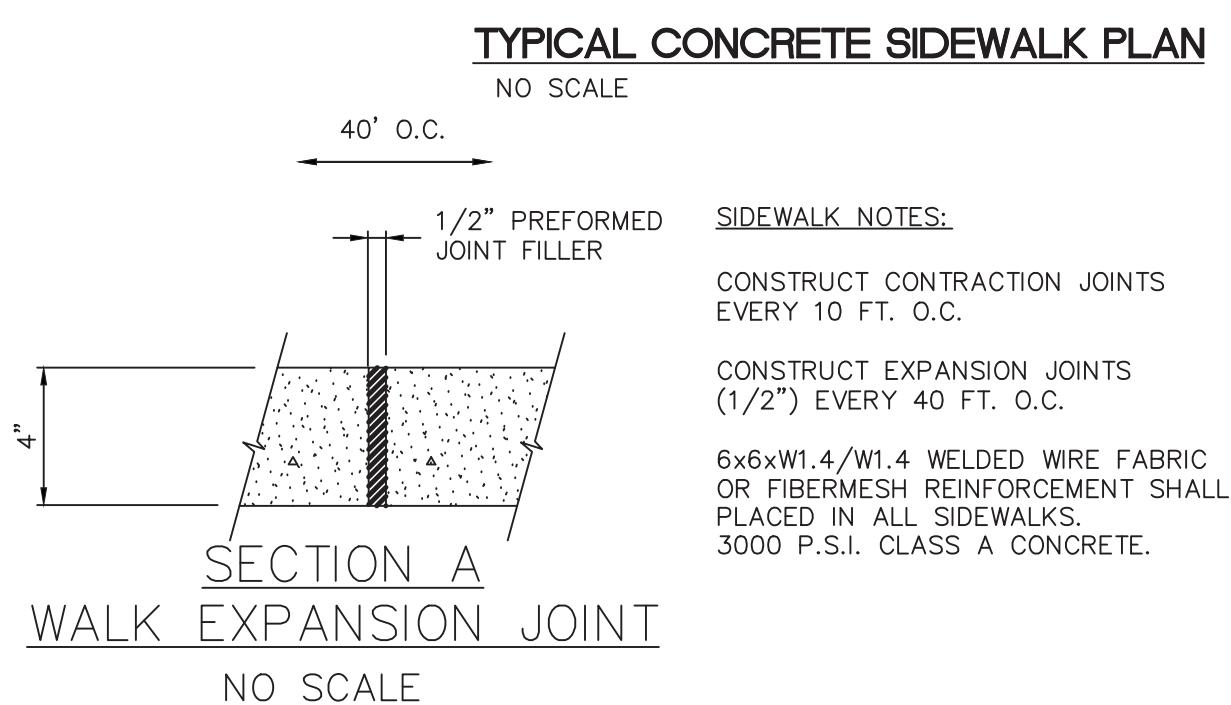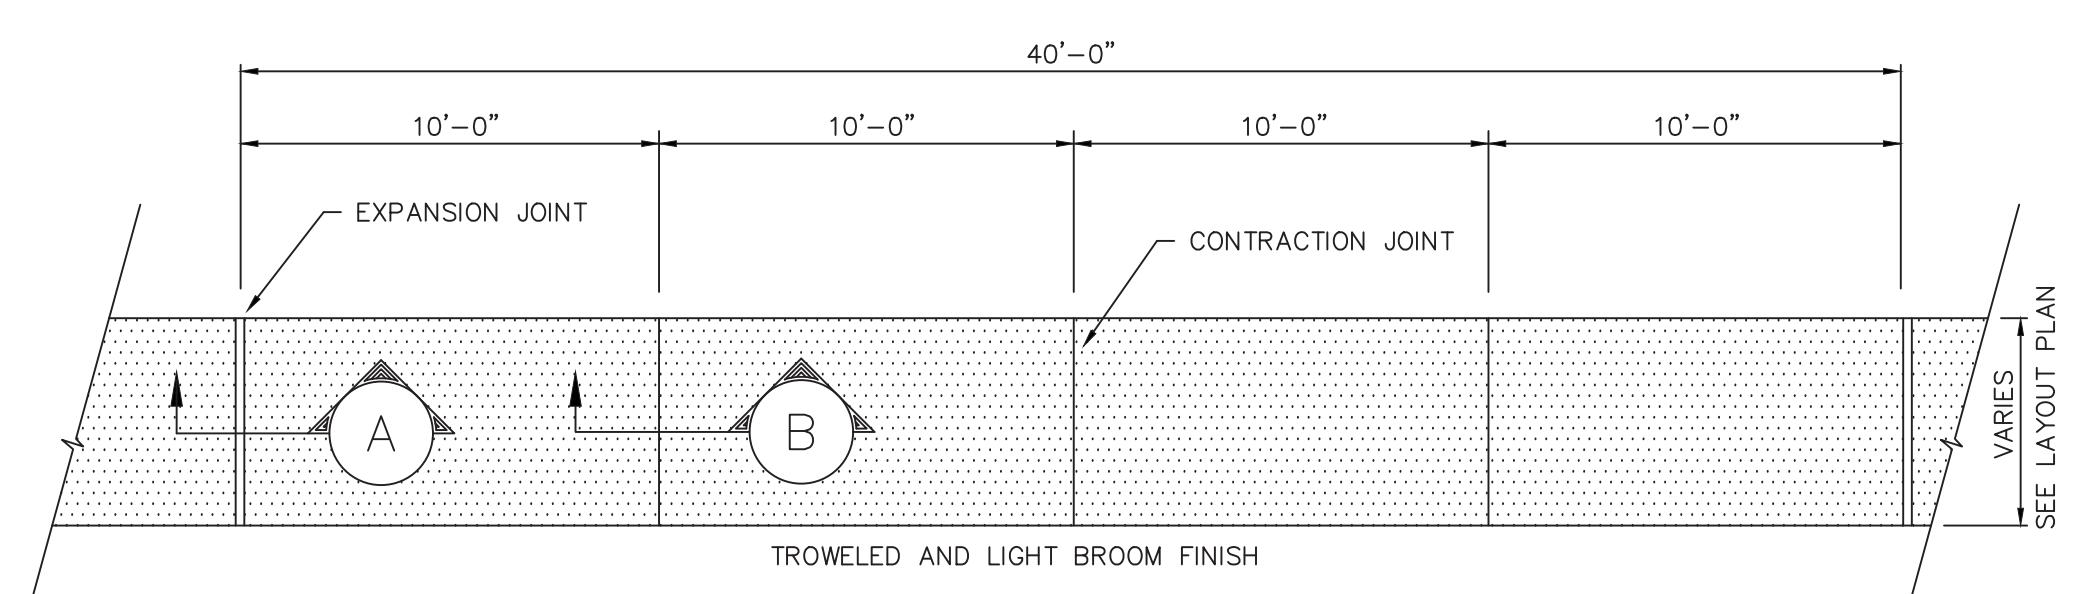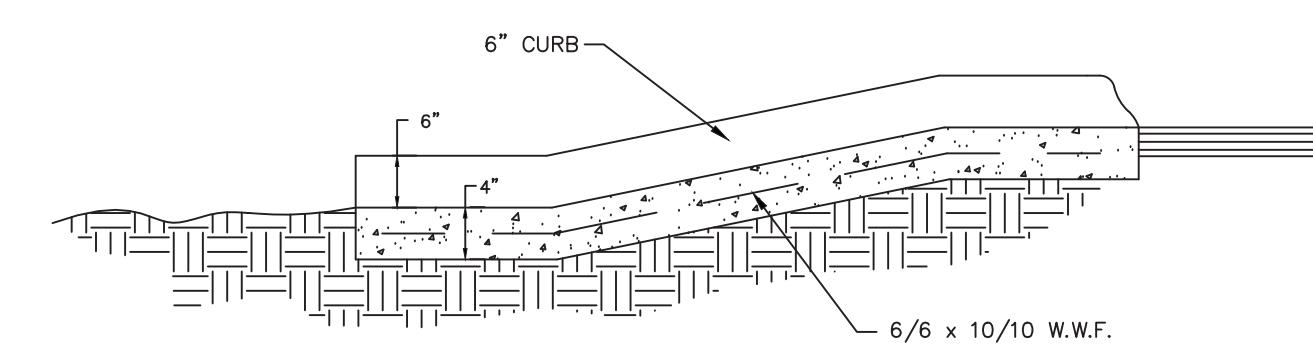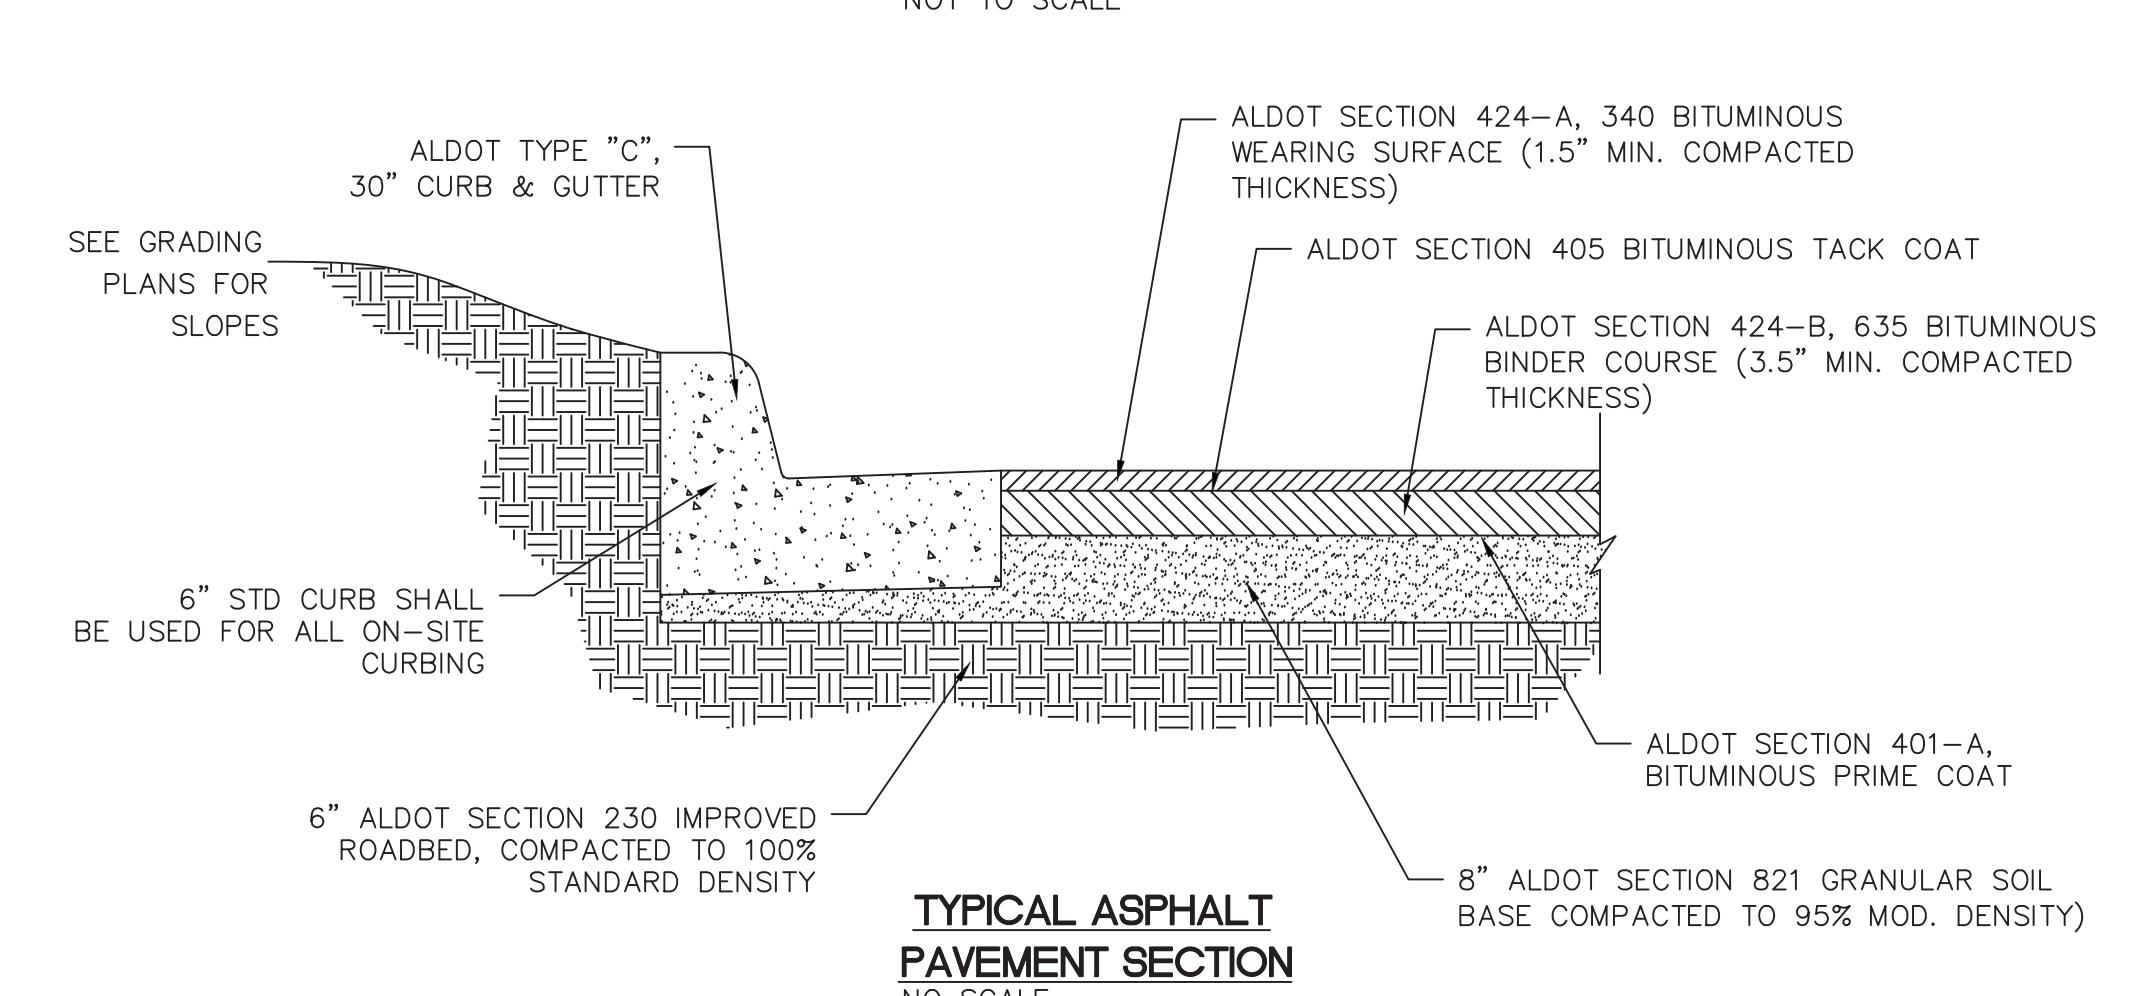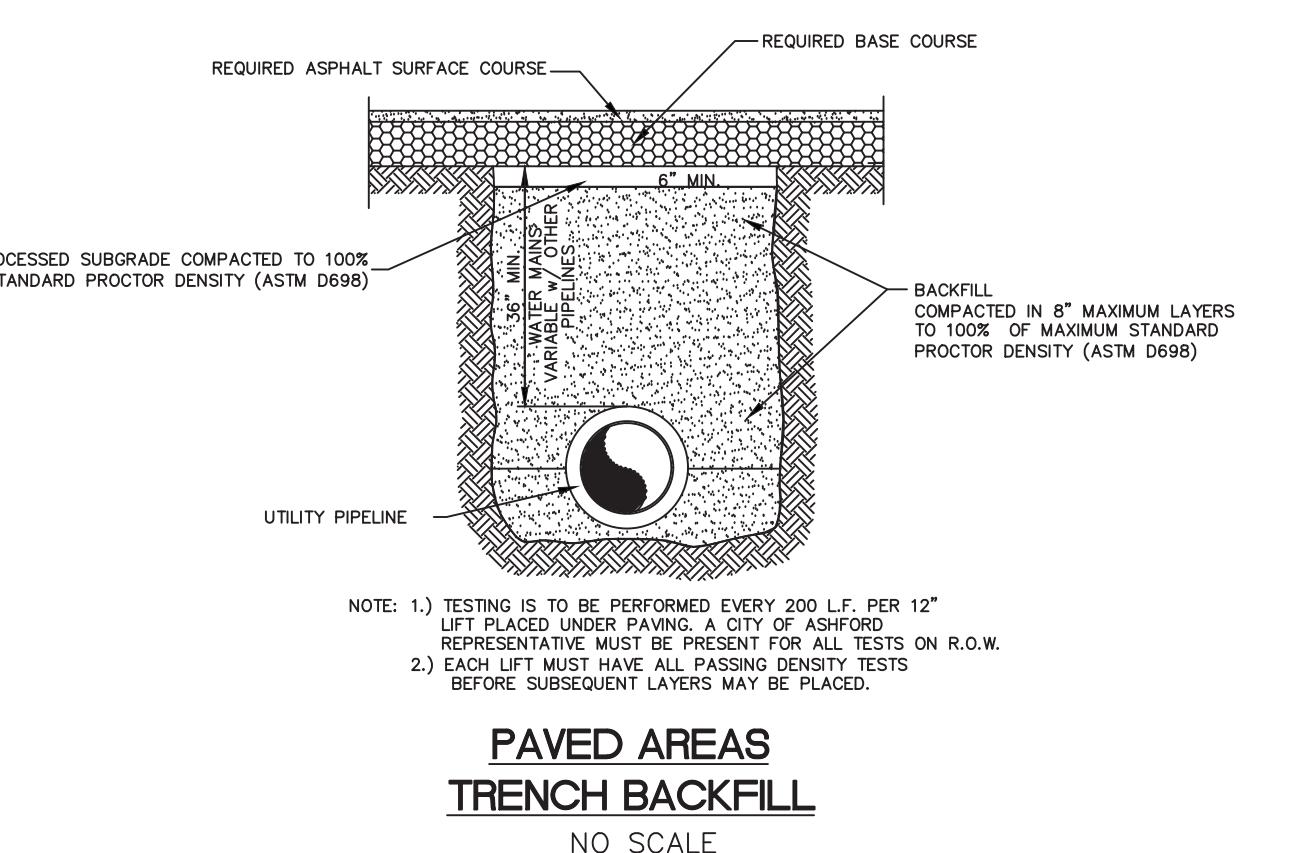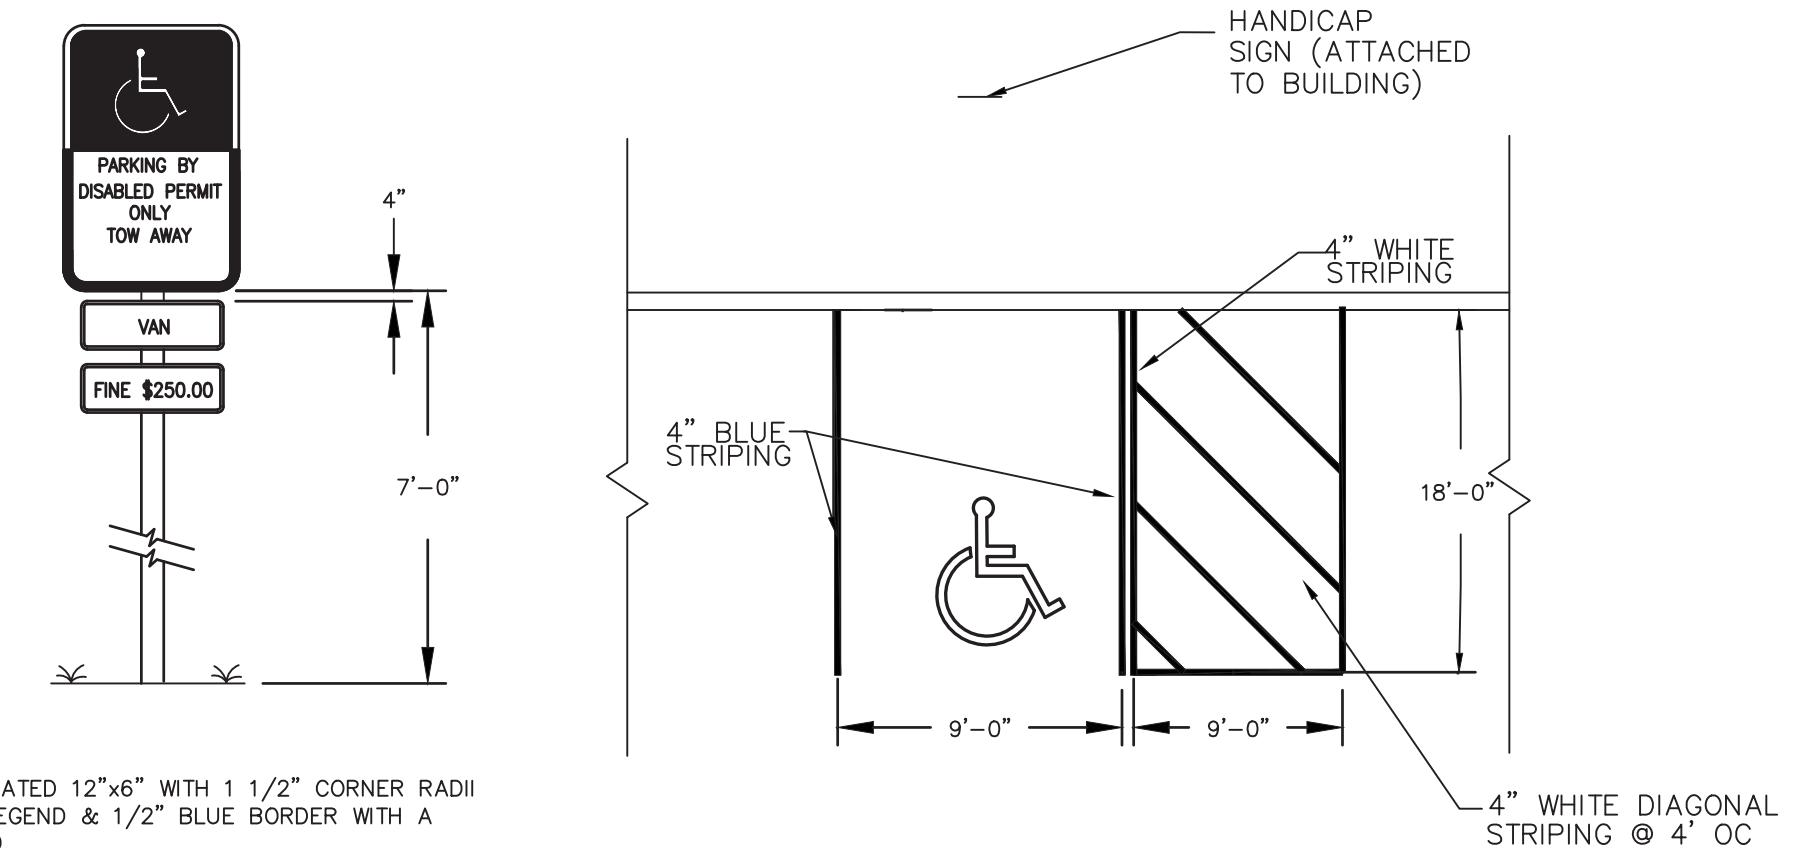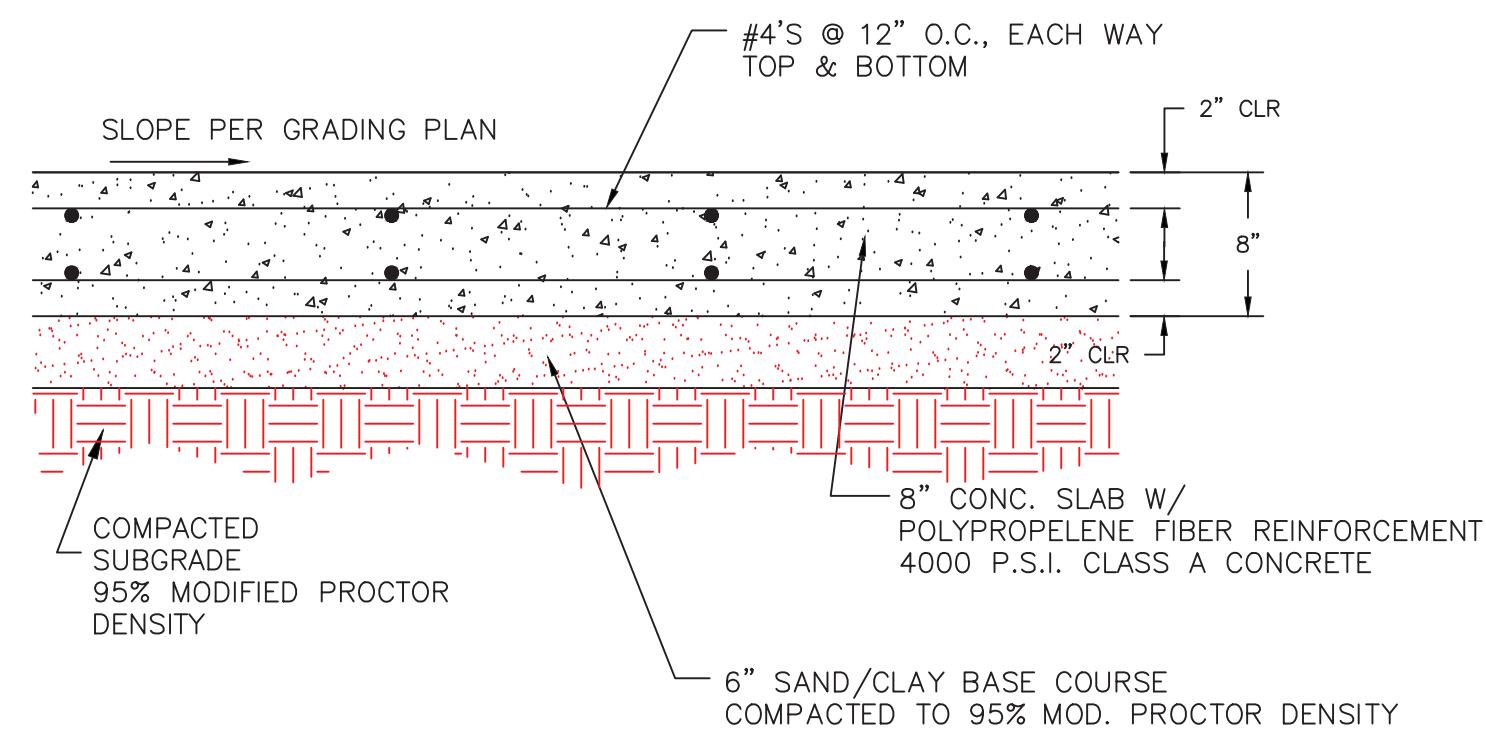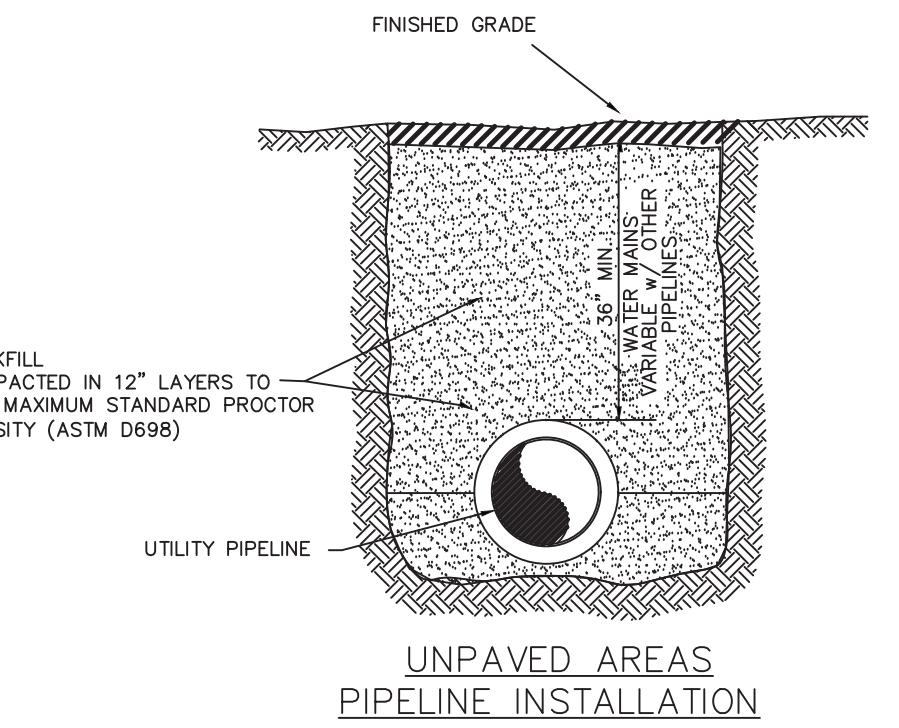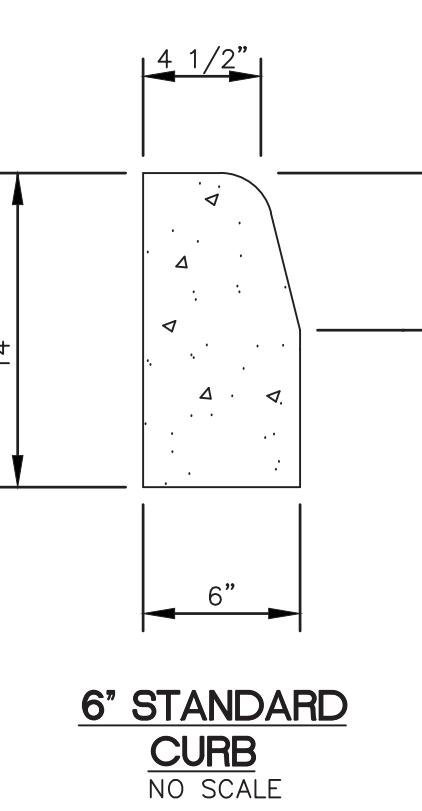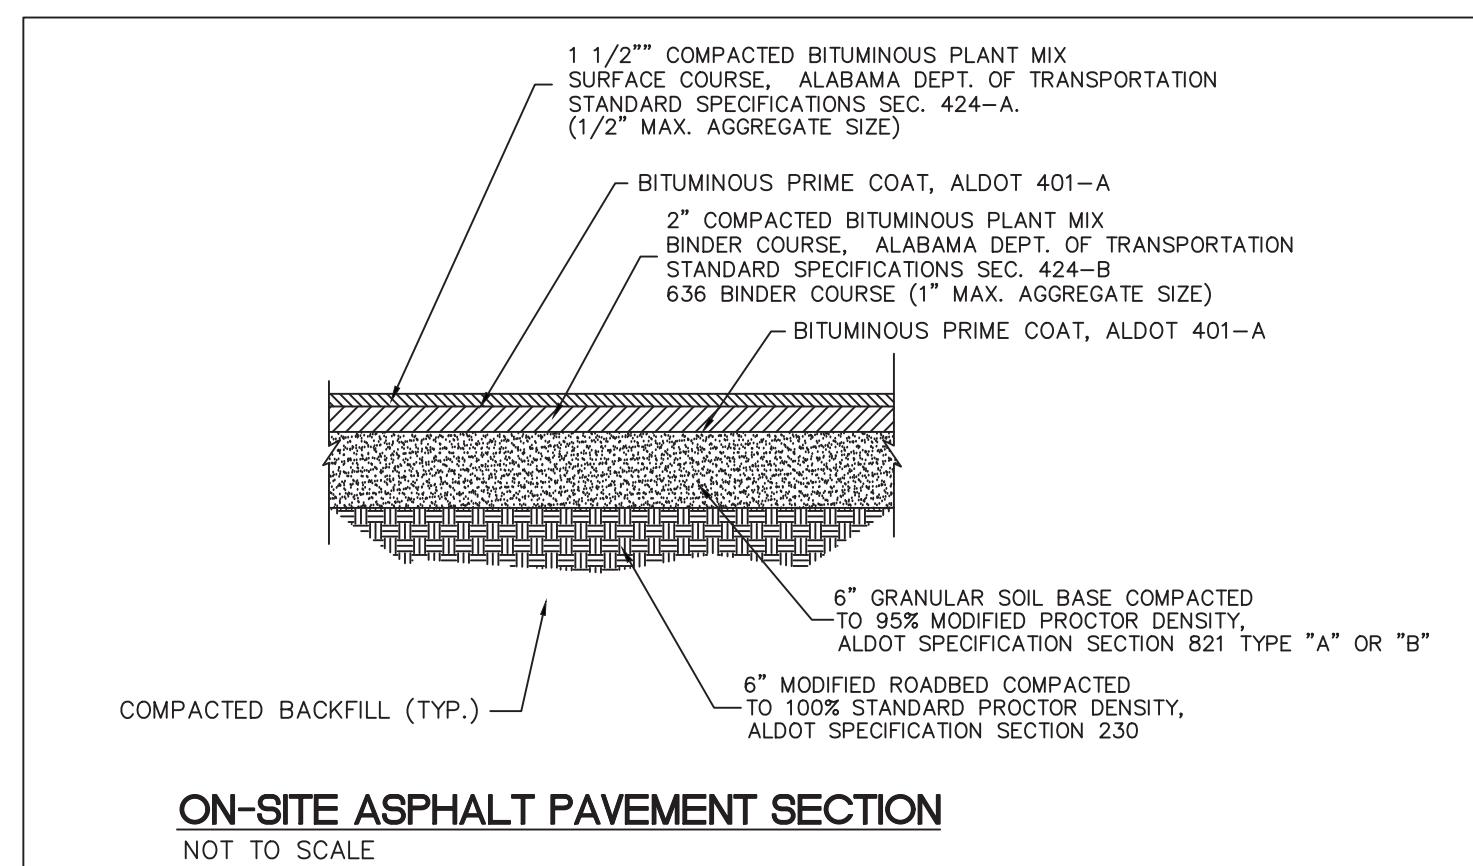

CONCRETE HEADER CURB  
NO SCALE

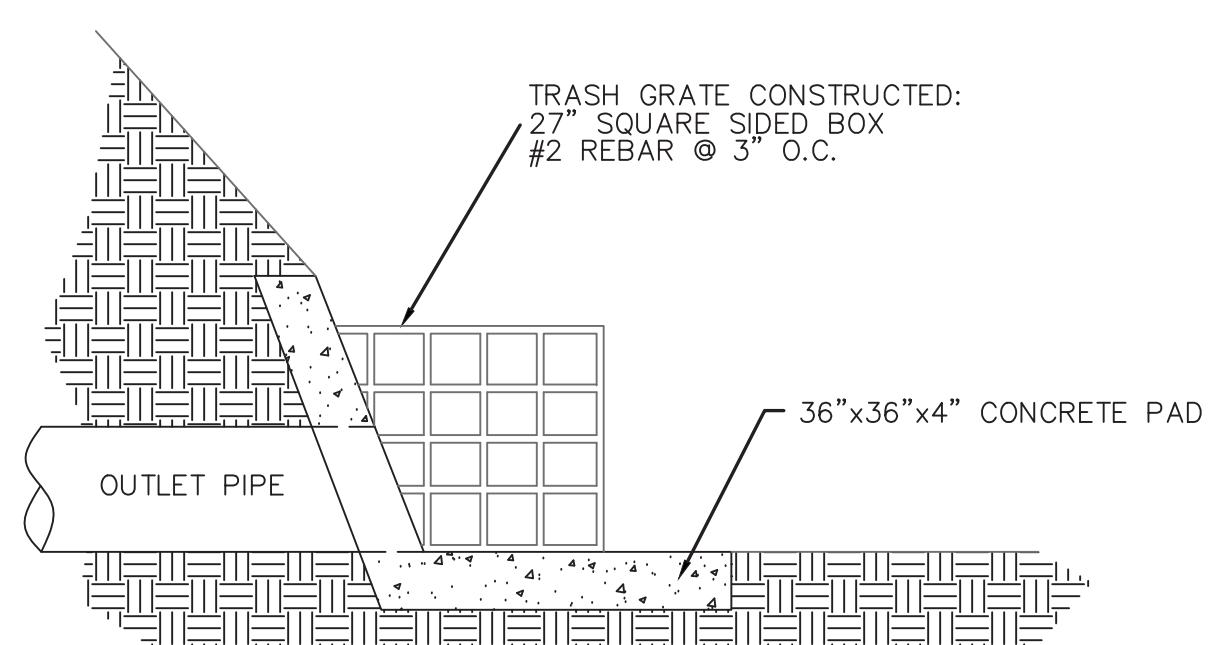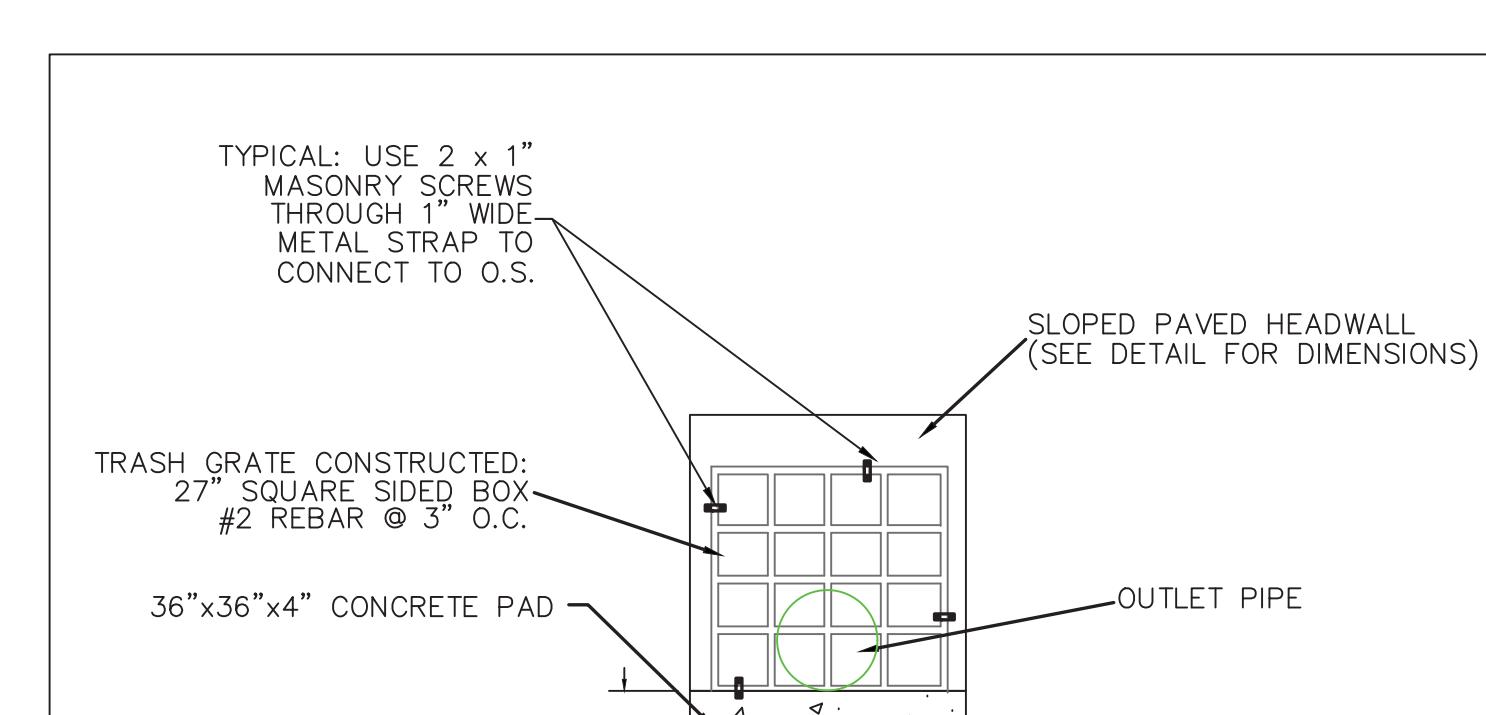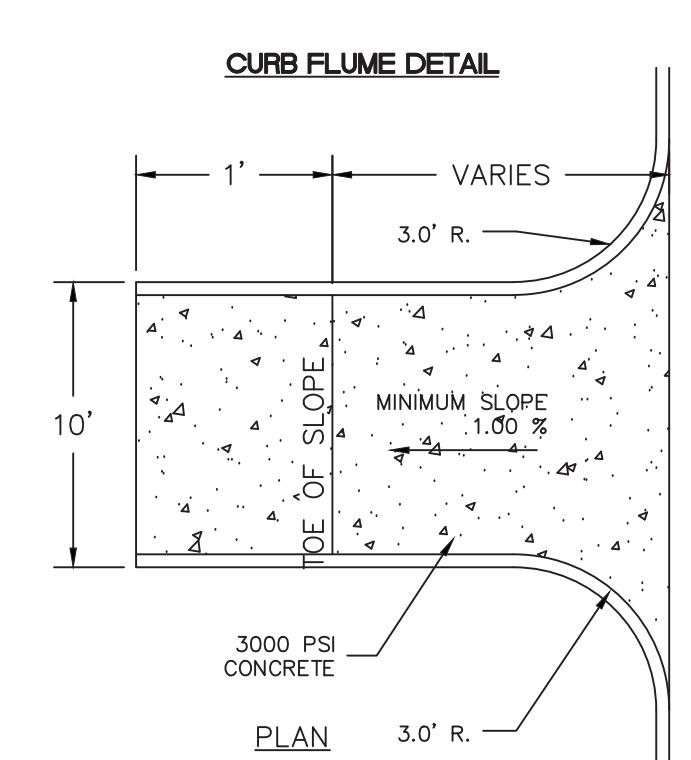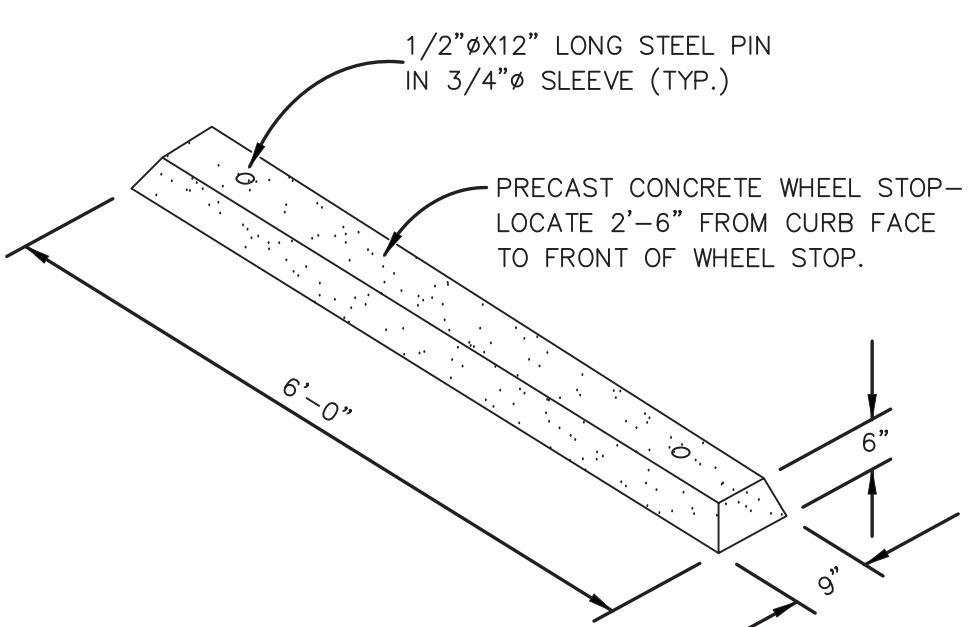

PROJECT No.  
40-2107

DATE: APRIL, 2022

SCALE: N.T.S.

DRAWN BY:  
M. AMAN

APPROVED BY:  
P. SANTORA





REVISIONS:

SITE CONSTRUCTION PLANS FOR  
ASHFORD FIRE STATION  
CITY OF ASHFORD  
HOUSTON COUNTY, ALABAMA  
MISC. CONSTRUCTION DETAILS



AL CERT. OF AUTH.  
CA-1896E, CA-0621LS  
FL CERT. OF AUTH.  
26312-E, 7858-S  
GA CERT. OF AUTH.  
003129  
MS CERT. OF AUTH.  
E-00001825

SHEET 9  
OF 9

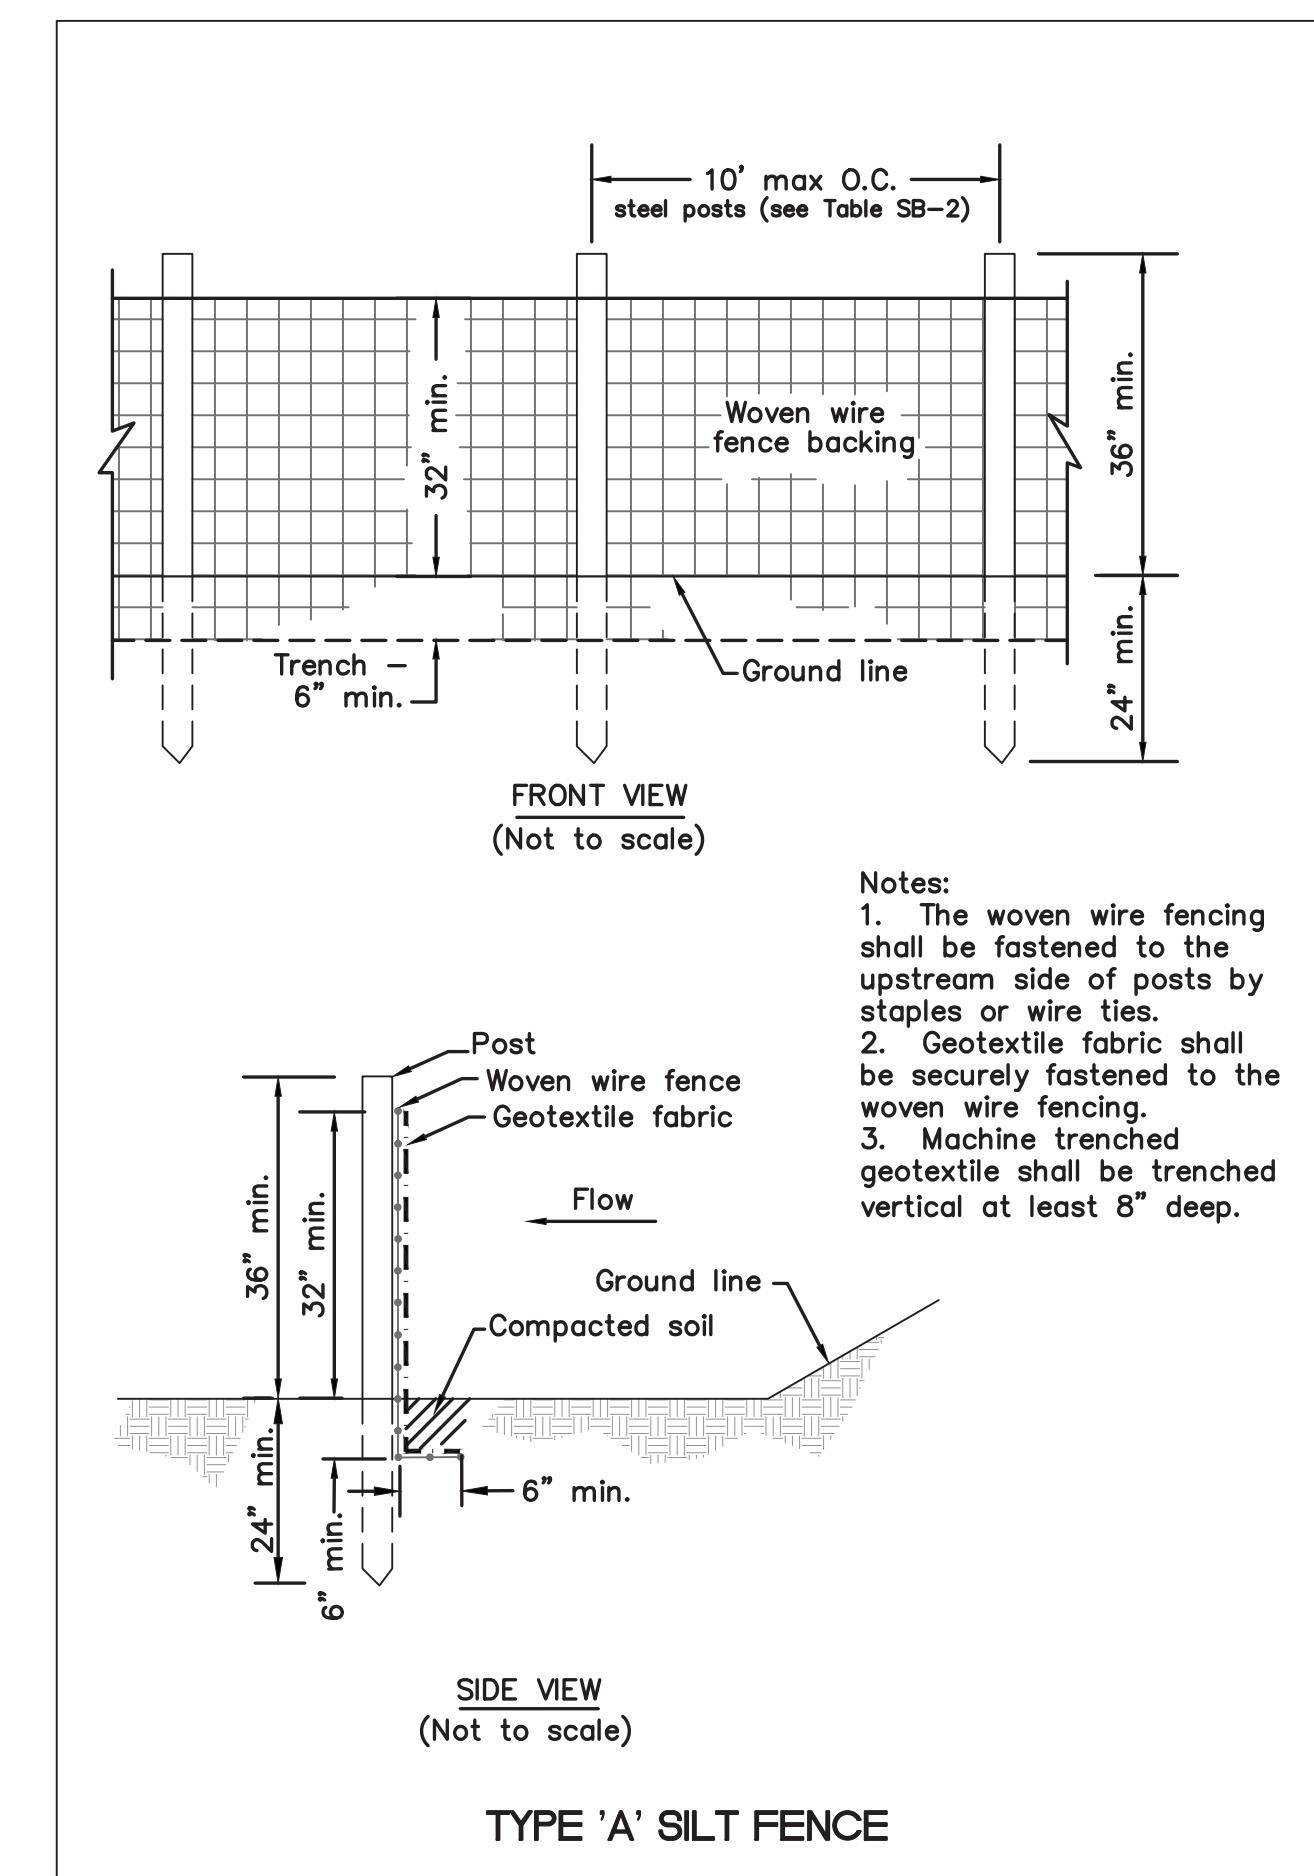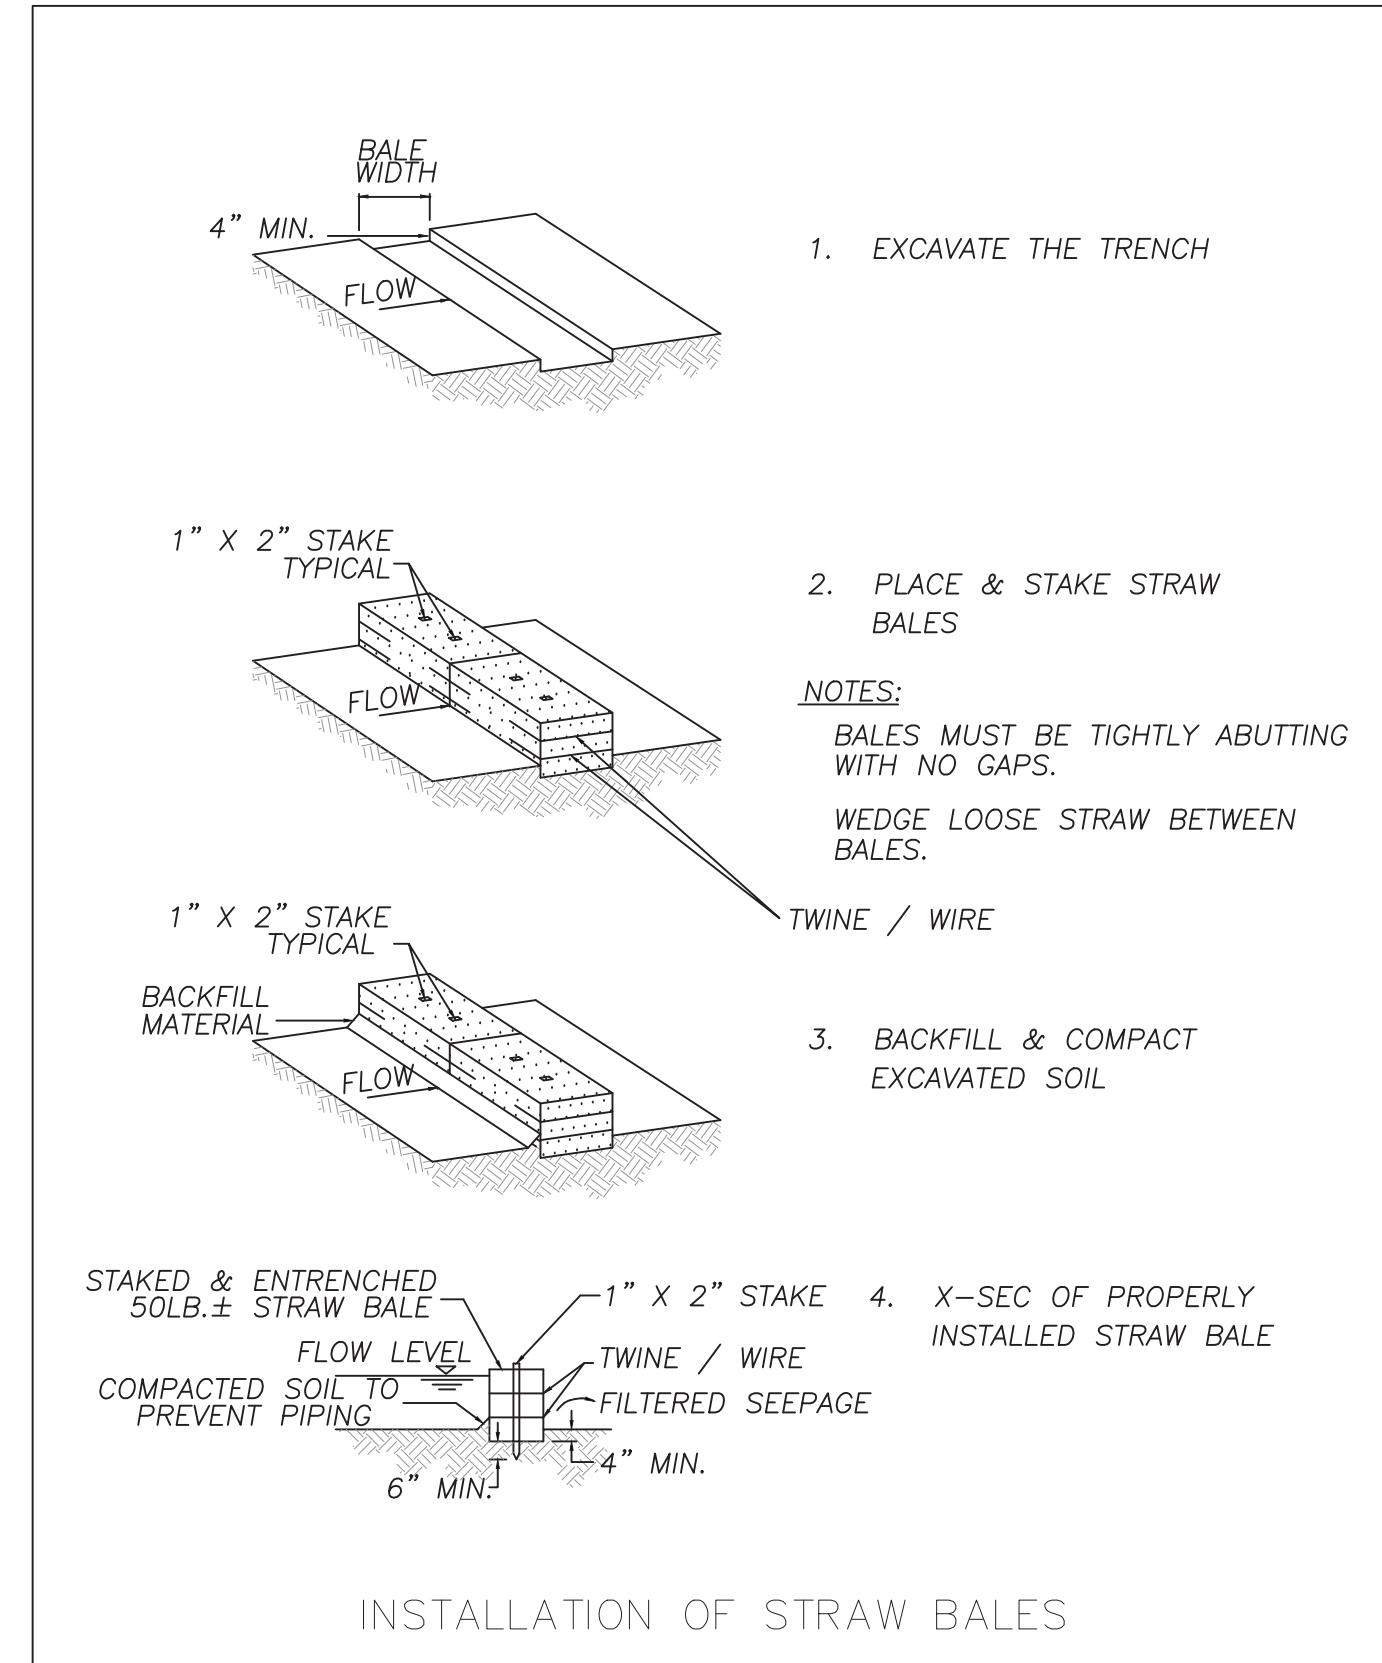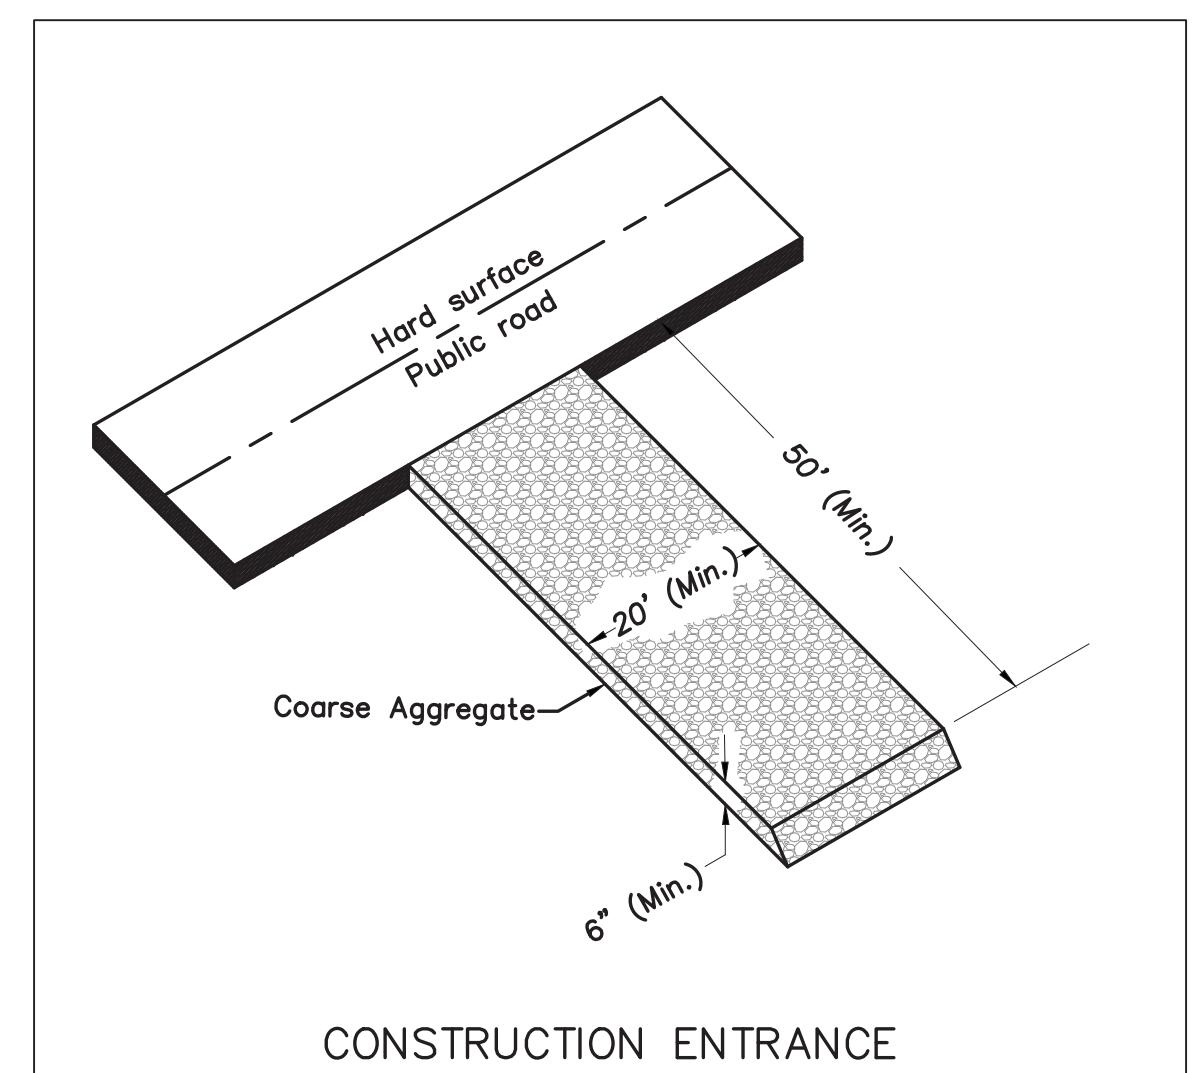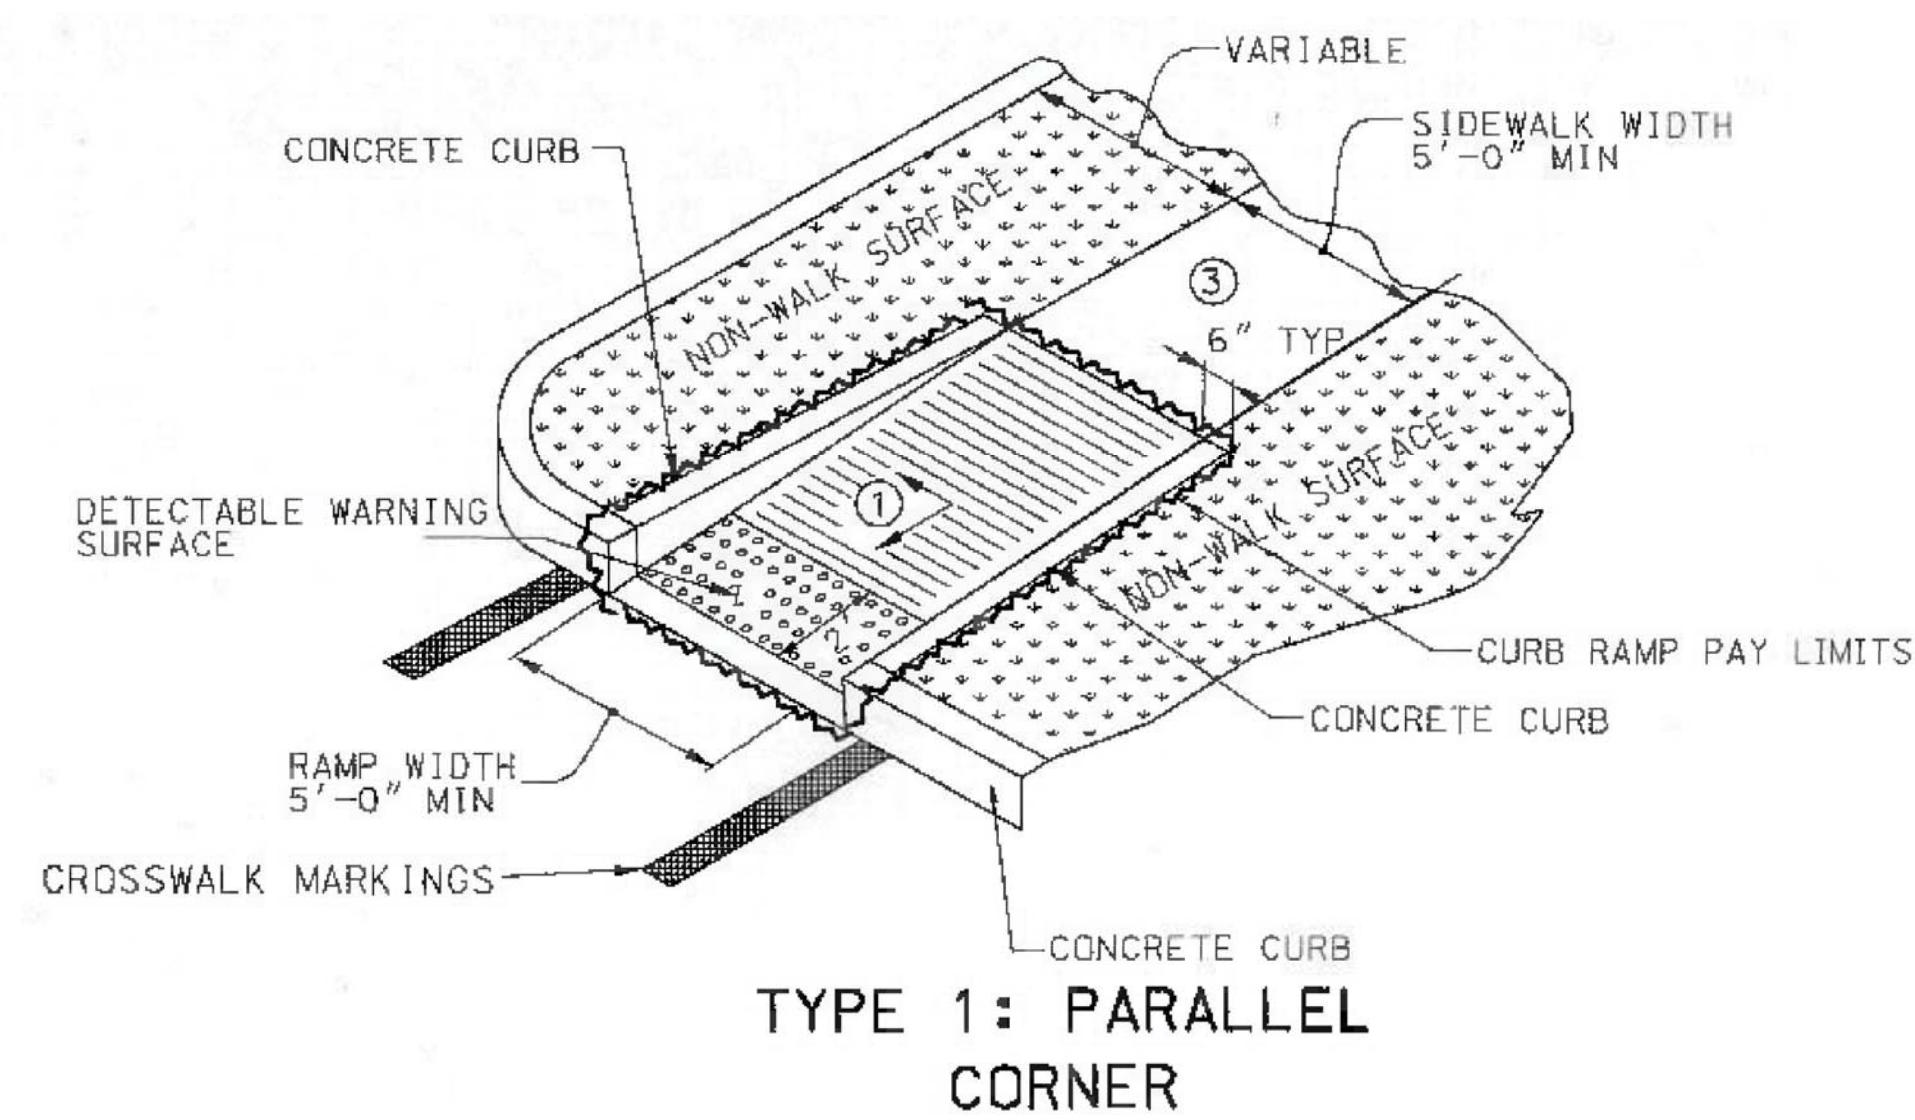

## GENERAL STRUCTURAL NOTES

### GENERAL

- NO PROVISION OF ANY REFERENCED STANDARD SPECIFICATION, MANUAL OR CODE (WHETHER OR NOT SPECIFICALLY INCORPORATED BY REFERENCE IN THE CONTRACT DOCUMENTS) SHALL BE EFFECTIVE TO CHANGE THE DUTIES AND RESPONSIBILITIES OF OWNER, CONTRACTOR, ENGINEER OR SUPPLIER OR ANY OF THEIR CONSULTANTS, AGENTS OR EMPLOYEES FROM THOSE SET FORTH IN THE CONTRACT DOCUMENTS, NOR SHALL IT BE EFFECTIVE TO ASSIGN TO THE STRUCTURAL ENGINEER OF RECORD OR ANY OF THE STRUCTURAL ENGINEER'S CONSULTANTS, AGENTS, OR EMPLOYEES ANY DUTY OR AUTHORITY TO SUPERVISE OR DIRECT THE FURNISHING OR PERFORMANCE OF THE WORK OR AUTHORITY TO UNDERTAKE RESPONSIBILITIES CONTRARY TO THE PROVISIONS OF THE CONTRACT DOCUMENTS.
- THE GENERAL CONTRACTOR SHALL VERIFY THE DIMENSIONS AND SITE CONDITIONS BEFORE STARTING WORK. THE ARCHITECT/STRUCTURAL ENGINEER OF RECORD SHALL BE NOTIFIED OF ANY DISCREPANCY.
- MATERIALS AND WORKMANSHIP SHALL CONFORM TO THE 2015 INTERNATIONAL BUILDING CODE.
- THE CONTRACTOR SHALL COORDINATE THE ARCHITECTURAL, MECHANICAL, ELECTRICAL, PLUMBING AND CIVIL WORKS WITH THE STRUCTURAL CONTRACT DOCUMENTS. ARCHITECT/STRUCTURAL ENGINEER OF RECORD SHALL BE NOTIFIED OF ANY DISCREPANCIES OR OMISSIONS.
- THE CONTRACTOR SHALL VERIFY THE FLOOR AND ROOF MOUNTED MECHANICAL EQUIPMENT'S WEIGHTS, FLOOR AND/OR ROOF OPENING SIZES AND LOCATIONS WITH ARCHITECTURAL, STRUCTURAL, AND MECHANICAL DRAWINGS.
- THE CONTRACTOR SHALL NOTIFY IN WRITING THE STRUCTURAL ENGINEER OF RECORD OF CONDITIONS ENCOUNTERED IN THE FIELD CONTRADICTORY TO THOSE SHOWN ON THE STRUCTURAL CONTRACT DOCUMENTS.

### 1. FOR DIMENSIONS NOT SHOWN ON THE STRUCTURAL CONTRACT DOCUMENTS SEE THE ARCHITECTURAL.

### 2. STRUCTURAL CONTRACT DRAWINGS SHALL NOT INCLUDE SHOP DRAWINGS, VENDOR DRAWINGS OR ANY MATERIAL PREPARED AND SUBMITTED BY THE CONTRACTOR OR SUBCONTRACTOR.

### 3. REFERENCE TO STANDARD SPECIFICATIONS OF ANY TECHNICAL SOCIETY ORGANIZATION OR ASSOCIATION TO CODES OF LOCAL OR STATE AUTHORITIES, SHALL MEAN THE EDITION OF THE REFERENCED CODE INDICATED IN THE BUILDING CODE NOTED ABOVE.

### 10. ANY CONTRACTOR INTENDING TO SUPPORT EQUIPMENT, PIPE DUCT WORK, CRANES OR OTHER ITEMS WHICH SUBJECT THE ROOF OR FLOOR SYSTEMS TO CONCENTRATED LOADINGS NOT SPECIFICALLY INDICATED ON THESE STRUCTURAL DRAWINGS, MUST SUBMIT SHOP DRAWINGS, WEIGHTS, AND PROPOSED SUPPORT LOCATIONS TO THE ENGINEER FOR APPROVAL PRIOR TO ERECTION. ANY CONTRACTOR WHO ERECTS EQUIPMENT WITHOUT OBTAINING SUCH APPROVAL WILL BE REQUIRED EITHER TO REMOVE IT AND SUBMIT SHOP DRAWINGS OR STAND THE COST OF REQUIRED REINFORCEMENT OF MEMBER.

### 11. THE CONTRACTOR SHALL BE RESPONSIBLE FOR INITIATING, MAINTAINING AND SUPERVISING ALL SAFETY PRECAUTIONS AND PROGRAMS IN CONNECTION WITH THE PERFORMANCE OF THE CONTRACT. THE CONTRACTOR SHALL GIVE NOTICES AND COMPLY WITH ALL APPLICABLE LAWS, ORDINANCES, RULES, REGULATIONS AND LAWFUL ORDERS OF PUBLIC AUTHORITIES (ESPECIALLY OSHA) BEARING ON SAFETY OF PERSONS OR PROPERTY OR THEIR PROTECTION FROM DAMAGE, INJURY OR LOSS. THE CONTRACTOR SHALL NOT LOAD OR PERMIT ANY PART OF THE CONSTRUCTION SITE TO BE LOADED SO AS TO ENDANGER ITS SAFETY.

### 12. IN NO CASE SHALL STRUCTURAL ALTERATIONS OR WORK AFFECTING A STRUCTURAL MEMBER BE MADE, UNLESS APPROVED BY JOHNSON AND ASSOCIATES ENGINEERING IN WRITING.

### 13. THIS BUILDING IS DESIGNED AS AN ENCLOSED STRUCTURE. ALL EXTERIOR COMPONENTS (DOORS, WINDOWS, ETC.) MUST BE DESIGNED TO WITHSTAND THE WIND LOADINGS SPECIFIED FOR THE DESIGN OF COMPONENTS AND CLADDING IN THE APPLICABLE BUILDING CODE.

### 14. THE CONTRACT DOCUMENT DRAWINGS, GENERAL NOTES, AND SPECIFICATIONS SHALL GOVERN IN THE EVENT OF A CONFLICT WITH THE SPECIFICATIONS AND/OR CODE OF PRACTICE FOR AISC, ACI, SJI, OR OTHER STANDARDS.

### 15. JOHNSON & ASSOCIATES ENGINEERING (JAE) HAS A LIMITED SCOPE OF SERVICES FOR THIS PROJECT. JAE IS THE ENGINEER OF RECORD FOR THE DESIGN OF THE FOUNDATION SYSTEMS AND THE WOOD FRAMING SYSTEM FOR THE PROJECT. THE DESIGN OF THE PRE-ENGINEERED METAL BUILDING (PEMB) SYSTEM, INCLUDING PRIMARY AND SECONDARY FRAMING, THE DESIGN OF CONNECTIONS AND ALL DETAILING IS THE SOLE RESPONSIBILITY OF THE PEMB VENDOR AND HIS ALABAMA LICENSED PROFESSIONAL ENGINEER (PEMB DELEGATED ENGINEER).

### PRE-ENGINEERED METAL BUILDING DESIGN CRITERIA

### 1. ALL COLUMN SHALL BE ANALYZED AND DESIGNED AS HAVING PINNED BASES. NO MOMENT SHALL BE TRANSFERRED TO THE FOUNDATIONS.

### 2. DESIGN LOADS SHALL BE AS SPECIFIED IN THE DESIGN LOADS SECTION.

### 3. ROOF PURLINS MUST BE CAPABLE OF RESISTING NET WIND PRESSURES (IN OR OUT) ASSUMING INTERIOR FLANGE UNBRACED EXCEPT WHERE FLANGE BRACING IS PROVIDED.

### 4. THE METAL BUILDING SYSTEM MANUFACTURER WILL BE RESPONSIBLE FOR COMPLETE DESIGN OF THE BUILDING STRUCTURAL FRAME (INCLUDING LATERAL LOADS) DOWN TO THE FOUNDATION. COMPLETE DESIGN REACTIONS SHALL BE FURNISHED TO THE FOUNDATION DESIGN ENGINEER.

### 5. ALL METAL BUILDING SYSTEM SHOP DRAWINGS AND ERECTION DRAWINGS SHALL BE SIGNED AND SEALED BY THE MANUFACTURER'S ENGINEER DULY LICENSED IN THE PROJECT STATE.

### 6. METAL BUILDING CALCULATIONS COVER SHEET SHALL BE SIGNED AND SEALED BY THE MANUFACTURER'S ENGINEER IN RESPONSIBLE CHARGE OF THEIR DEVELOPMENT, LICENSED IN THE PROJECT STATE.

### 7. DEFLECTION LIMITS FOR ROOF MEMBERS SHALL BE AS FOLLOWS:

#### MANUFACTURER'S STANDARD DEFLECTION LIMITS, UNO

#### 8. EXCEPT AS OTHERWISE APPROVED BY ARCHITECT, STRUCTURAL CLEARANCES SHALL BE MAINTAINED AS CURRENTLY INDICATED IN THE CONTRACT DOCUMENTS.

#### 9. STANDING SEAM DECKING SHALL NOT BE CONSIDERED AS PROVIDING DIAPHRAGM RESISTANCE FOR LATERAL LOADS.

#### 10. RIGID FRAME COLUMNS SHALL HAVE A MINIMUM BASE PLATE THICKNESS OF AT LEAST 1/2 INCH.

#### 11. ALL DEVIATIONS FROM THE CONTRACT DOCUMENTS (REQUESTED FOR THE CONVENIENCE OF THE PRE-ENGINEERED BUILDING SYSTEM MANUFACTURER) ARE SUBJECT TO APPROVAL BY THE ARCHITECT/ENGINEER OF RECORD. ALL DEVIATIONS SHALL BE EXPRESSLY LISTED AND DEFINED IN THE SHOP DRAWING SUBMITTAL. ARCHITECT/ENGINEER IS NOT RESPONSIBLE FOR DISCOVERY OF DEVIATIONS NOT LISTED, AND APPROVAL OF UNLISTED DEVIATIONS SHALL NOT BE IMPLIED.

#### 12. A QUALIFIED REPRESENTATIVE OF THE METAL BUILDING SYSTEM SUPPLIER'S CONSTRUCTION SERVICES DEPARTMENT SHALL MAKE AN ON-SITE REVIEW OF THE ERECTED BUILDING. REVIEWER SHALL NOTIFY THE GENERAL CONTRACTOR AND ARCHITECT OF ANY AND ALL NOTED DISCREPANCIES FROM THE ERECTION AND DESIGN DRAWINGS.

#### CONTRACTOR/ERECTOR SHALL CORRECT ALL DISCREPANCIES TO THE SATISFACTION OF THE REVIEWER AND THE ARCHITECT.

### PRE-ENGINEERED METAL BUILDING DESIGN CRITERIA (CONT.)

#### UPON COMPLETION OF SERVICES THE REVIEWER SHALL SIGN AND NOTARIZE THE FOLLOWING STATEMENT UNDER THE METAL BUILDING SYSTEM SUPPLIER'S LETTER-HEAD:

TO THE BEST OF MY KNOWLEDGE AND BELIEF THE ABOVE DESCRIBED STRUCTURE HAS BEEN ERECTED IN SUBSTANTIAL CONFORMANCE WITH THE SUPPLIER'S ERECTION DRAWINGS AND DETAILS.

- CONCRETE PEDESTALS/FOOTINGS SHALL BE OF SUFFICIENT SIZE TO PROVIDE FULL CONTACT BEARING AREA FOR COLUMN BASE PLATES. IF PEMB SELECTS BASE PLATES/COLUMNS LARGER THAN INDICATED PEDESTAL/FOOTING SIZES, IT SHALL BE THE CONTRACTOR'S RESPONSIBILITY TO OBTAIN APPROVAL OF SAME FROM THE PROJECT ARCHITECT/STRUCTURAL ENGINEER OF RECORD. UPON RECEIPT OF SUCH APPROVAL, THE CONTRACTOR SHALL PURCHASE PEDESTALS/FOOTINGS OF SUFFICIENT SIZE TO ALLOW FULL CONTACT BEARING AREA FOR COLUMN BASE PLATES AND MAINTAIN A MINIMUM OF 4" FROM THE CENTERLINE OF THE EXTREME ANCHOR BOLTS TO THE PEDESTAL EDGE. PEDESTALS OF SUFFICIENT SIZE SHALL BE FURNISHED WITHOUT ADDITIONAL COST TO THE OWNER. CONTRACTOR SHALL PAY STRUCTURAL ENGINEER OF RECORD FOR SERVICES IN RE-SIZING PEDESTALS FOR CONTRACTOR'S CONVENIENCE. IF ARCHITECT/ENGINEER CANNOT APPROVE LARGER COLUMNS AND BASE PLATES, CONTRACTOR SHALL INSTRUCT PEMB MANUFACTURER TO FURNISH COLUMNS AND BASE PLATES THAT WILL HAVE FULL BEARING ON THE PEDESTALS/FOOTINGS INDICATED ON THE CONTRACT DRAWINGS.
- CENTER ALL FOOTINGS ON METAL BUILDING SYSTEM COLUMN BASE PLATE, UNO. NOTE, CENTERLINE OF METAL BUILDING COLUMN AND FOOTING MAY NOT ALIGN WITH CENTERLINE OF COLUMN PEDESTAL.

- SEE ANCHOR BOLT LAYOUT PLAN, PROVIDED BY THE METAL BUILDING SYSTEM MANUFACTURER FOR EXACT ANCHOR BOLT SIZE AND LOCATION. DESIGN OF REQUIRED ANCHOR BOLT DIAMETER IS THE RESPONSIBILITY OF THE METAL BUILDING SYSTEM DESIGNER. SEE ANCHOR BOLT DETAILS FOR REQUIRED ANCHOR BOLT LENGTH AND CONFIGURATION.

### FOUNDATION

- THE FOUNDATION IS DESIGNED AS RECOMMENDED BY CARMICHAEL ENGINEERING, INC. IN THE PROJECT GEOTECHNICAL REPORT DATED FEBRUARY 26, 2022. THE STRUCTURAL ENGINEER OF RECORD IS NOT RESPONSIBLE FOR SUBSURFACE CONDITIONS ENCOUNTERED IN THE FIELD CONTRARY TO THOSE ASSUMED FOR DESIGN.

- FOR BUILDING SITE PREPARATION REQUIREMENTS SEE PROJECT GEOTECHNICAL REPORT AND PROJECT SPECIFICATIONS.

- FOUNDATION SHALL CONSIST OF SPREAD FOOTINGS DESIGNED TO BEAR ON SOIL CAPABLE OF SUPPORTING 1500 PSF.
- FOOTING SUBGRADE SHALL BE COMPAKTED TO A MINIMUM OF 95% STANDARD PROCTOR DENSITY (ASTM D-698) AS INDICATED IN THE PROJECT GEOTECHNICAL REPORT.

### CONCRETE

- CONCRETE WORK SHALL CONFORM TO THE LATEST EDITION OF ACI 318 AND CRSI STANDARDS.

- REFER TO ARCHITECTURAL DRAWINGS FOR MOLDS, GROOVES, ORNAMENTS, CLIPS, OR GROUNDS REQUIRED TO BE ENCAINED IN CONCRETE AND FOR LOCATION AND DETAILS OF FLOOR FINISHES AND SLAB DEPRESSIONS.

- CONSTRUCTION JOINTS IN CONCRETE BEAMS AND FRAMED SLABS SHALL BE PLACED AT MIDSPAN. ALL CONSTRUCTION JOINTS MUST BE KEYED WITH REINFORCING RIBS CONTINUOUS THROUGH JOINTS.

- AT COLUMN FOOTINGS, COLUMN ANCHOR RODS WITH TEMPLATE SHALL BE INSTALLED IN PROPER LOCATION PRIOR TO POURING THE FOOTING.

- CONCRETE SHALL HAVE THE FOLLOWING MINIMUM 28 DAY COMPRESSIVE STRENGTH UTILIZING TYPE I CEMENT:

FOUNDATIONS AND SLABS ON GRADE 3000 PSI

### REINFORCING STEEL

- REINFORCING STEEL SHALL CONFORM TO ASTM A615-GRADE 60.

- WELDED WIRE FABRIC SHALL CONFORM TO ASTM A185 AND HAVE A MINIMUM SIDE LAP OF 8 INCHES.

- REINFORCEMENT SHALL BE SPLICED ONLY AS SHOWN OR NOTED IN THE STRUCTURAL CONTRACT DOCUMENTS.

- ALL REINFORCING LAP SPlices SHALL BE IN ACCORDANCE OF THE LATEST EDITION OF ACI 318, FOR REINFORCED MASONRY, AND ACI 530 FOR REINFORCED MASONRY.

- ALL REINFORCING STEEL AND ACCESSORIES SHALL BE DETAILED, FABRICATED, AND PLACED IN ACCORDANCE WITH THE LATEST EDITION OF THE ACI MANUAL AND MANUAL OF STANDARD PRACTICE FOR DETAILING REINFORCED CONCRETE STRUCTURES.

- MINIMUM CONCRETE COVER FOR REINFORCING BARS SHALL BE IN CONFORMANCE WITH ACI 318, EXCEPT AS OTHERWISE NOTED.

- REINFORCING IN ALL CONCRETE WALLS, FOOTINGS AND BOND BEAMS SHALL BE CONTINUOUS AT INTERSECTIONS AND CORNERS, WHERE WALL FOOTINGS STEP, REINFORCING SHALL BE CONTINUOUS IN STEP.

- PROVIDE 2-5 EXTRA DIAGONAL REINFORCING BARS AT CORNERS OF ALL OPENINGS IN FRAMED SLABS AND CONCRETE WALLS. EXTEND BARS 2'-0" BEYOND EACH EDGE OF OPENING.

- AT POURED CONCRETE WALLS, PIERS AND COLUMNS, DOWELS FOR VERTICAL REINFORCING BARS SHALL BE INSTALLED IN THEIR PROPER LOCATION PRIOR TO CONCRETE POUR OF THE FOOTINGS.

### STRUCTURAL SUBMITTALS

- FURNISH ONE ELECTRONIC COPY OF ALL SHOP DRAWINGS AND SUBMITTALS.

- SEE CONTRACT SPECIFICATIONS FOR ADDITIONAL SUBMITTAL REQUIREMENTS AND PROCEDURES.

- REPRODUCTION OF CONTRACT DOCUMENTS FOR ERECTION AND/OR SHOP DRAWINGS WILL NOT BE PERMITTED.

### ERCTION BRACING AND FORMWORK

- THE DESIGN, ADEQUACY AND SAFETY OF ERECTION BRACING, FORMWORK, SHORING, AND TEMPORARY SUPPORTS IS THE SOLE RESPONSIBILITY OF THE CONTRACTOR.

- ANCHOR BOLTS AND FOUNDATIONS HAVE NOT BEEN DESIGNED FOR ANY CONDITION OF LOADING OTHER THAN THAT OF THE COMPLETED STRUCTURE. VERIFICATION OF ADEQUACY OF ANCHOR BOLTS AND FOUNDATIONS TO DESIGN ERECTION INDUCED FORCES IS SOLELY THE RESPONSIBILITY OF THE STEEL ERECTOR AND CONTRACTOR.

- UNLESS OTHERWISE NOTED STEEL FRAMEWORKS FOR THIS PROJECT ARE CLASSIFIED PER AISC CODE OF STANDARD PRACTICE AS A "NON-SELF-SUPPORTING STEEL FRAME". PROVIDE TEMPORARY SUPPORT SYSTEMS NECESSARY TO SECURE ANY ELEMENT OR ELEMENTS OF THE STEEL FRAMING UNTIL ALL PERTAINANT STEEL BRACING, DECKING AND/OR MASONRY WALLS ARE IN-PLACE AND CONNECTED TO THE STEEL FRAMEWORKS.

### JOB SITE SAFETY

THE GENERAL CONTRACTOR IS SOLELY RESPONSIBLE FOR JOB SITE SAFETY AND FOR CONFORMANCE WITH THE HEALTH AND SAFETY PROVISIONS REQUIRED BY ANY REGULATORY AGENCIES. THE STRUCTURAL ENGINEER OF RECORD HAS NO AUTHORITY TO EXERCISE ANY CONTROL OVER ANY CONSTRUCTION CONTRACTOR, OR THEIR EMPLOYEES WITH THEIR WORK OR ANY HEALTH OR SAFETY PRECAUTIONS.

### STRUCTURAL SUBMITTALS (CONT.)

- THE SITE REVIEW OF SUBMITTALS WILL BE MADE FOR LIMITED PURPOSES AND IS SUBJECT TO THE LIMITATIONS AND DISCLAIMERS SET FORTH IN THESE GENERAL NOTES. THE JOHNSON AND ASSOCIATES ENGINEERING REVIEW DOES NOT INVOLVE OR INCLUDE:

- REVIEW OF SUBMITTAL DIMENSIONS AND QUANTITIES.
- ACCEPTANCE OR ASSUMPTION OF ANY RESPONSIBILITY TO REVIEW, ANALYZE OR EVALUATE ANY SUBMITTALS INCLUDING SHOP DRAWINGS PROVIDED TO JOHNSON AND ASSOCIATES ENGINEERING OR ACCEPTANCE OR ASSUMPTION OF ANY PART OF CONTRACTOR'S RESPONSIBILITIES (WHICH INCLUDE THE CONTRACTOR'S RESPONSIBILITY TO REVIEW AND APPROVE SUBMITTAL), WHETHER OR NOT THE JOHNSON AND ASSOCIATES ENGINEERING REVIEW WAS MADE PRIOR TO THE REVIEW AND APPROVAL OF THE CONTRACTOR.
- ANALYSIS, VERIFICATION OR SUBSTANTIATION OF EQUIPMENT OR SYSTEM INSTALLATION OR PERFORMANCE OF EQUIPMENT OR SYSTEMS.
- REVIEW EVALUATION OR APPROVAL OF PROJECT SAFETY PRECAUTIONS OR SAFETY TRAINING.
- REVIEW EVALUATION OR APPROVAL OF CONSTRUCTION MEANS, METHODS, TECHNIQUES, PROCEDURES OR SEQUENCES.

JOHNSON AND ASSOCIATES ENGINEERING REVIEW OF A SPECIFIC ITEM DOES NOT INCLUDE OR INDICATE OR CONSTITUTE REVIEW OF A GROUP OR AN ASSEMBLY OF WHICH THE ITEM IS A COMPONENT.

THE CONTRACTOR MUST NOTIFY JOHNSON AND ASSOCIATES ENGINEERING, IN WRITING, RELATIVE TO ANY DEVIATION FROM THE CONTRACT DOCUMENTS, WHICH APPEARS IN THE SHOP DRAWINGS, SAMPLES, AND PRODUCT DATA. APPROVAL OF THE SUBMITTAL CONCERNING SUCH DEVIATION DOES NOT CONSTITUTE APPROVAL OF THE DEVIATION. APPROVAL OR REJECTION OF THE DEVIATION WILL ONLY BE PROVIDED BY JOHNSON AND ASSOCIATES ENGINEERING IN A SEPARATE WRITTEN COMMUNICATION TO THE CONTRACTOR. JOHNSON AND ASSOCIATES ENGINEERING IS NOT RESPONSIBLE FOR DISCOVERY OF DEVIATIONS NOT COMMUNICATED BY THE CONTRACTOR.

### STRUCTURAL SUBMITTALS: METAL BUILDING SYSTEM, CONCRETE REINFORCING BARS, ANCHOR RODS AND CONCRETE MIX DESIGNS.

- THE FOLLOWING SUBMITTALS MUST BE MADE TO THE STRUCTURAL ENGINEER OF RECORD:

- ERCTION DRAWINGS, FABRICATION DRAWINGS, COMPONENT DETAILS, AND CONNECTION DETAILS.
- CALCULATIONS FOR ALL COMPONENTS SIZED BY THE FABRICATOR'S SPECIALTY DESIGN ENGINEER.

- THE STRUCTURAL SUBMITTALS FOR THE METAL BUILDING SYSTEM SHALL BEAR THE IMPRESSED SEAL AND SIGNATURE OF THE SPECIALTY DESIGN ENGINEER LICENSED IN THE PROJECT STATE.

- THE PROJECT STRUCTURAL ENGINEER OF RECORD WILL REVIEW THE SUBMITTALS FOR INDICATION THAT HIS INTENT HAS BEEN UNDERSTOOD AND THAT THE SPECIFIED CRITERIA HAVE BEEN USED.

### DESIGN LOADS

- ROOF LIVE LOAD 20 PSF

- MEZZANINE FLOOR LIVE LOAD 100 PSF

- WIND LOADING CRITERIA (PER ASCE 1-16)

BUILDING RISK CATEGORY	IV
BASIC WIND SPEED: V(ULT)	129 MPH
EXPOSURE CATEGORY:	C
INTERNAL PRESSURE COEFF.: G _{0.1}	1.0

### SEISMIC LOADING CRITERIA

S ₆	0.082
S ₁	0.051
IMPORTANCE FACTOR	
SITE CLASS	
SPECTRAL ACCELERATION PARAMETERS:	
S _{6d}	150
S _{6d1}	D (ASSUMED)

SEISMIC DESIGN CATEGORY	C
DESIGN BASE SHEAR:	KIPS
ANALYSIS PROCEDURE:	
EQUIVALENT LATERAL FORCE PROCEDURE	

### 5. METAL BUILDING SUPPLEMENTAL DESIGN CRITERIA

DEAD LOAD:	WEIGHT OF STRUCTURE
COLLATERAL LOAD:	5 PSF
CONCENTRATED LOADS:	(EQUIP., ETC.)

### PREENGINEERED SYSTEMS

- THE DESIGN OF PREENGINEERED SYSTEMS SPECIFIED IN THE CONTRACT DOCUMENTS WHICH ARE DESIGNED/ENGINEERED BY OTHERS IS THE



A NEW FIRE STATION  
FOR THE  
CITY OF ASHFORD  
ASHFORD, ALABAMA

OWNER:  
CITY OF ASHFORD  
525 N BROADWAY STREET  
ASHFORD, ALABAMA 36312

ISSUE: JANUARY 13, 2022  
MARK DATE DESCRIPTION


PROJECT NO: 21-20  
DRAWN BY: PAM GRANTHAM  
CHECKED BY: BRAD JOHNSON

SHEET TITLE

FOUNDATION &  
SCHEMATIC ROOF  
FRAMING PLANS, &  
SECTIONS

S1.1

SHEET 4 OF 5

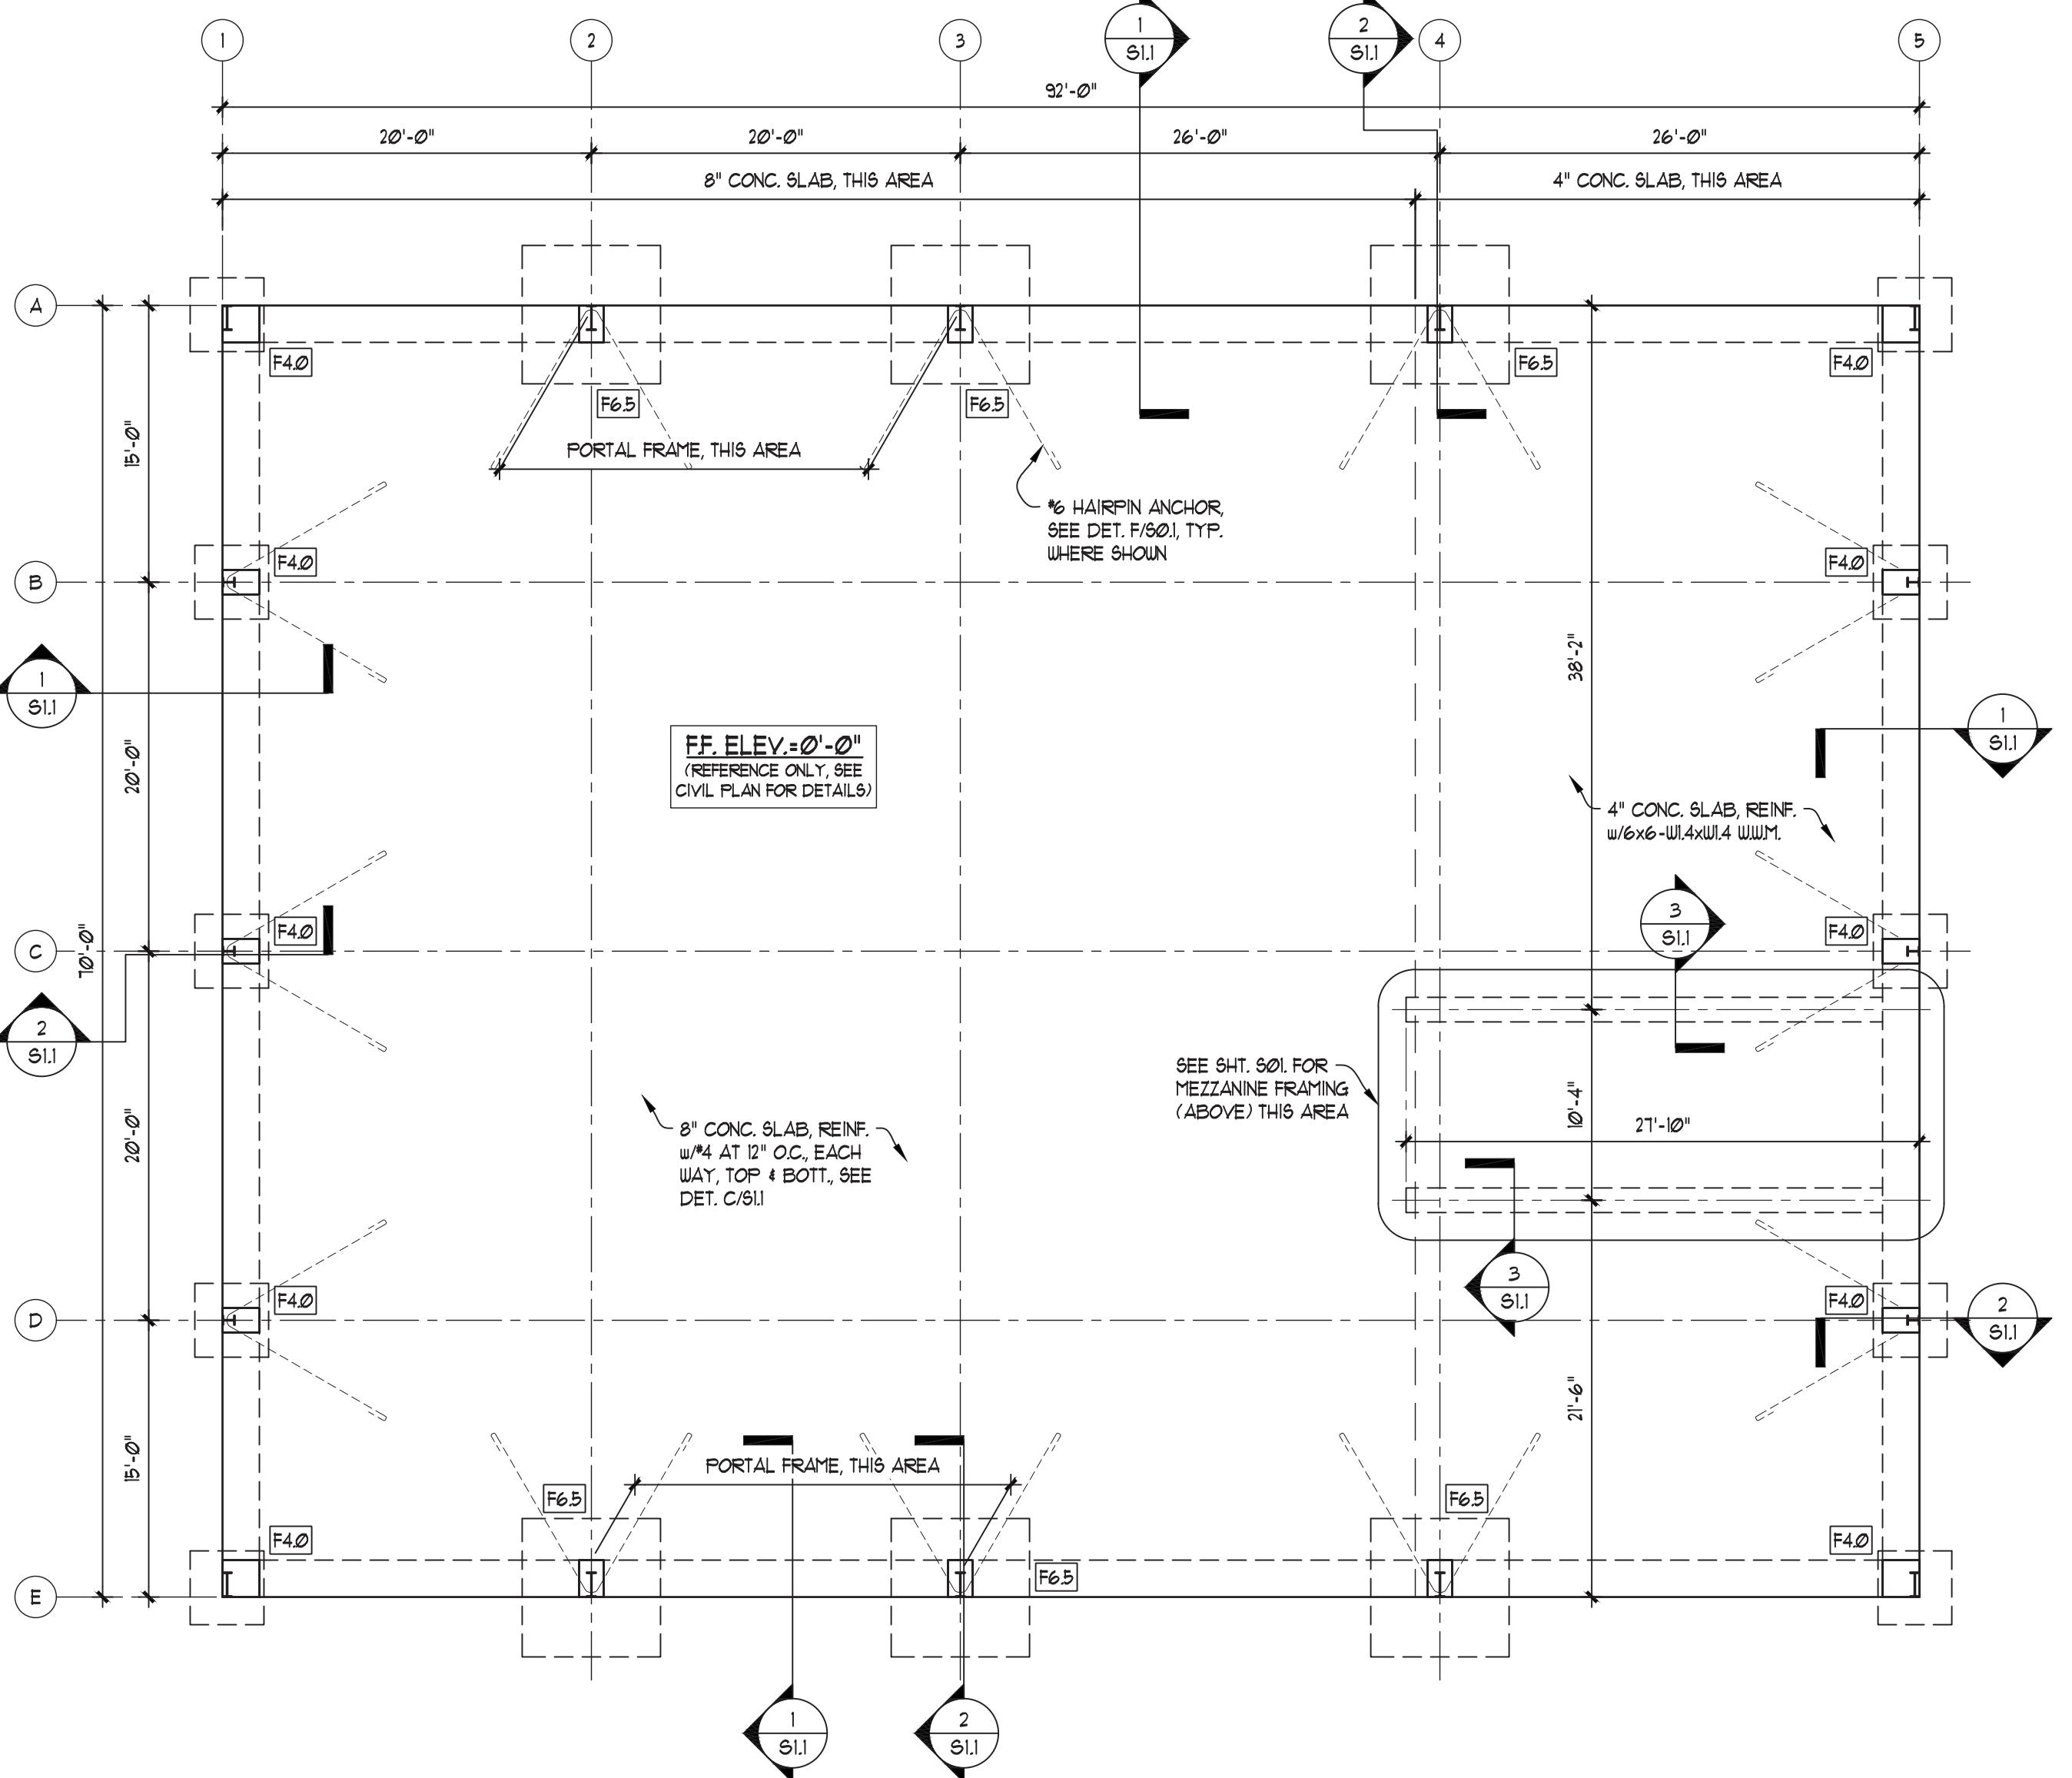


FOOTING SCHEDULE	
MARK No.	FOOTING SIZE & REINF.
F40	4'-0" SQ. x 1'-4" DP, REINF. w/4'-5" EA. WAY, TOP 4 BOTT.
F65	6'-6" SQ. x 1'-9" DP, REINF. w/8'-5" EA. WAY, TOP 4 BOTT.

FOUNDATION PLAN


SCALE: 1/8"=1'-0"

NOTES:


- TOP OF ALL FOOTINGS -1'-4" BELOW FINISH FLOOR UNLESS NOTED OTHERWISE (UNO).
- CJ: CONSTRUCTION JOINT SEE DETAIL A-602. SJ: SAW JOINT, SEE DET. B-602.
- SEE SHEET 601 FOR GENERAL STRUCTURAL NOTES.
- FOUNDATION PLAN PLANE IS SHOWN AT APPROXIMATELY TOP OF SLAB ELEVATION.
- CENTER ALL FOOTINGS BEHIND CENTERLINE OF COLUMN BASE PLATE UNO, NOTE: CENTERLINE OF METAL BUILDING COLUMN AND FOOTING MAY NOT ALIGN WITH THE CENTERLINE OF THE CONCRETE COLUMN PEDESTAL.
- PEMB, COLUMN CONNECTIONS TO THE FOUNDATION SHALL BE DESIGNED AS PINNED CONNECTIONS, NO MOMENT SHALL BE TRANSFERRED TO THE FOUNDATION.
- PEMB SHALL LOCATE ANCHOR BOLTS NO CLOSER THAN 4" TO EDGE OF SLAB (MEASURED FROM CENTERLINE OF ANCHOR BOLTS TO EDGE OF SLAB).

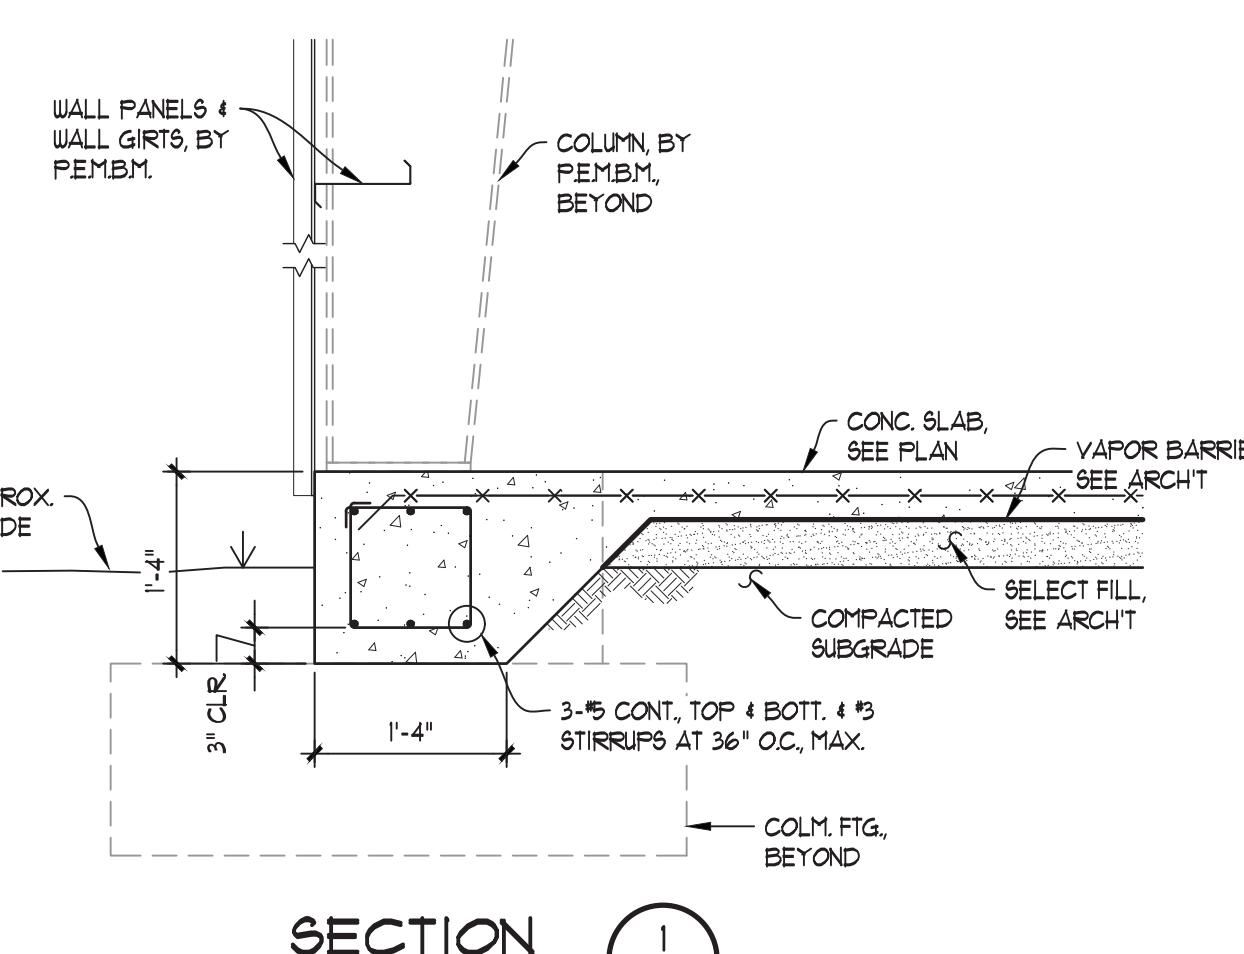

SECTION  
SCALE: 3/4"=1'-0"

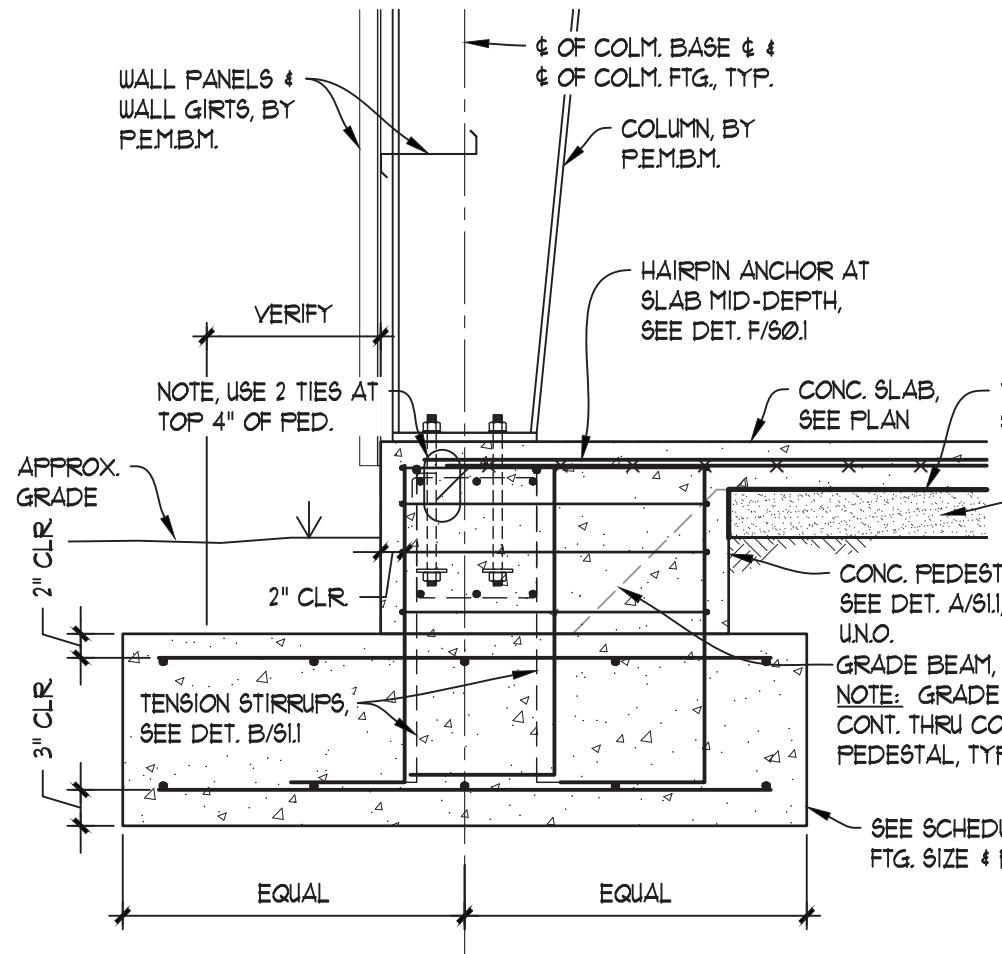


SECTION  
SCALE: 3/4"=1'-0"


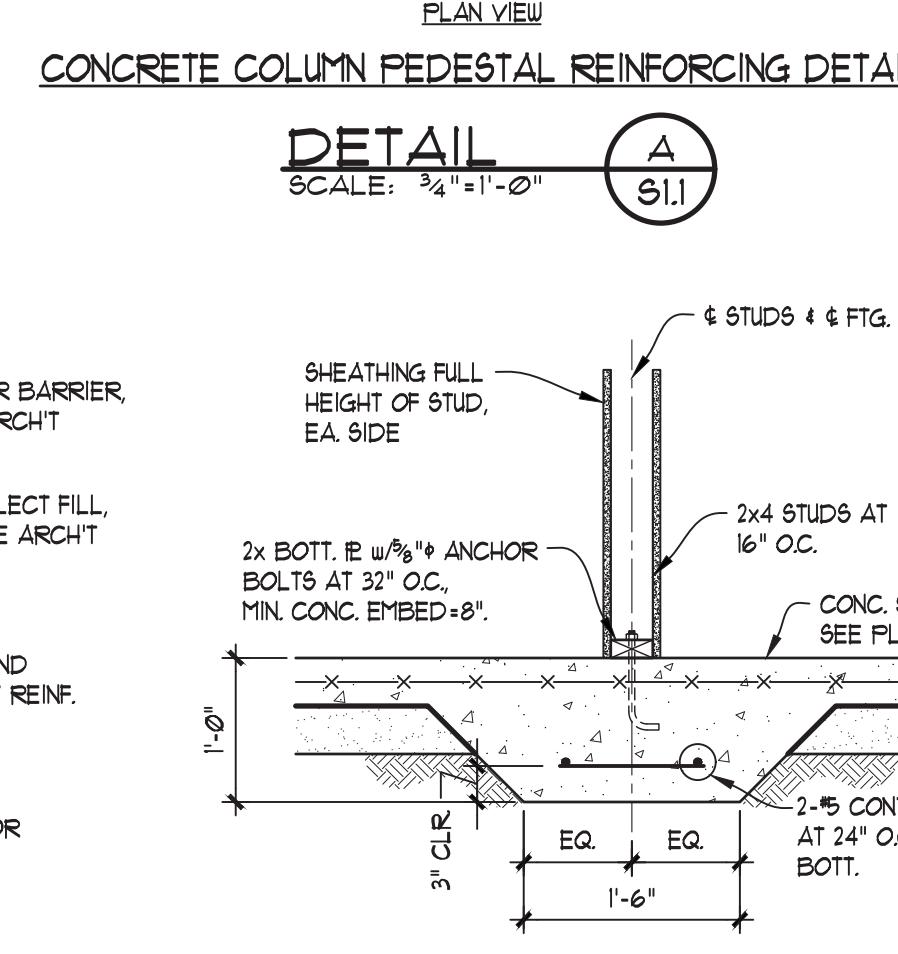


SECTION  
SCALE: 3/4"=1'-0"

PLAN VIEW  
CONCRETE COLUMN PEDESTAL REINFORCING DETAIL  
DETAIL  
SCALE: 3/4"=1'-0"

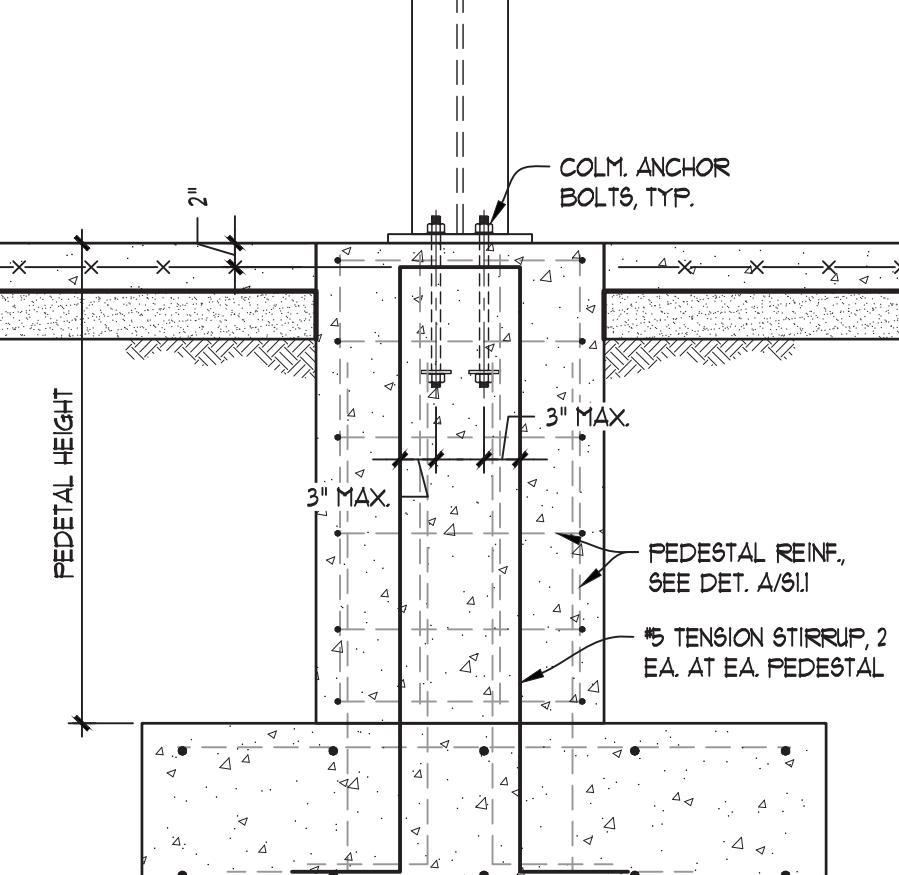

SECTION VIEW  
TENSION STIRRUP AT PEDESTAL  
DETAIL  
SCALE: 3/4"=1'-0"

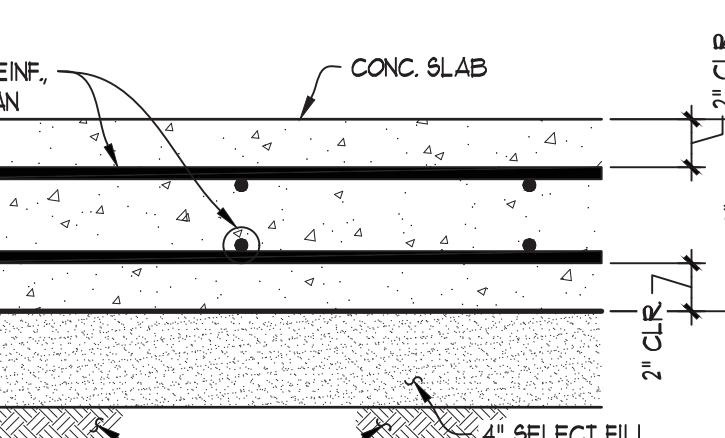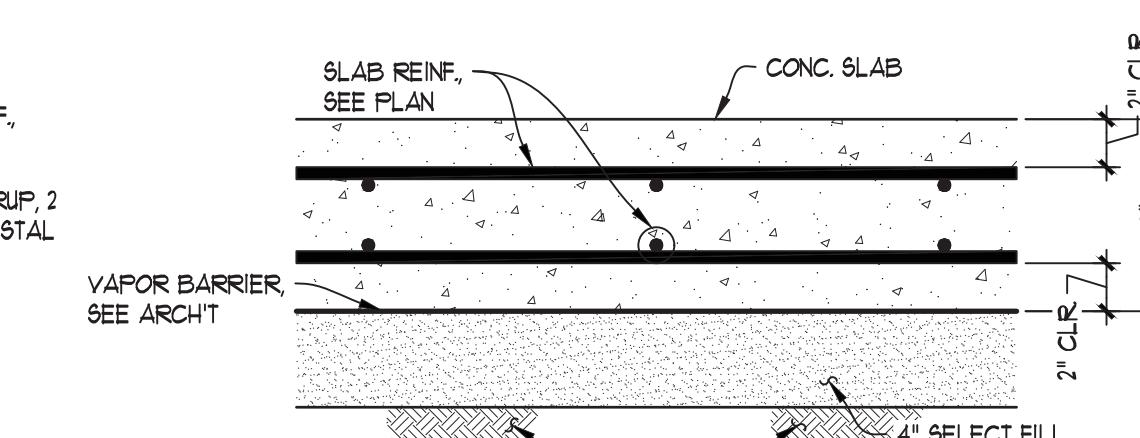


SCHEMATIC ROOF FRAMING PLAN

SCALE: 1/8"=1'-0"

NOTES:

- ROOF FRAMING PLAN SHOWN IS SCHEMATIC IN NATURE ONLY. MANUFACTURER/SUPPLIER IS SOLELY RESPONSIBLE FOR FINAL ROOF FRAMING LAYOUT AND DESIGN. CONTACT THE STRUCTURAL ENGINEER OF RECORD PRIOR TO CHANGING ANY ASPECT OF THE ROOF FRAMING DEPICTED ON THIS PLAN.
- SEE SHEET 601 FOR GENERAL STRUCTURAL NOTES.
- SEE ARCHITECTURAL DRAWINGS FOR DIMENSIONS AND DETAILS NOT SHOWN.

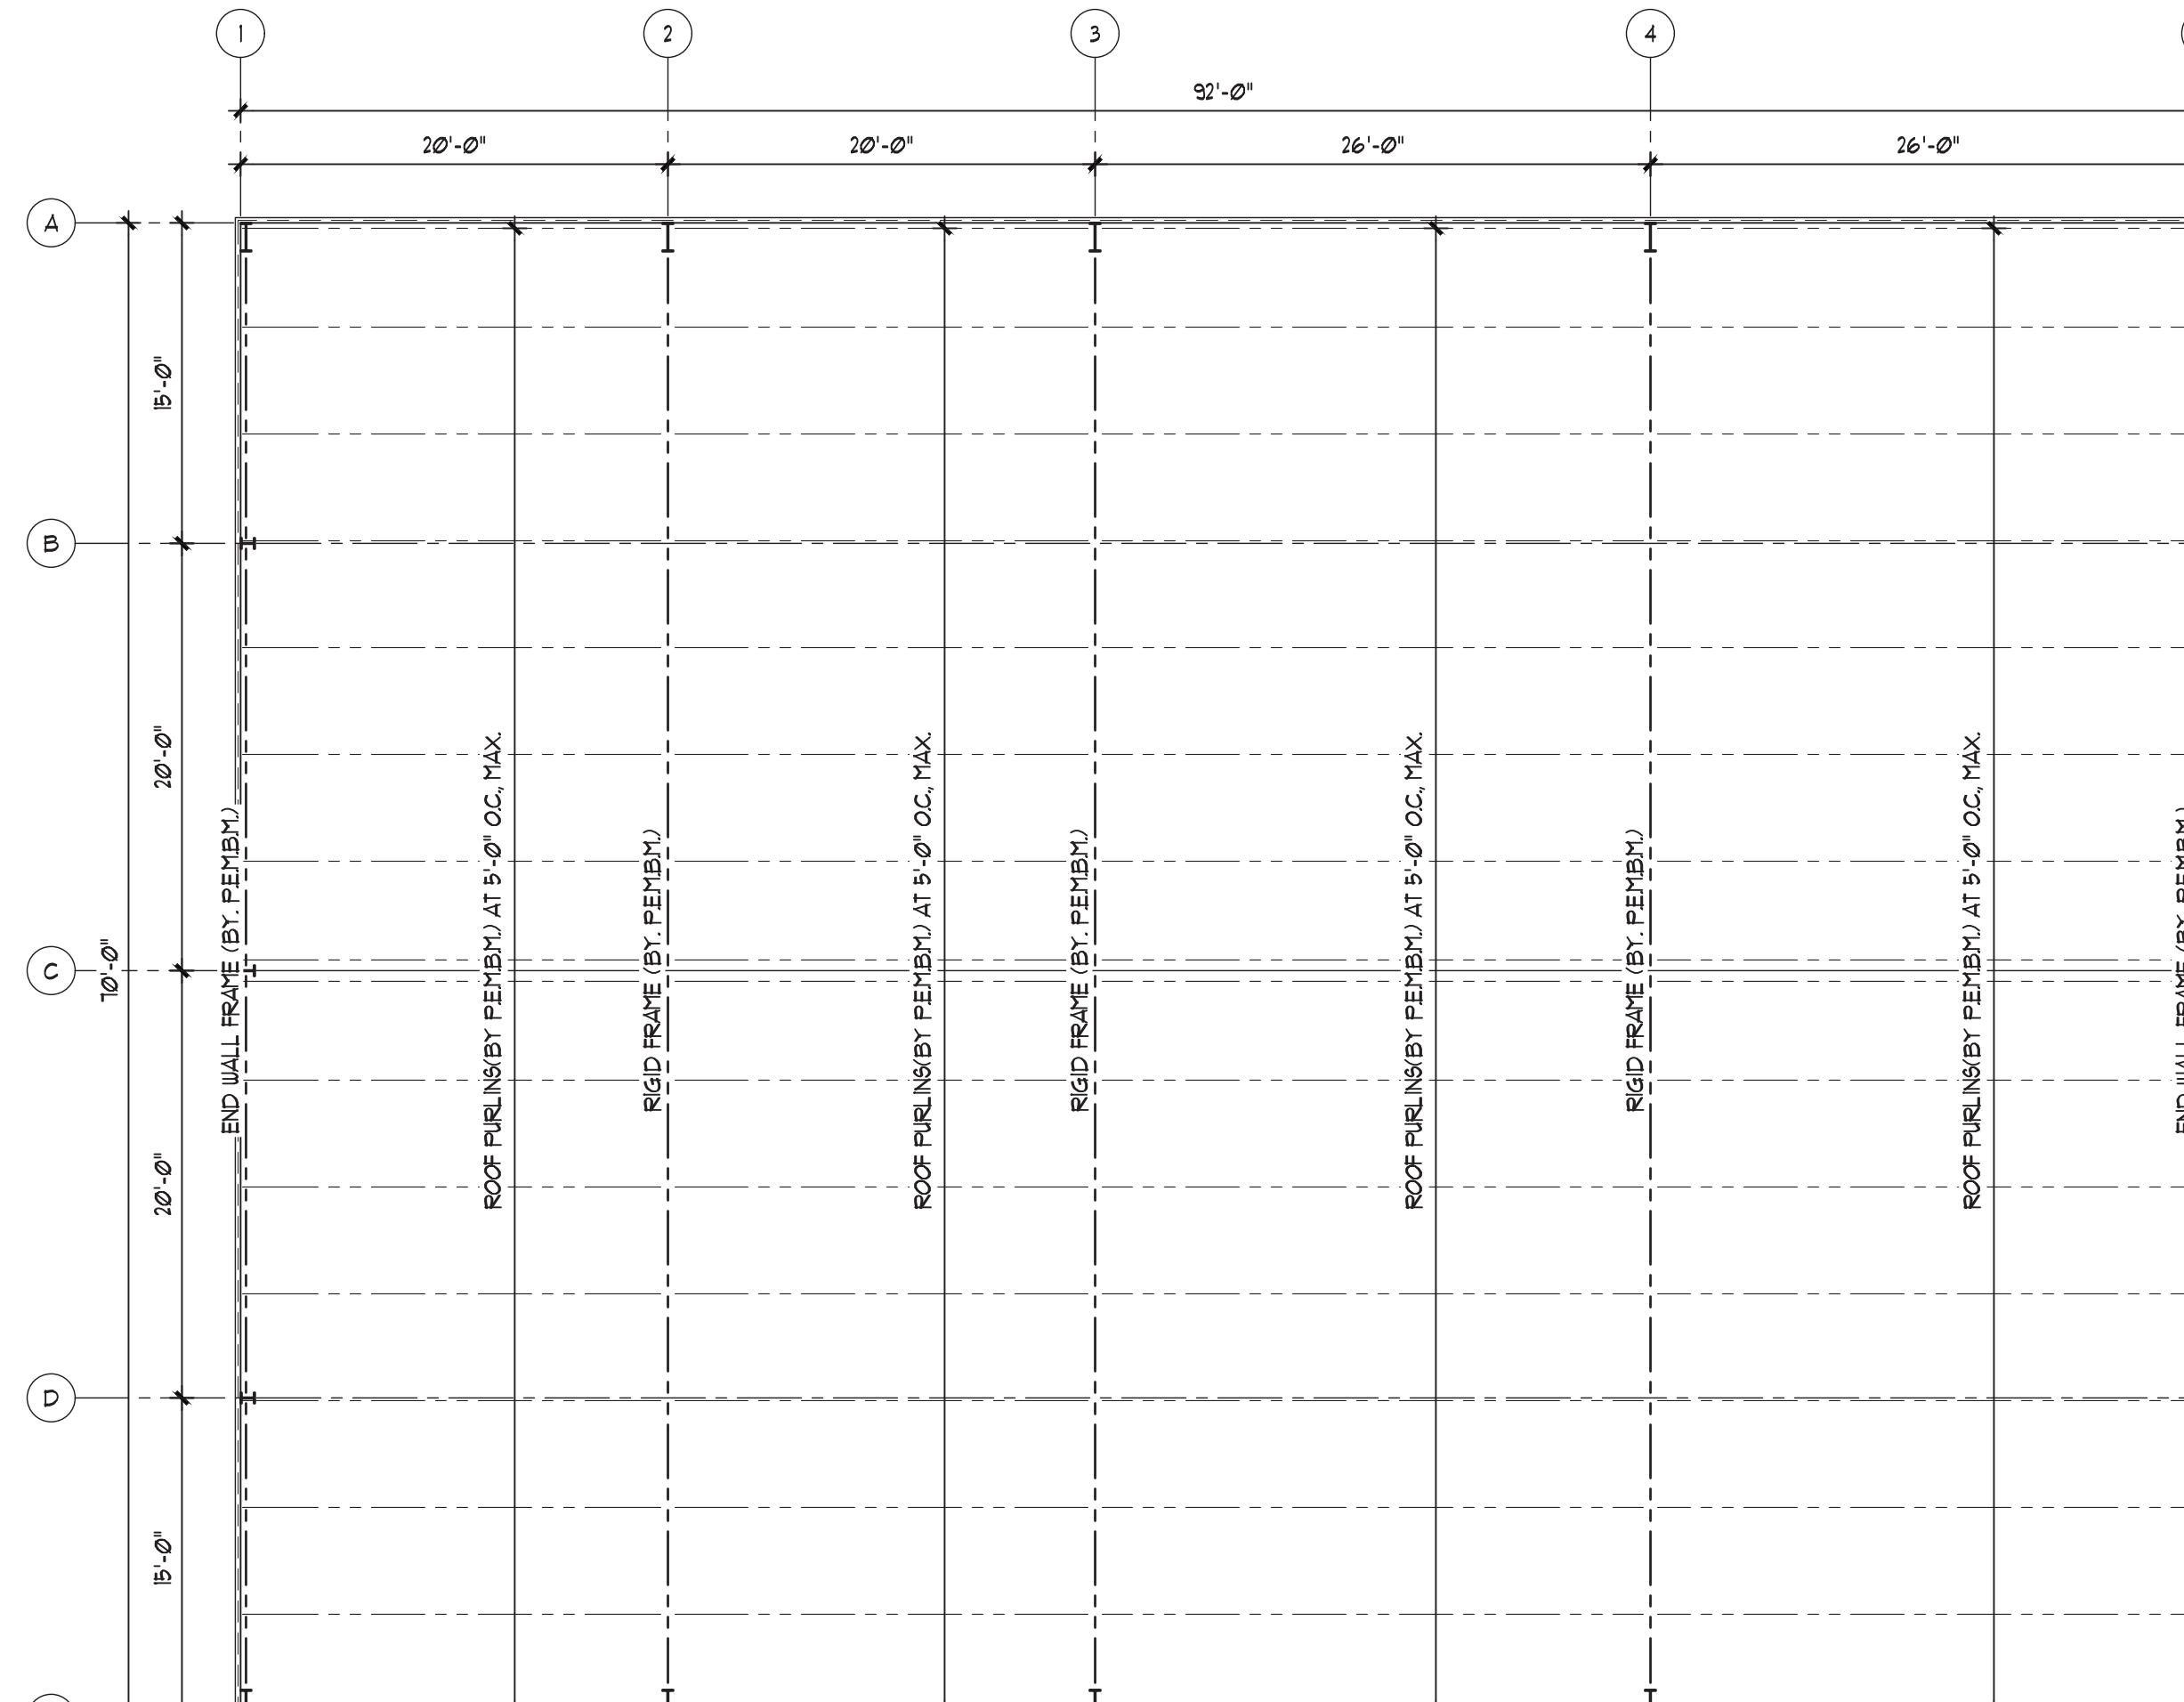



SCHEMATIC ROOF FRAMING PLAN

SCALE: 1/8"=1'-0"


NOTES:

- FULL COLUMN BASE BEARING ON CONC. PEDESTAL, 4" TO MAINTAIN A MINIMUM 4" FROM EDGE OF CONC. PEDESTAL TO 4" OF ANCHOR BOLTS.
- PEMB, COLUMN CONNECTIONS TO THE FOUNDATION SHALL BE DESIGNED AS PINNED CONNECTIONS, NO MOMENT SHALL BE TRANSFERRED TO THE FOUNDATION.
- PEMB SHALL LOCATE ANCHOR BOLTS NO CLOSER THAN 4" TO EDGE OF SLAB (MEASURED FROM CENTERLINE OF ANCHOR BOLTS TO EDGE OF SLAB).

PLAN VIEW  
CONCRETE COLUMN PEDESTAL REINFORCING DETAIL  
DETAIL  
SCALE: 3/4"=1'-0"

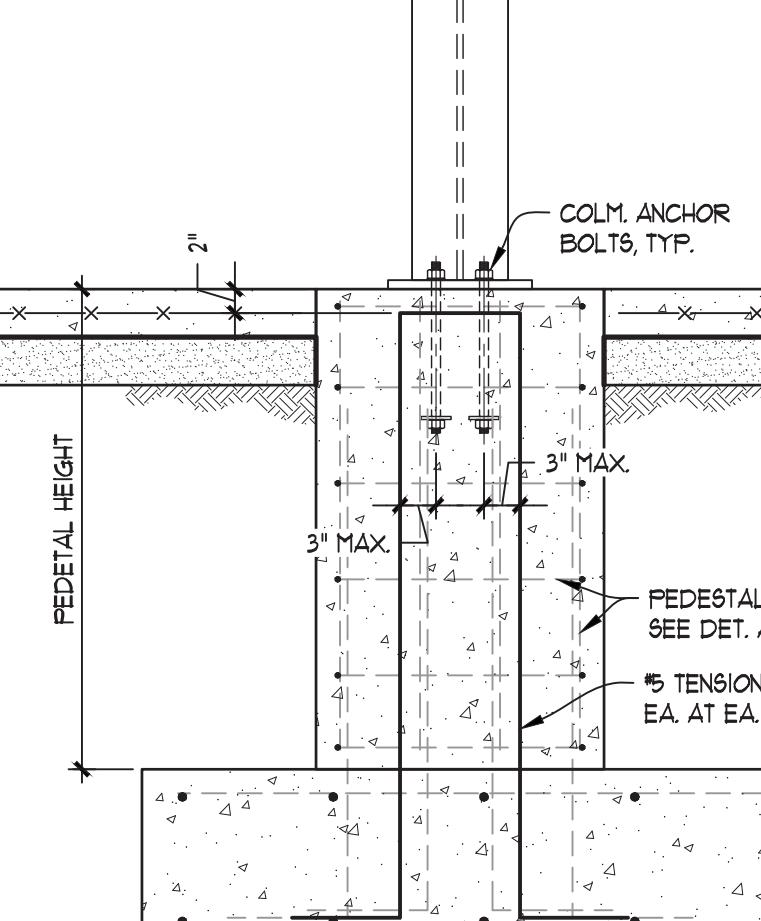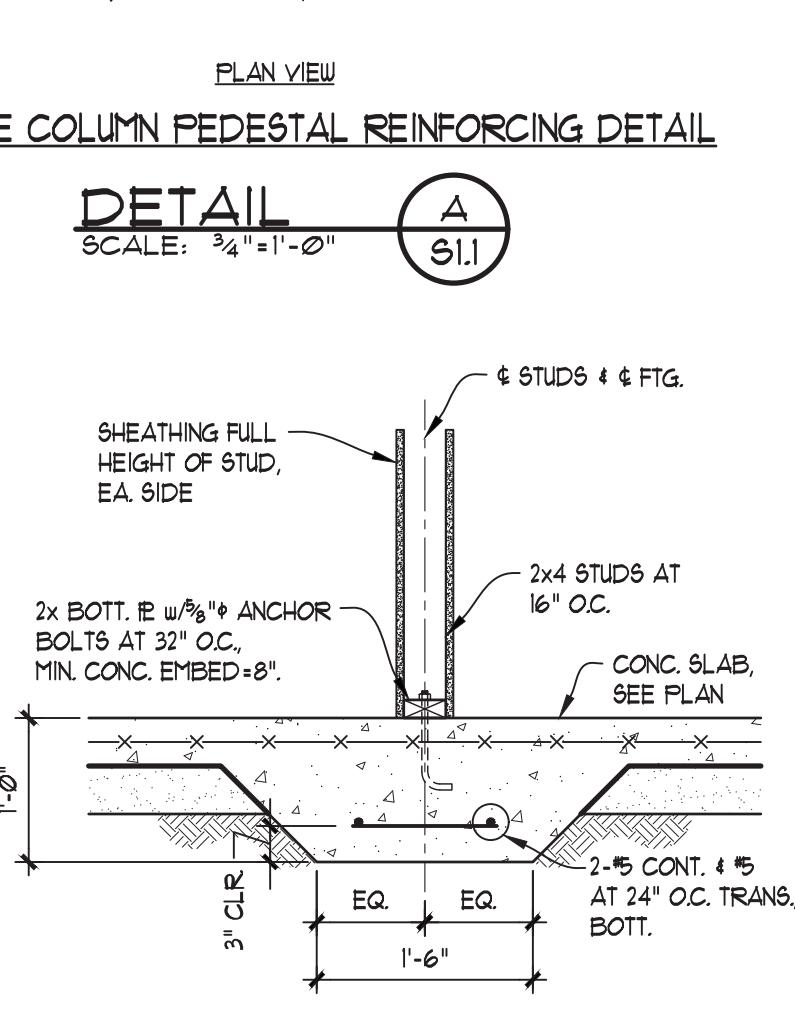


SECTION VIEW  
TENSION STIRRUP AT PEDESTAL  
DETAIL  
SCALE: 3/4"=1'-0"

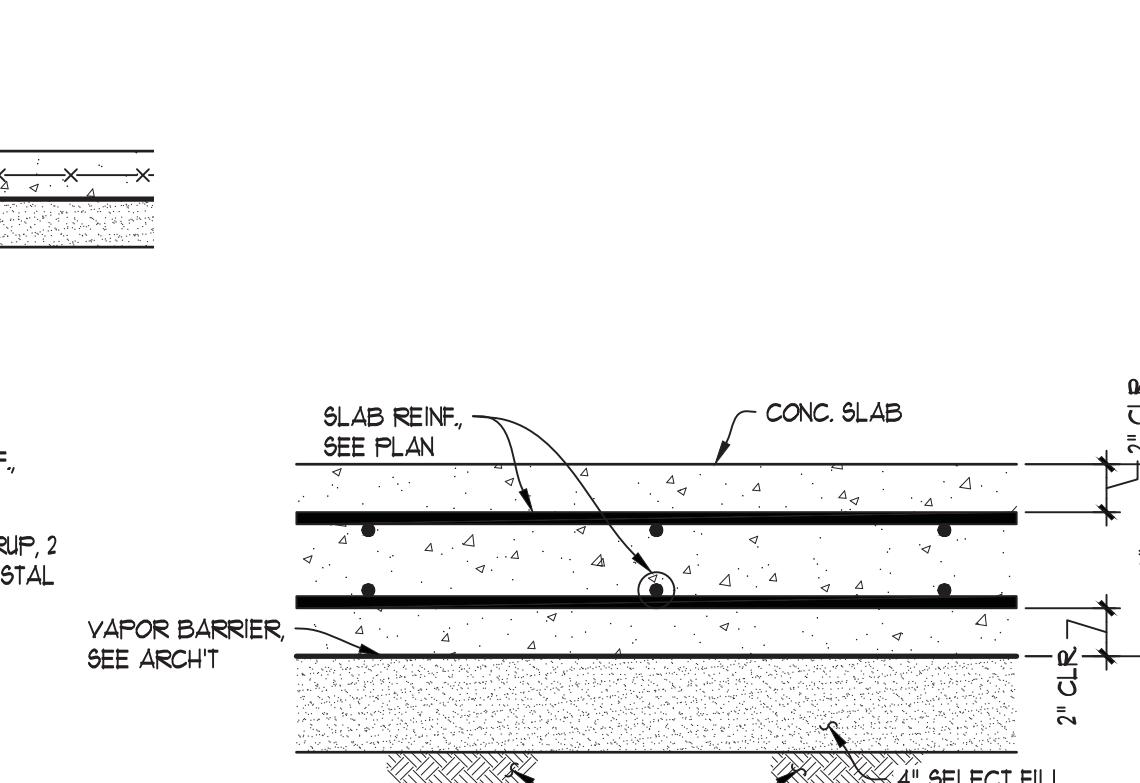


SECTION VIEW  
8" SLAB DETAIL  
DETAIL  
SCALE: 1/2"=1'-0"

S1.1

SHEET 4 OF 5

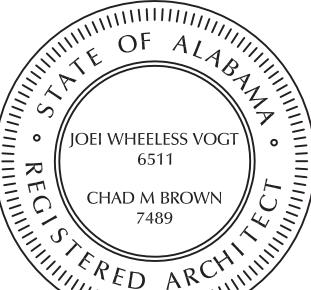
A NEW FIRE STATION  
FOR THE  
CITY OF ASHFORD  
ASHFORD, ALABAMA

OWNER:

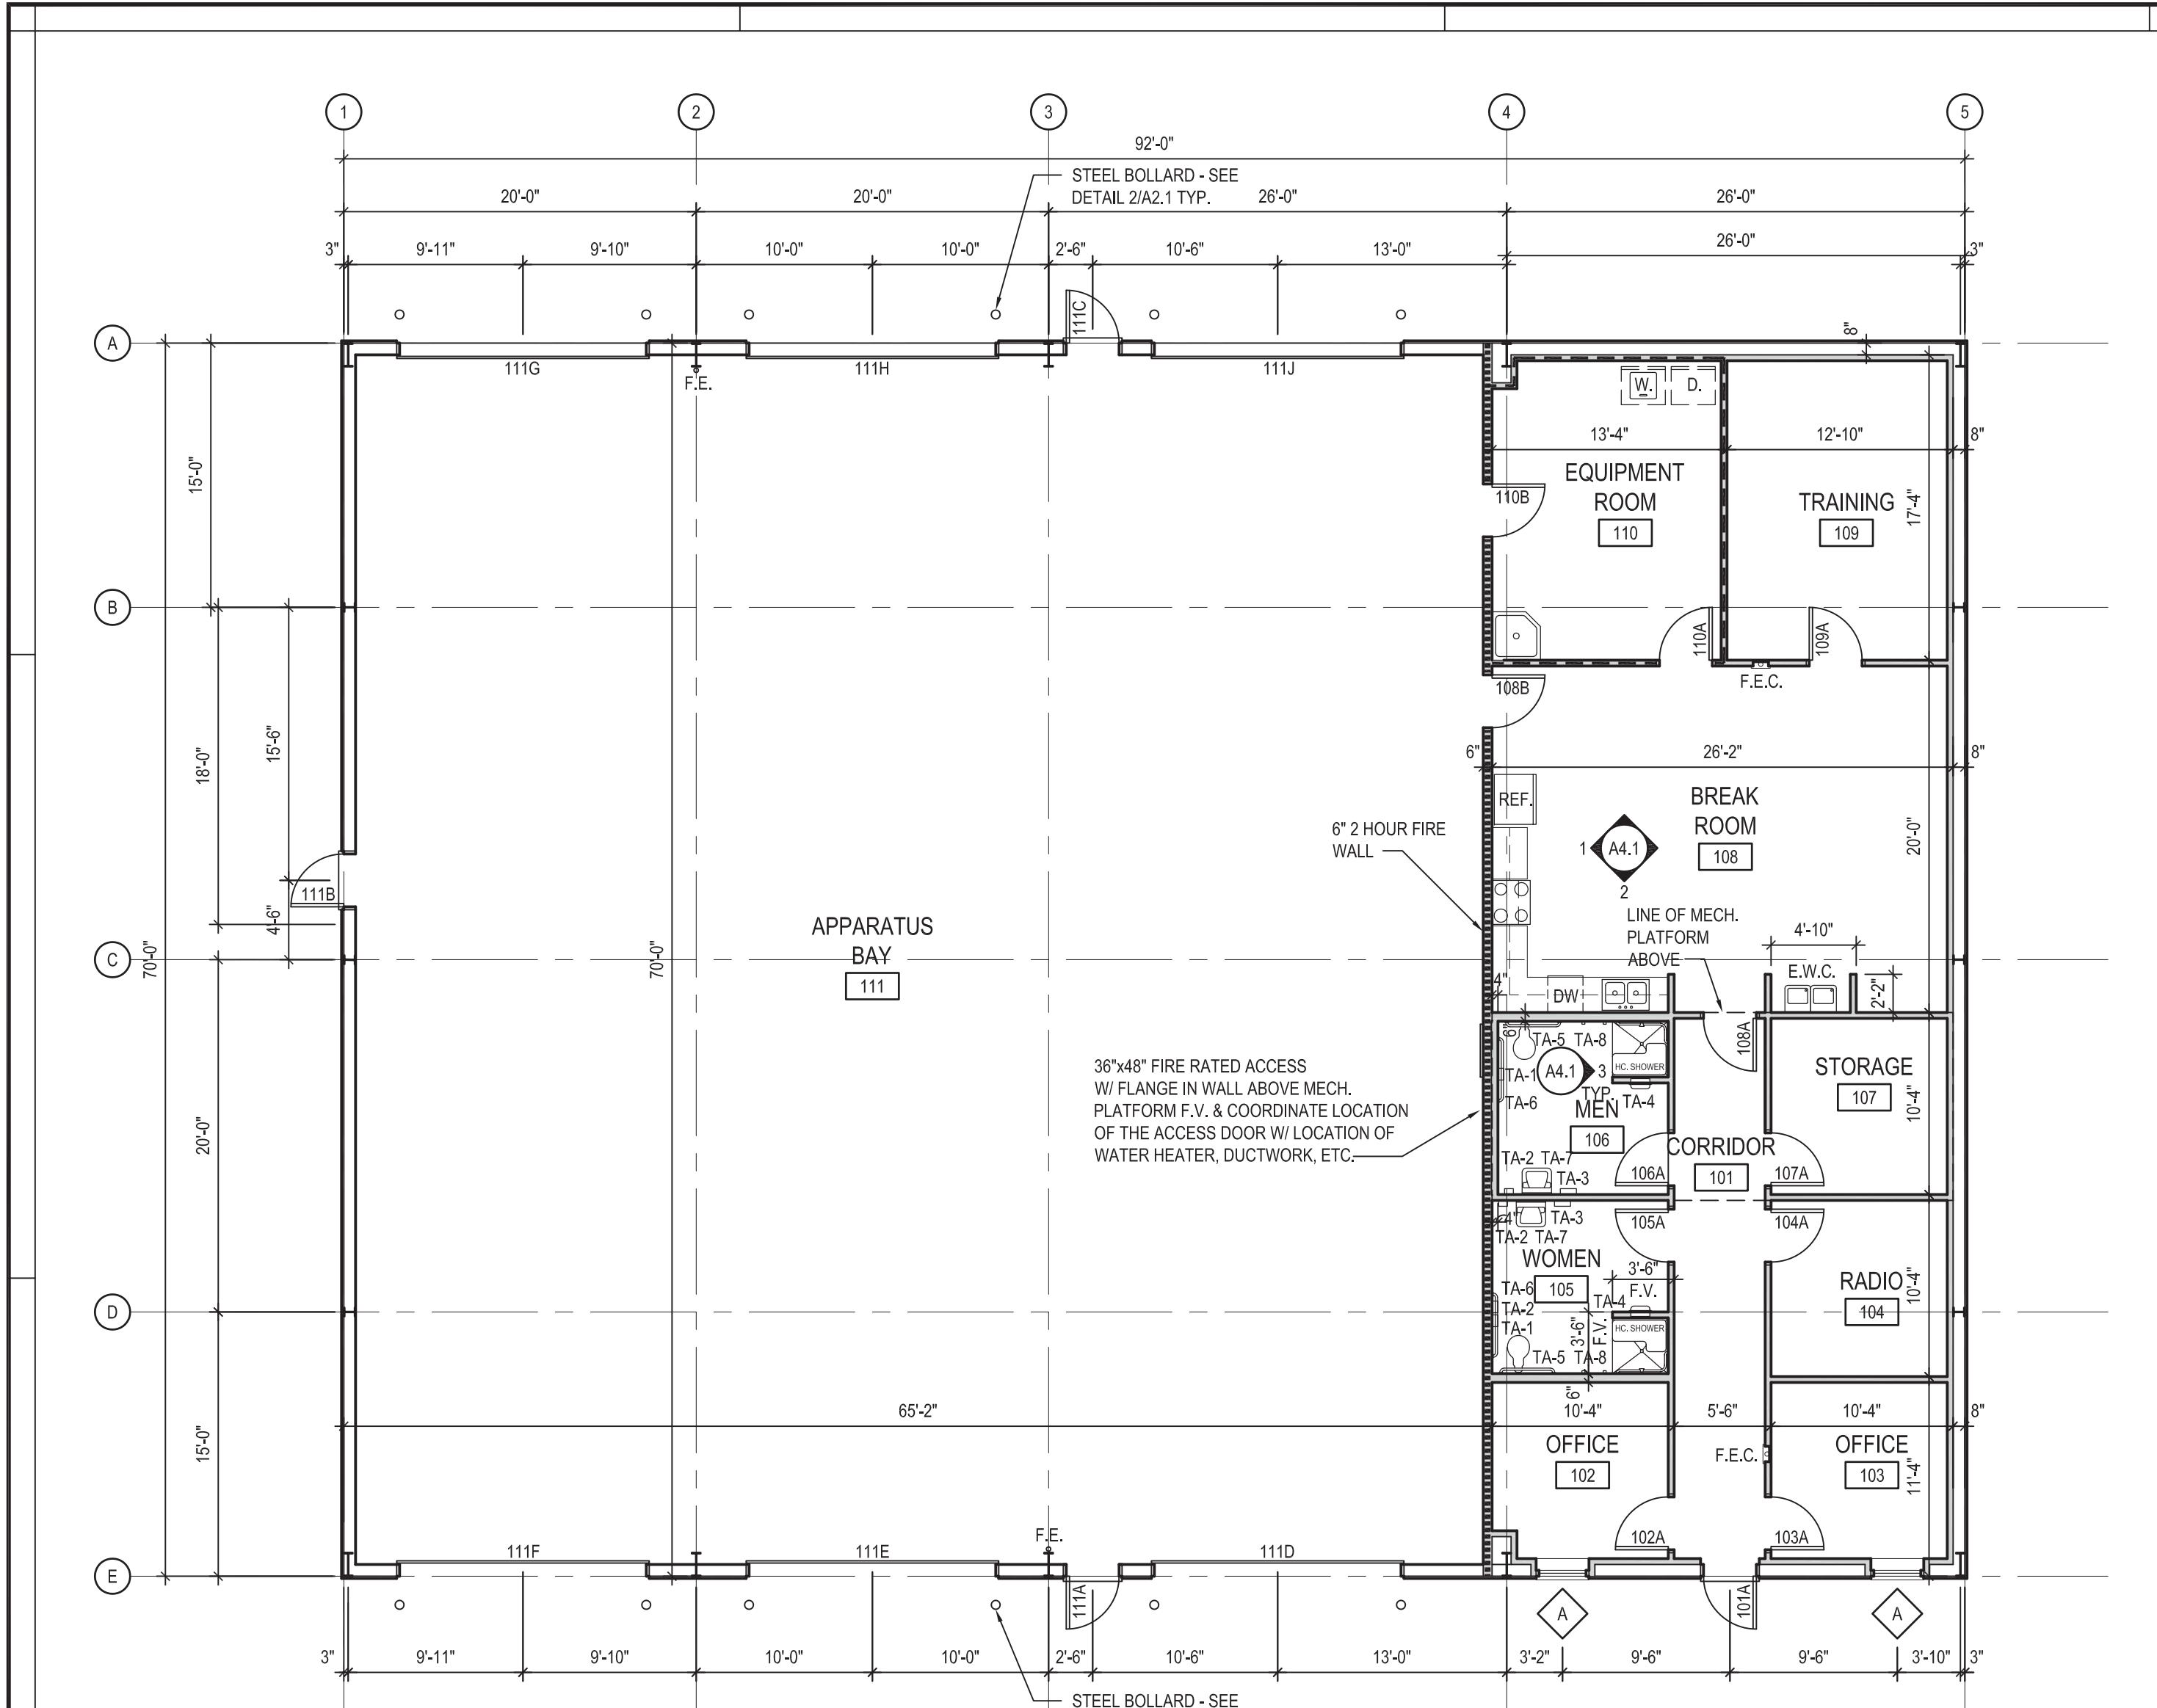CITY OF ASHFORD  
525 N BROADWAY STREET  
ASHFORD, ALABAMA 36312ISSUE: APRIL 19, 2022  
MARK DATE DESCRIPTIONPROJECT NO: 21-20  
DRAWN BY: CHAD M. BROWN / JAMEY AVERY  
CHECKED BY: CHAD M. BROWN  
SHEET TITLEFLOOR PLAN,  
DOOR, FINISH  
SCHEDULES &  
DETAILS  
A.1.1  
SHEET 1 OF 5


## FLOOR PLAN

SCALE: 1/8" = 1'-0"

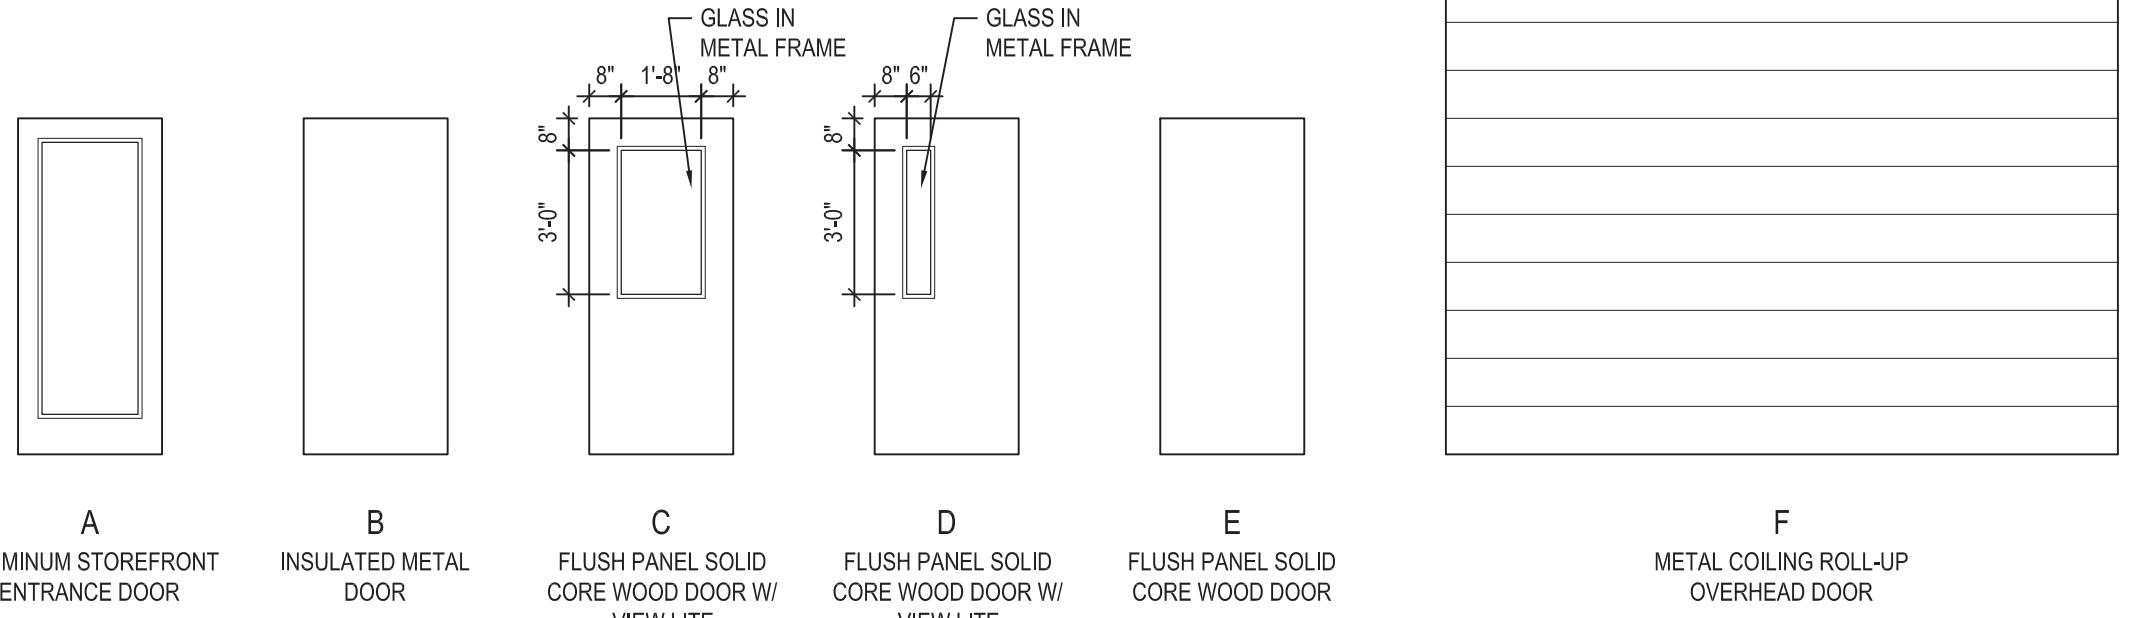

## DOOR ELEVATIONS

SCALE: 1/4" = 1'-0"

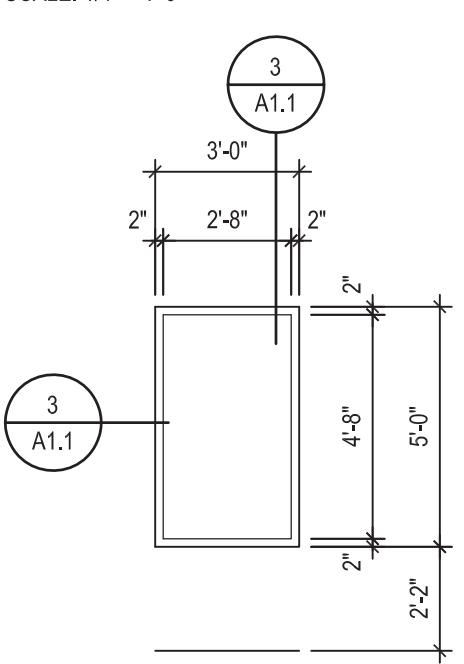

## WINDOW ELEVATION


SCALE: 1/4" = 1'-0"

## DETAIL - DOOR HEAD


SCALE: 1 1/2" = 1'-0"

## DETAIL - DOOR JAMB


SCALE: 1 1/2" = 1'-0"

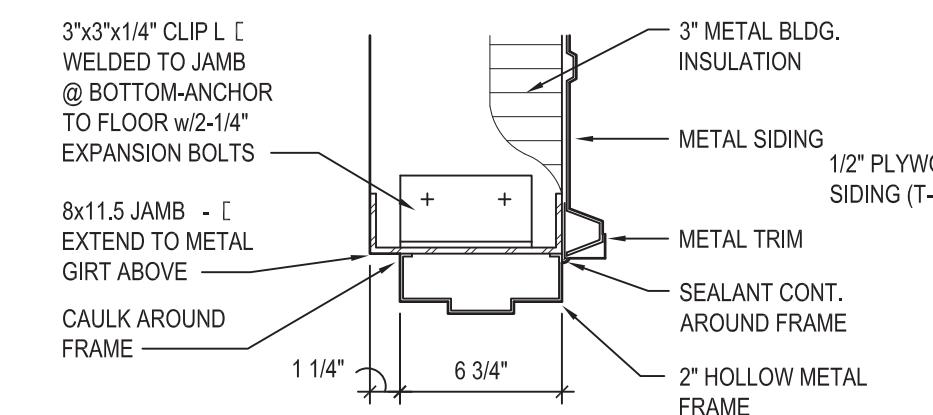DETAIL - EXTERIOR  
DOOR JAMB (HEAD SIM.)


SCALE: 1 1/2" = 1'-0"

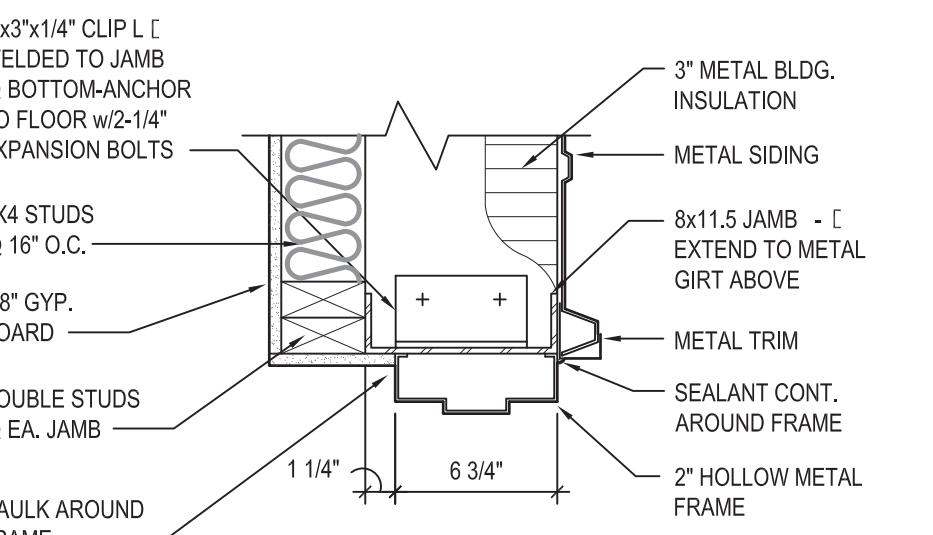DETAIL - EXTERIOR  
DOOR JAMB (HEAD SIM.)

SCALE: 1 1/2" = 1'-0"

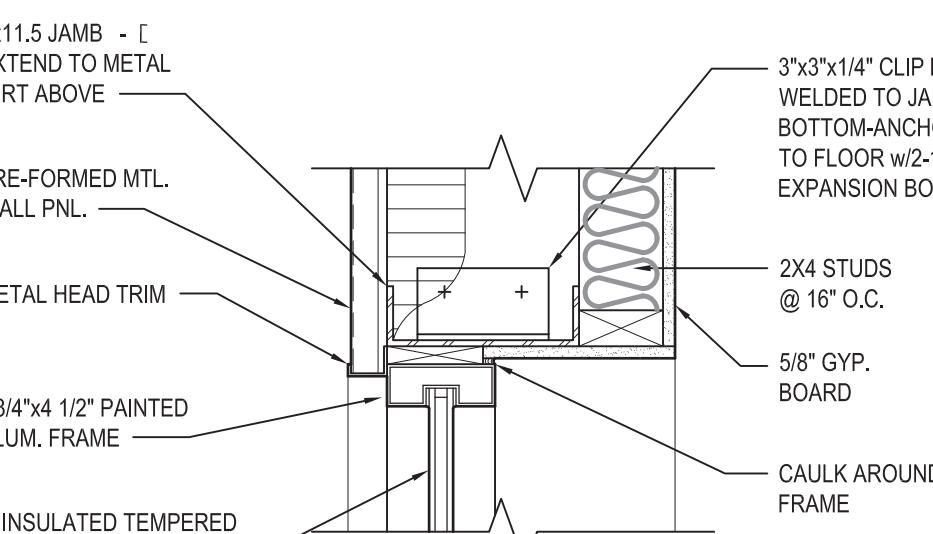DETAIL - EXTERIOR WINDOW /  
DOOR JAMB (HEAD / SILL SIM.)

SCALE: 1 1/2" = 1'-0"

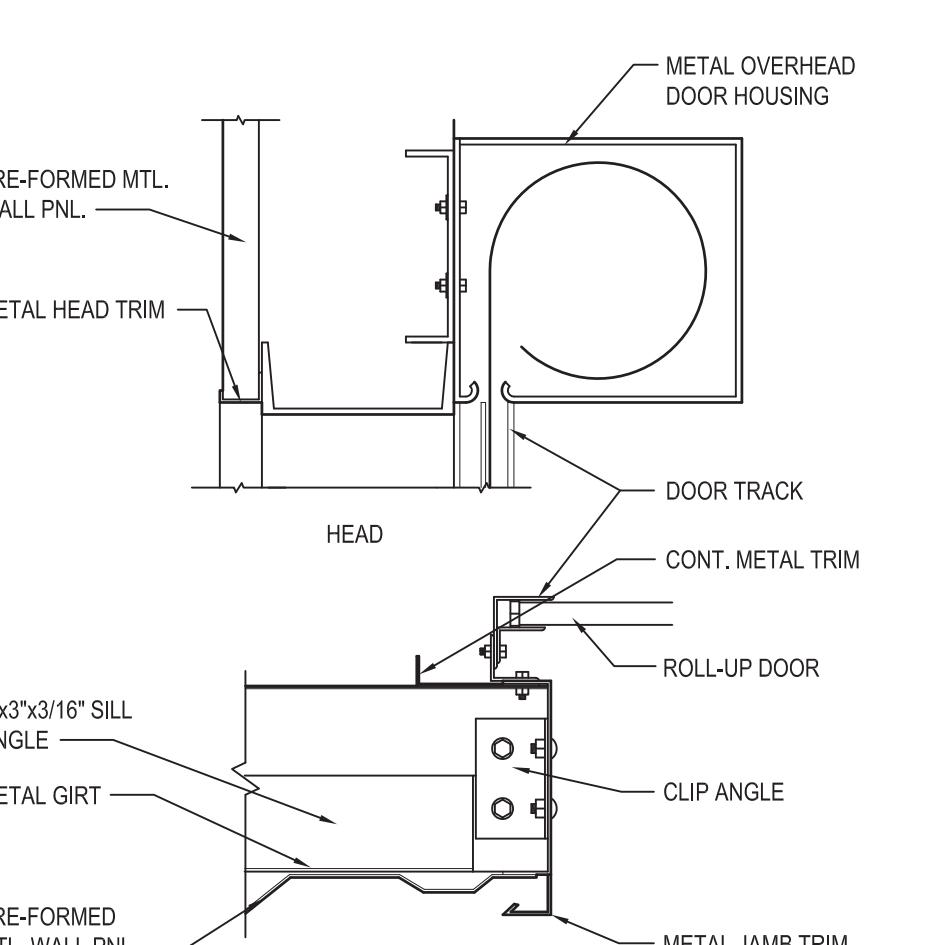

## DETAIL @ ROLL-UP DOOR

SCALE: 1 1/2" = 1'-0"



## DOOR AND FRAME SCHEDULE

MARK	DOOR			FRAME			DETAIL	FIRE RATING LABEL	HARD- WARE SET NO	NOTES
	W	HT	THK	MATL	EL	GLZ				
101A	3'-0"	7'-0"	1 3/4"	ALUM.	A	S.G.	ALUM.	2/A1.1 SIM.	1	1
102A	3'-0"	7'-0"	1 3/4"	WOOD	D	S.G.	H.M.	5/A1.1	6/A1.1	1
103A	3'-0"	7'-0"	1 3/4"	WOOD	D	S.G.	H.M.	5/A1.1	6/A1.1	2
104A	3'-0"	7'-0"	1 3/4"	WOOD	D	S.G.	H.M.	5/A1.1	6/A1.1	1
105A	3'-0"	7'-0"	1 3/4"	WOOD	E	H.M.	5/A1.1	6/A1.1	3	
106A	3'-0"	7'-0"	1 3/4"	WOOD	E	H.M.	5/A1.1	6/A1.1	3	
107A	3'-0"	7'-0"	1 3/4"	WOOD	E	H.M.	5/A1.1	6/A1.1	4	
108A	3'-0"	7'-0"	1 3/4"	WOOD	C	S.G.	H.M.	5/A1.1	6/A1.1	6
108B	3'-0"	7'-0"	1 3/4"	WOOD	C	F.G.	H.M.	5/A1.1	6/A1.1	7
109A	3'-0"	7'-0"	1 3/4"	WOOD	D	S.G.	H.M.	5/A1.1	6/A1.1	2
110A	3'-0"	7'-0"	1 3/4"	WOOD	E	H.M.	5/A1.1	6/A1.1	20 MIN.	
110B	3'-0"	7'-0"	1 3/4"	WOOD	E	H.M.	5/A1.1	6/A1.1	90 MIN.	
111A	3'-0"	7'-0"	1 3/4"	METAL	B	H.M.	1/A1.1	1/A1.1 SIM.	7	2
111B	3'-0"	7'-0"	1 3/4"	METAL	B	H.M.	1/A1.1	1/A1.1 SIM.	7	2
111C	3'-0"	7'-0"	1 3/4"	METAL	B	H.M.	1/A1.1	1/A1.1 SIM.	7	2
111D	14'-0"	12'-0"		METAL	F	METAL	4/A1.1	4/A1.1 SIM.	8	
111E	14'-0"	12'-0"		METAL	F	METAL	4/A1.1	4/A1.1 SIM.	8	
111F	14'-0"	12'-0"		METAL	F	METAL	4/A1.1	4/A1.1 SIM.	8	
111G	14'-0"	12'-0"		METAL	F	METAL	4/A1.1	4/A1.1 SIM.	8	
111H	14'-0"	12'-0"		METAL	F	METAL	4/A1.1	4/A1.1 SIM.	8	
111J	14'-0"	12'-0"		METAL	F	METAL	4/A1.1	4/A1.1 SIM.	8	

## DOOR AND WINDOW NOTES:

1. ALL DOORS AND WINDOWS TO HAVE SAFETY GLASS WHERE REQUIRED BY CODE.
2. PROVIDED BY METAL BUILDING MANUFACTURER.

## ROOM FINISH SCHEDULE

ROOM NO	ROOM NAME	FLOOR	BASE	WALLS		CEILING		NOTES
				MATL	FIN	MATL	FIN	
101	CORRIDOR	B	D	E	P1	F		9'-0"
102	OFFICE	B	D	E	P1	F		9'-0"
103	OFFICE	B	D	E	P1	F		9'-0"
104	RADIO	B	D	E	P1	F		9'-0"
105	WOMEN'S RESTROOM	C	C	E	P1	F		9'-0"
106	MEN'S RESTROOM	C	C	E	P1	F		9'-0"
107	STORAGE	B	D	E	P1	F		9'-0"
108	BREAK ROOM	B	D	E	P1	F		10'-0"
109	TRAINING	B	D	E	P1	F		10'-0"
110	EQUIPMENT ROOM	A	D	E	P1	F		10'-0"
111	APPARATUS BAY	A		G		G		VARIES

## MATERIAL KEY

A	CONCRETE SEALED
B	LUXURY VINYL TILE
C	PORCELAIN TILE
D	4" VINYL BASE
E	GYPSUM BOARD
F	LAY-IN ACOUSTICAL TILE
G	EXPOSED STRUCTURE

## FINISH KEY

P1	PAINT, SEMI-GLOSS
----	-------------------

GENERAL FINISH NOTES:

1. CONTRACTOR SHALL VERIFY ALL FINISHES WITH OWNER / ARCHITECT.
2. CONTRACTOR SHALL BE RESPONSIBLE FOR INSTALLING/APPLYING ALL FINISHES SCHEDULED AND/OR SPECIFIED.
3. PROVIDE TRANSITIONAL EDGE STRIP AT ALL JOINTS BETWEEN ANY DISIMILAR MATERIALS, AND WHEREVER POSSIBLE, EXECUTE TRANSITION UNDER CENTERLINE OF DOOR IN CLOSED POSITION.
4. CENTER TILE PATTERN IN BOTH DIRECTIONS IN EACH ROOM, UNLESS INDICATED OTHERWISE.

## GENERAL SHEET NOTES

1. GENERAL CONTRACTOR SHALL VERIFY ALL DIMENSIONS AND SITE CONDITIONS PRIOR TO BEGINNING ANY WORK AND SHALL NOTIFY THE ARCHITECT OF ANY DISCREPANCIES WHICH ARE ENCOUNTERED.
2. SEE FOUNDATION FOR NOTES AND ADDITIONAL REQUIREMENTS. SEE PLUMBING, MECHANICAL AND ELECTRICAL DRAWINGS FOR RELATED NOTES.
3. ALL WORK SHALL COMPLY WITH THE REQUIREMENTS OF THE 2017 FLORIDA BUILDING CODE AND THE LOCAL BUILDING OFFICIALS OFFICE. VERIFY REQUIREMENTS PRIOR TO BIDDING.
4. ALL DIMENSIONS ARE TO THE FACE OF STUDS AND FACE OF CONCRETE UNLESS OTHERWISE NOTED.
5. ANCHORS, FASTENERS AND NAILING SHALL COMPLY WITH THE RECOMMENDATIONS OF THE NATIONAL FOREST PRODUCTS ASSOCIATION'S "MANUAL FOR HOUSE FRAMING" AND IN ACCORDANCE WITH THE REQUIREMENTS OF THE 2015 INTERNATIONAL BUILDING CODE, BUT IN NO CASE LESS THAN THAT SHOWN ON THE DRAWINGS.
6. CONTRACTOR SHALL COORDINATE ALL FRAMING WITH OTHER TRADES IN ORDER TO AVOID ALL UNNECESSARY CUTTING AND MODIFICATIONS. CONTRACTOR SHALL INSTALL BLOCKING AS REQUIRED TO ANCHOR HARDWARE, ACCESSORIES, SPECIALTIES, EQUIPMENT, ETC.
7. STRUCTURAL STEEL SHALL CONFORM TO ASTM A36. STRUCTURAL STEEL SHALL BE FABRICATED AND ERECTED IN ACCORDANCE WITH THE AISC "SPECIFICATIONS FOR THE DESIGN, FABRICATION AND ERECTION OF STRUCTURAL STEEL FOR BUILDINGS".
8. GENERAL CONTRACTOR SHALL INSTALL FOUNDATIONS AND ANCHOR BOLTS FOR METAL BUILDING COLUMNS WHICH SHALL BE FURNISHED BY THE METAL BUILDING CONTRACTOR. GENERAL CONTRACTOR SHALL VERIFY ALL REQUIREMENTS WITH METAL BUILDING CONTRACTOR.
9. METAL BUILDING CONTRACTOR SHALL FURNISH AND INSTALL ALL STEEL COLUMNS, ROOF FRAMING, WALL GIRT FRAMING, ROOF PANELS, METAL SIDING, FASCIA'S, FLASHING, ETC.
10. GENERAL CONTRACTOR SHALL POUR ALL CONCRETE FLOORS, WALKS AND PAVING AND SHALL ERECT ALL NON-STRUCTURAL WALLS AND INSTALL ALL INTERIOR AND EXTERIOR FINISHES OTHER THAN THOSE PROVIDED BY THE METAL BUILDING CONTRACTOR.
11. PROVIDE 3 1/2" SOUND ATTENUATION BATT INSULATION @ ALL WALLS. PROVIDE 3 1/2" UN-FACED BATT INSULATION ABOVE CEILING.
12. INTERIOR NON-LOAD BEARING WALLS SHALL BE EXTEND 6" ABOVE ACOUSTICAL CEILING GRID. ALL RATED WALLS TO BE EXTEND TO THE UNDERSIDE OF STRUCTURE.



A NEW FIRE STATION  
FOR THE  
CITY OF ASHFORD  
ASHFORD, ALABAMA

OWNER:

CITY OF ASHFORD  
525 N BROADWAY STREET  
ASHFORD, ALABAMA 36312


ISSUE:	APRIL 19, 2022	
MARK	DATE	DESCRIPTION

PROJECT NO:	21-20
DRAWN BY:	JAMEY AVERY
CHECKED BY:	CHAD M. BROWN
SHEET TITLE	

REFLECTED  
CEILING AND  
ROOF PLANS


A1.2

SHEET 2 OF 5

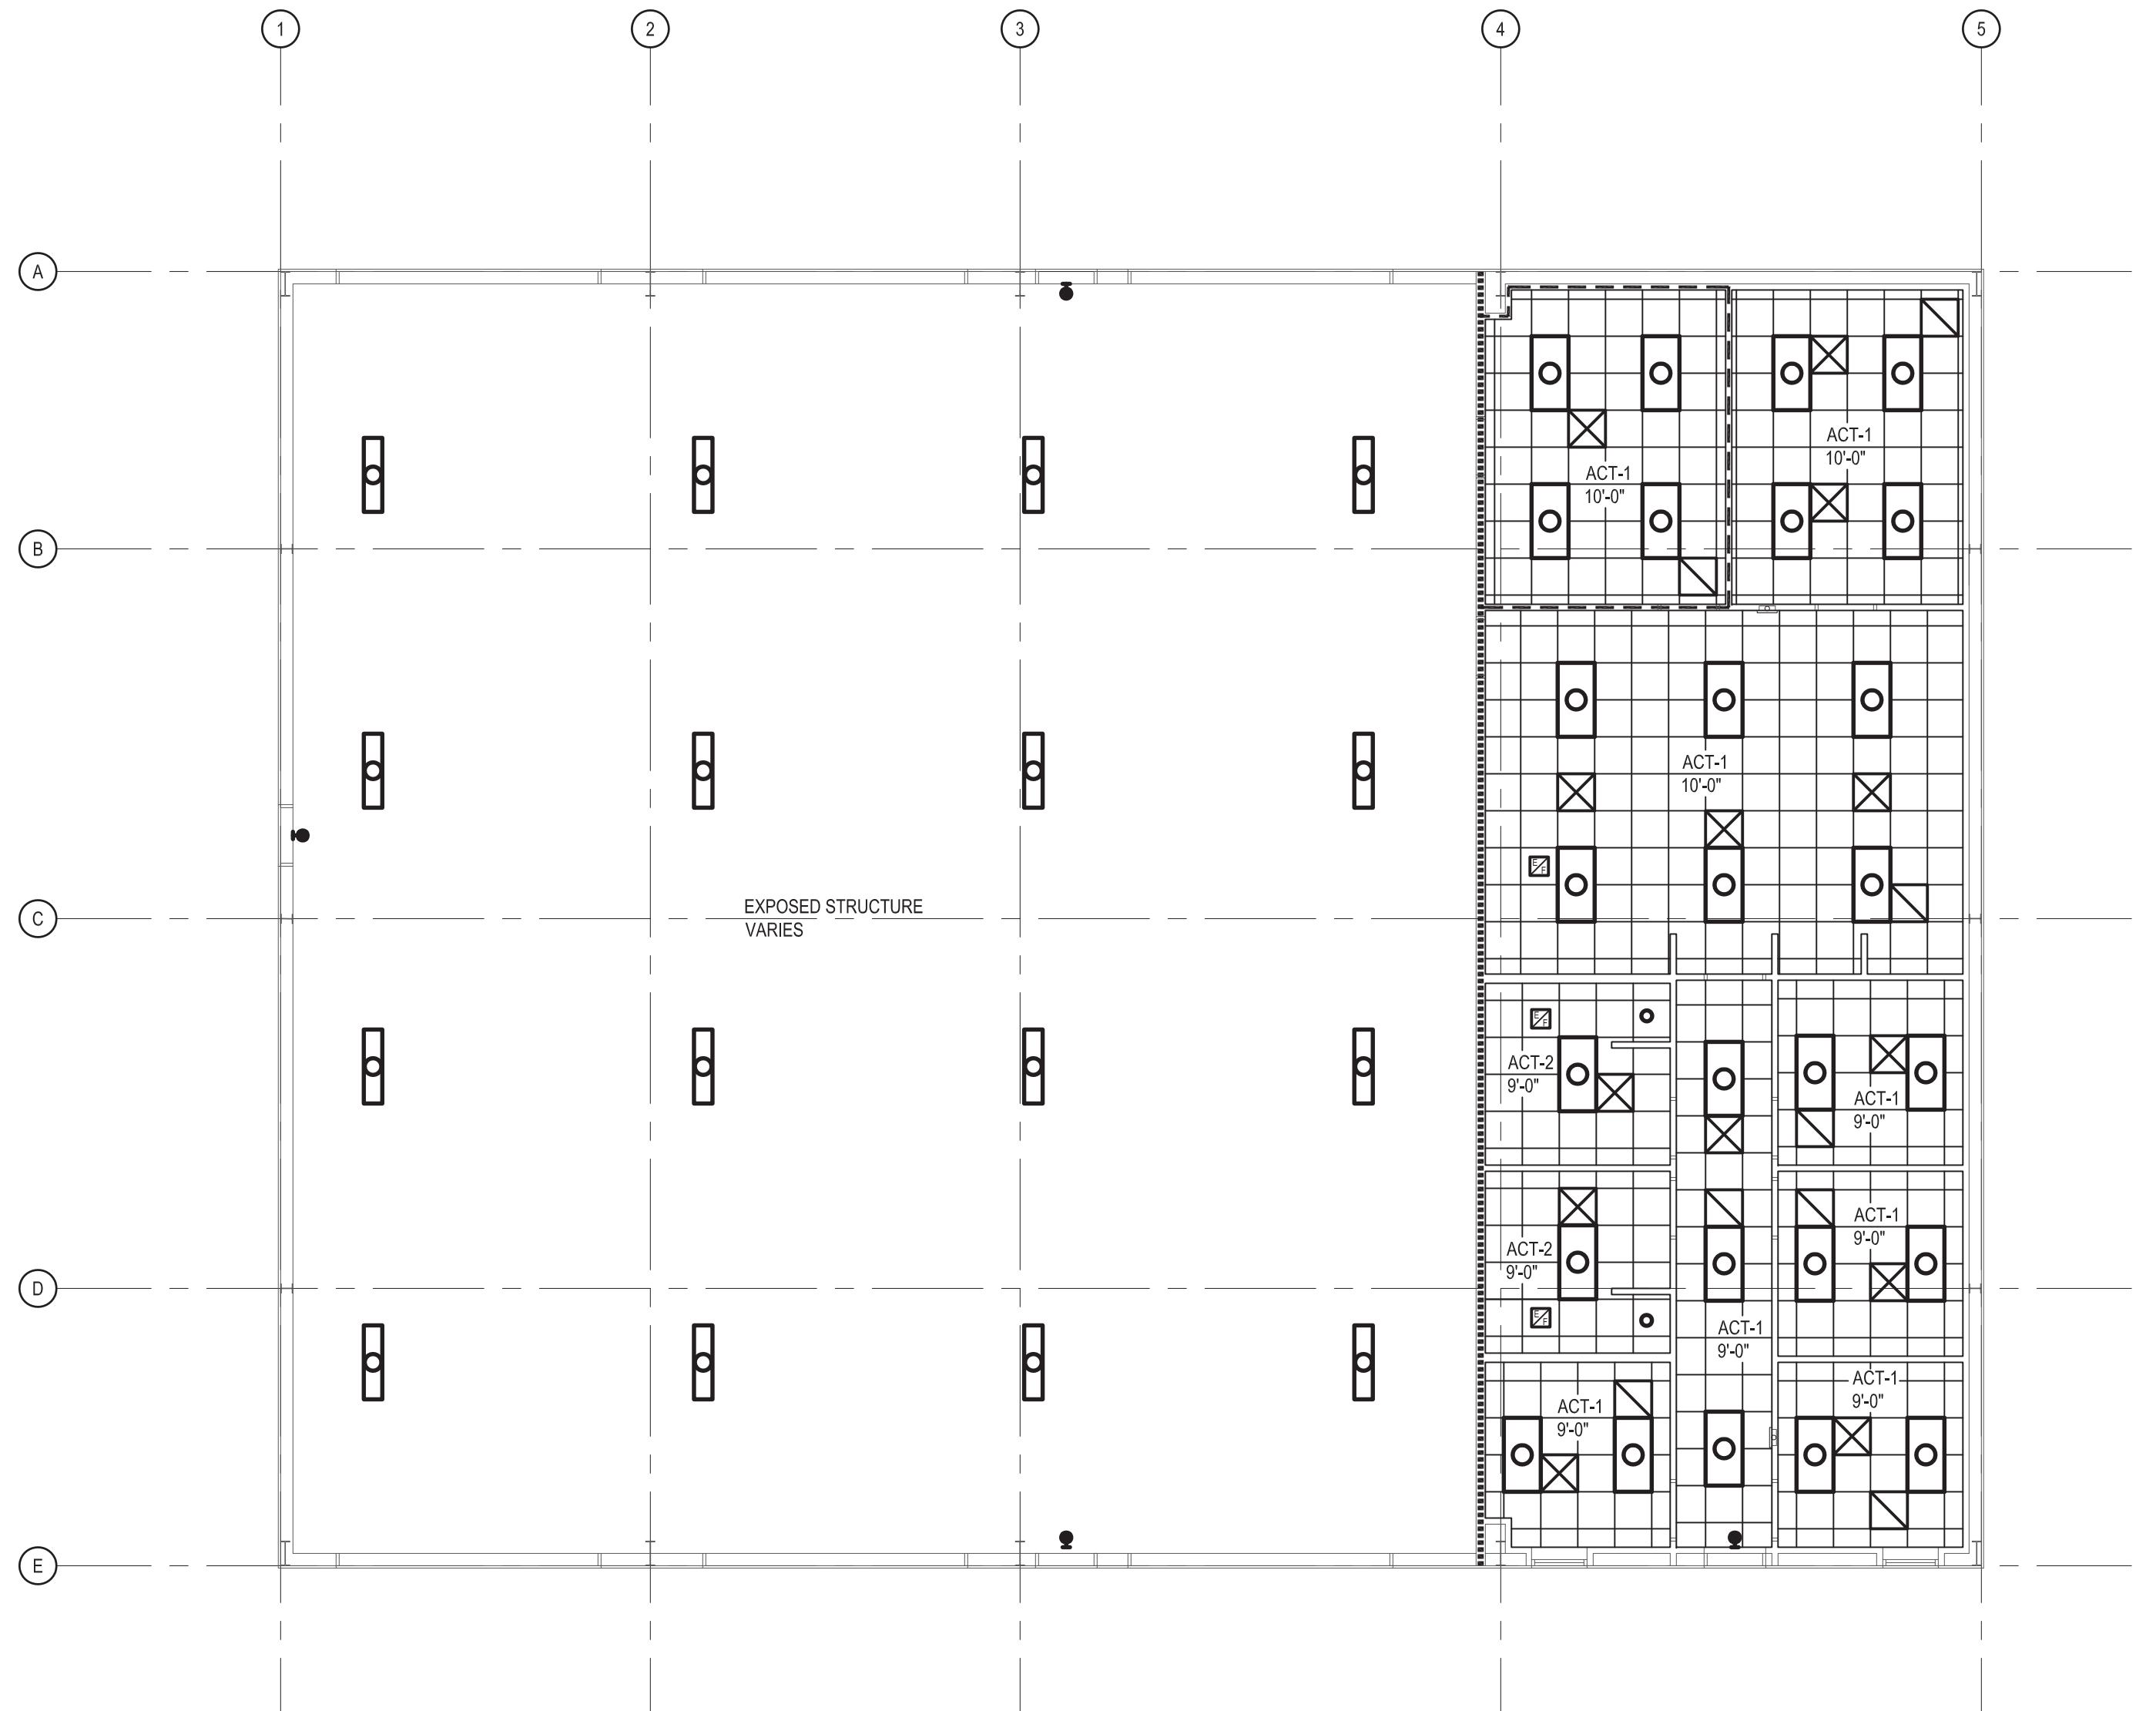

REFLECTED CEILING PLAN

SCALE: 1/8" = 1'-0"

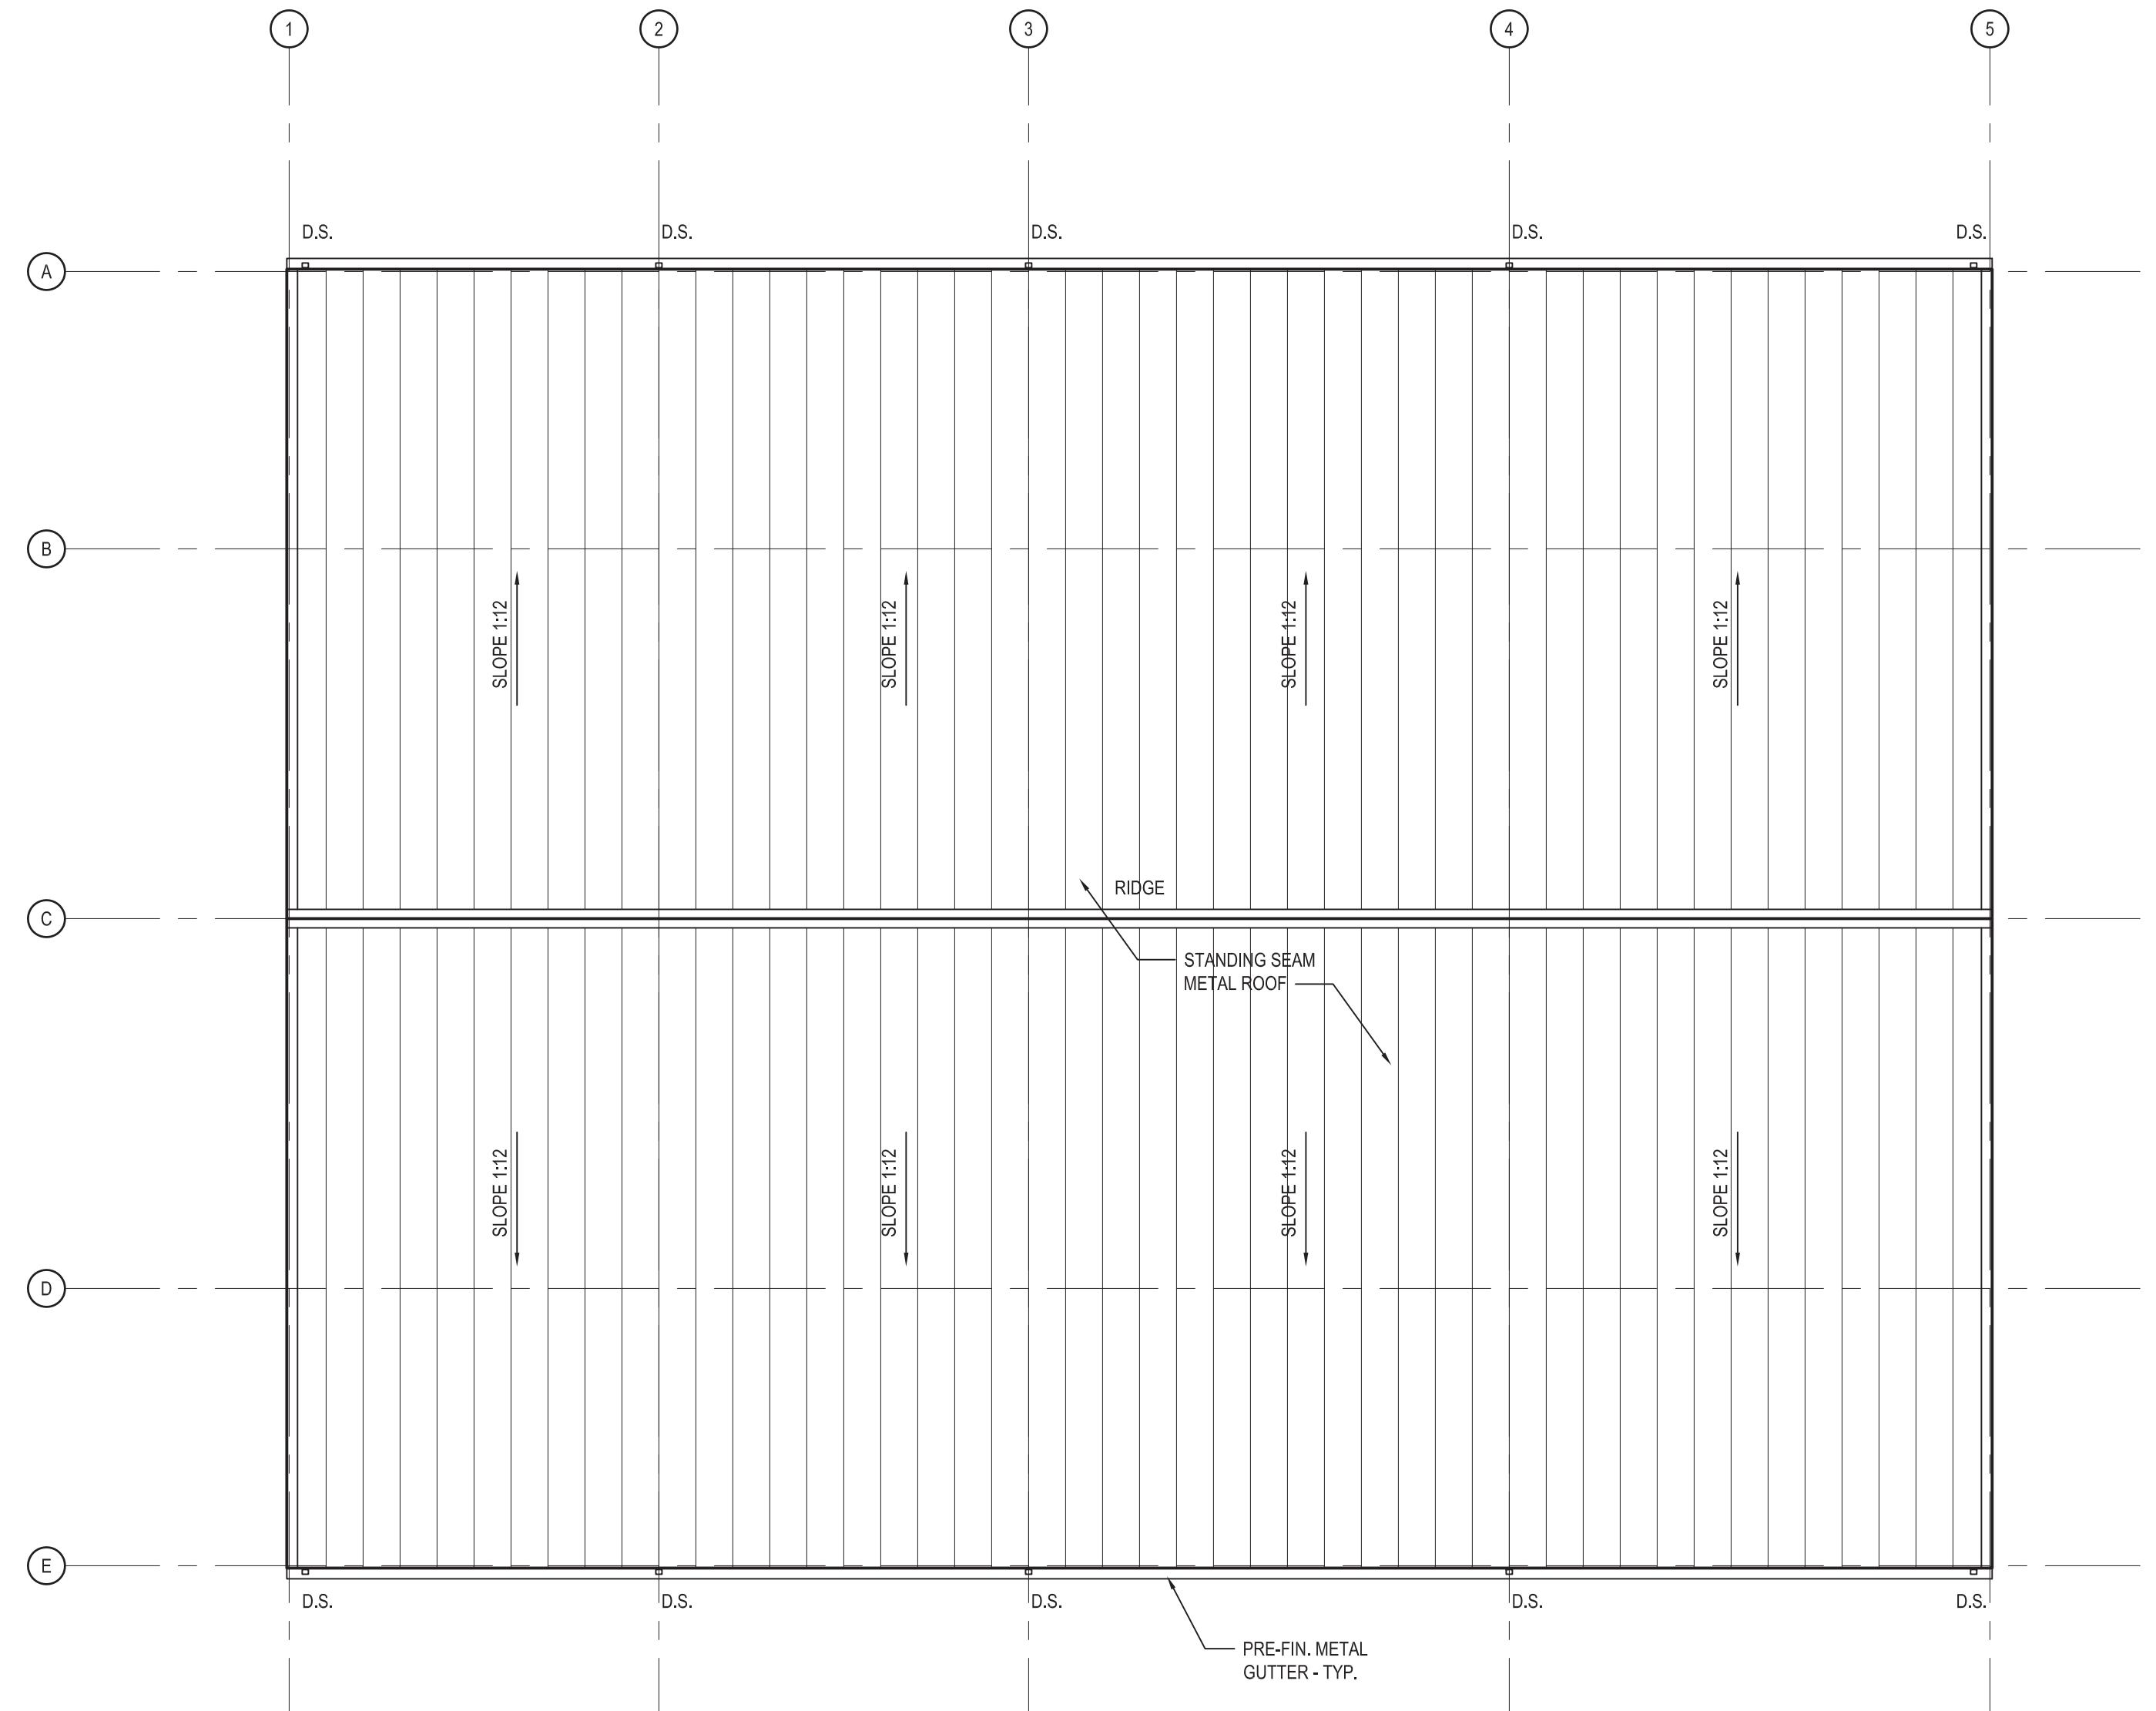

ROOF PLAN

SCALE: 1/8" = 1'-0"

## CEILING LEGEND

- 2x4' RECESSED FIXTURE - SEE ELECTRICAL PLAN
- 2x2' RECESSED FIXTURE - SEE ELECTRICAL PLAN
- PENDANT FIXTURE - SEE ELECTRICAL PLAN
- 4' SURFACE MOUNTED FIXTURE - SEE ELECTRICAL PLAN
- RECESSED MOUNTED FIXTURE - SEE ELECTRICAL PLAN
- 2x2' ACOUSTICAL CEILING TILE
- CEILING DIFFUSER IN 2x2' ALUM. PANEL - SEE MECHANICAL PLAN
- RETURN AIR GRILLE - SEE MECHANICAL PLAN
- EXHAUST FAN - SEE MECHANICAL PLAN
- 1-HR. FIRE RATED PARTITION ASSEMBLY - UL # U305
- ..... 2-HR. FIRE RATED PARTITION ASSEMBLY - UL # U419


## CEILING NOTES

1. MECHANICAL & ELECTRICAL CONTRACTORS SHALL COORDINATE THE LOCATION OF DIFFUSERS, GRILLES, LIGHT FIXTURES, ETC., WITH CEILING LAYOUT PRIOR TO BEGINNING ANY WORK AND SHALL CONSULT WITH THE ARCHITECT CONCERNING ANY CONFLICTS.
2. CONTRACTOR SHALL PROVIDE ADDITIONAL FRAMING FOR SOFFITS AND CEILINGS AS REQUIRED AT LIGHT FIXTURES, DIFFUSERS, GRILLES, ETC.
3. CEILING GRID AND SOFFIT FRAMING SHALL BE SUPPORTED FROM STRUCTURE AT ALL CORNERS OF LIGHT FIXTURES, DIFFUSERS, GRILLES, ETC. ELECTRICAL AND MECHANICAL CONTRACTORS SHALL SUPPORT THEIR FIXTURES, DIFFUSERS, GRILLES, ETC. WITH HANGERS INDEPENDENT OF THE CEILING SYSTEM.

CEILING TYPES:  
ACT-1 ACOUSTICAL TILE-TYPE 1  
ACT-2 ACOUSTICAL TILE (MOISTURE RESISTANT)-TYPE 2  
  
NOTE:  
CEILING HEIGHTS LISTED ON THE REFLECTED CEILING PLAN ARE NOMINAL.  
SEE DETAILS FOR EXACT DIMENSIONS.

## ROOFING NOTES

1. ROOFING SUBCONTRACTOR SHALL VERIFY ALL ROOF SUBSTRATE, CONDITIONS, AND DIMENSIONS, PRIOR TO ROOF INSTALLATION.
2. EXTEND ALL ROOF PENETRATIONS UP THROUGH ROOF SYSTEM AS RECOMMENDED BY ROOF SYSTEM MANUFACTURER.
3. DIVERT WATER AROUND ALL EXHAUST FANS, ETC. AS REQUIRED.
4. VENT THRU ROOFS SHALL BE ROUTED TO REAR OF BUILDING WHERE POSSIBLE - COORDINATE WITH ARCHITECT.
5. CONTRACTOR SHALL COORDINATE EXACT LOCATION OF ALL PLUMBING, MECHANICAL AND ELECTRICAL ROOF AND WALL PENETRATIONS WITH ARCHITECT. GENERAL LOCATIONS ARE INDICATED ON PLUMBING, MECHANICAL, AND ELECTRICAL SHEETS.

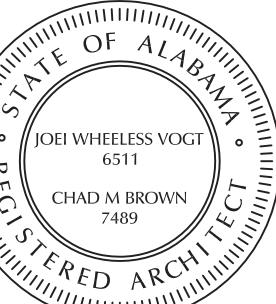

A NEW FIRE STATION  
FOR THE  
CITY OF ASHFORD  
ASHFORD, ALABAMA

OWNER:  
CITY OF ASHFORD  
525 N BROADWAY STREET  
ASHFORD, ALABAMA 36312


ISSUE: APRIL 19, 2022  
MARK DATE DESCRIPTION

PROJECT NO: 21-20  
DRAWN BY: JAMEY AVERY  
CHECKED BY: CHAD M. BROWN  
SHEET TITLE

EXTERIOR  
ELEVATIONS AND  
SECTIONS


A2.1

SHEET 3 OF 5

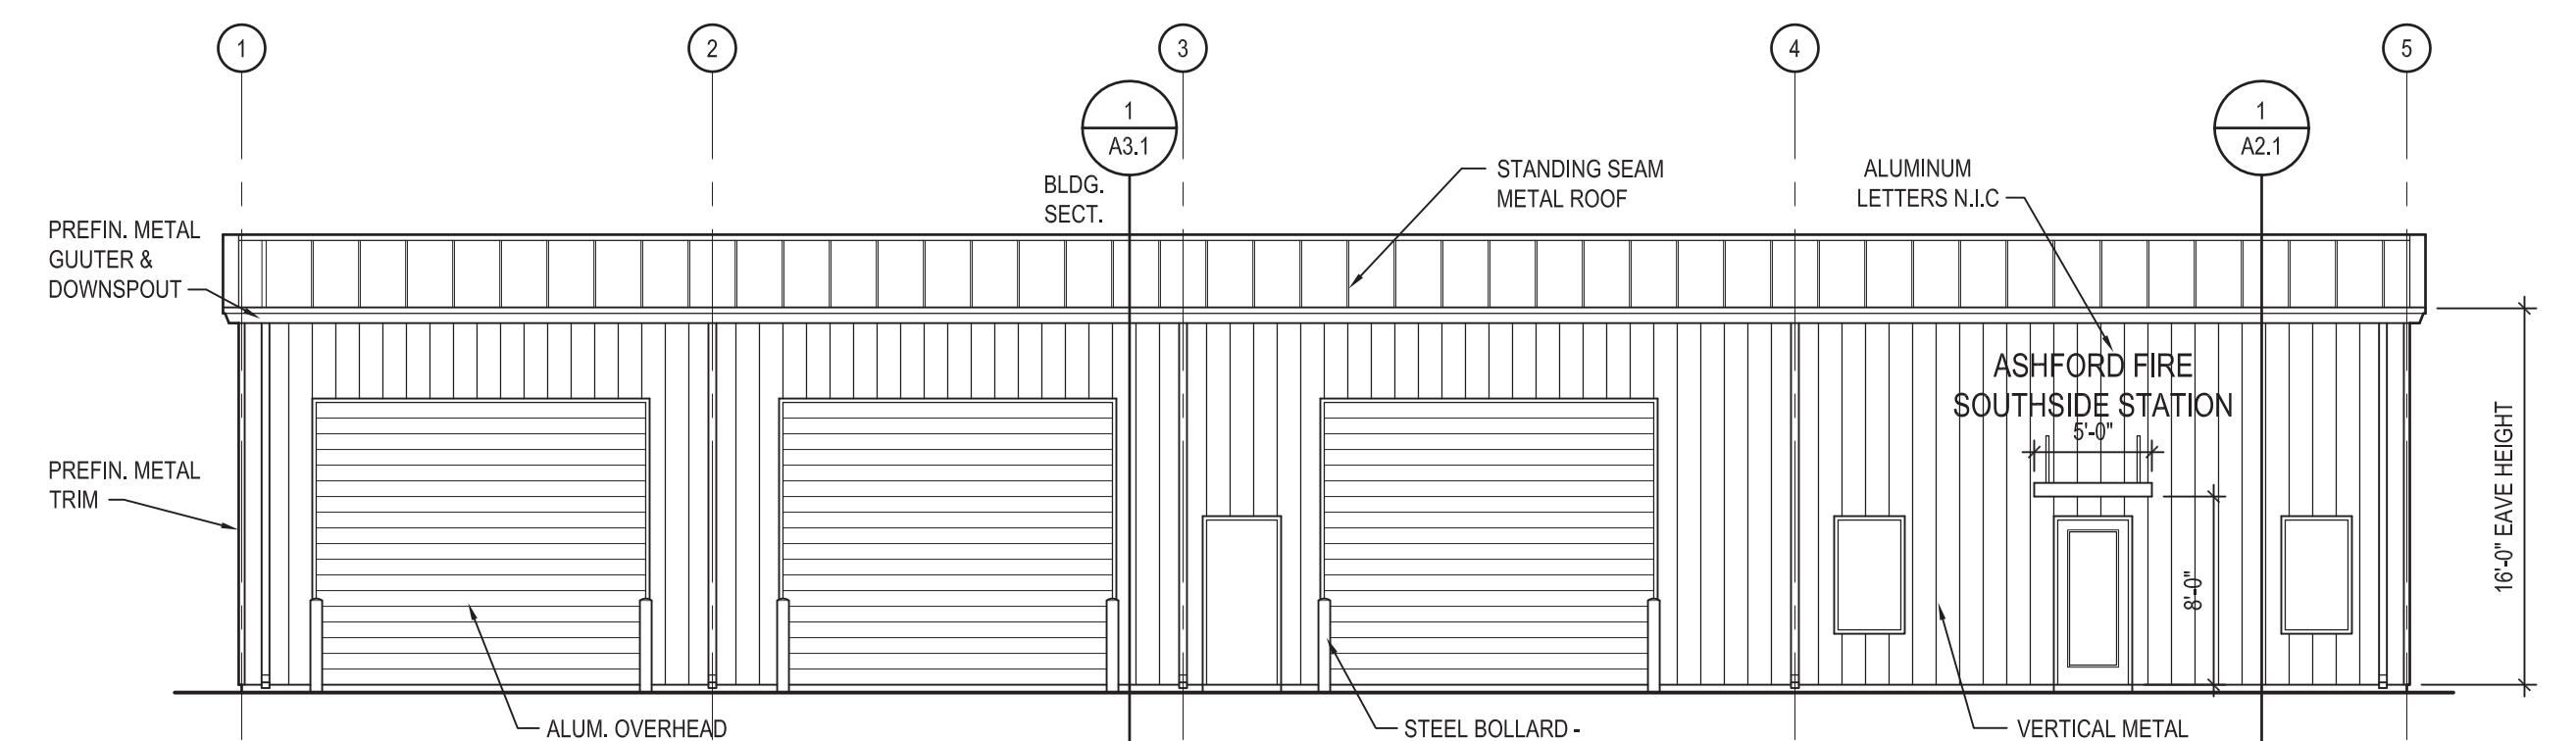


FRONT ELEVATION

SCALE: 1/8" = 1'-0"

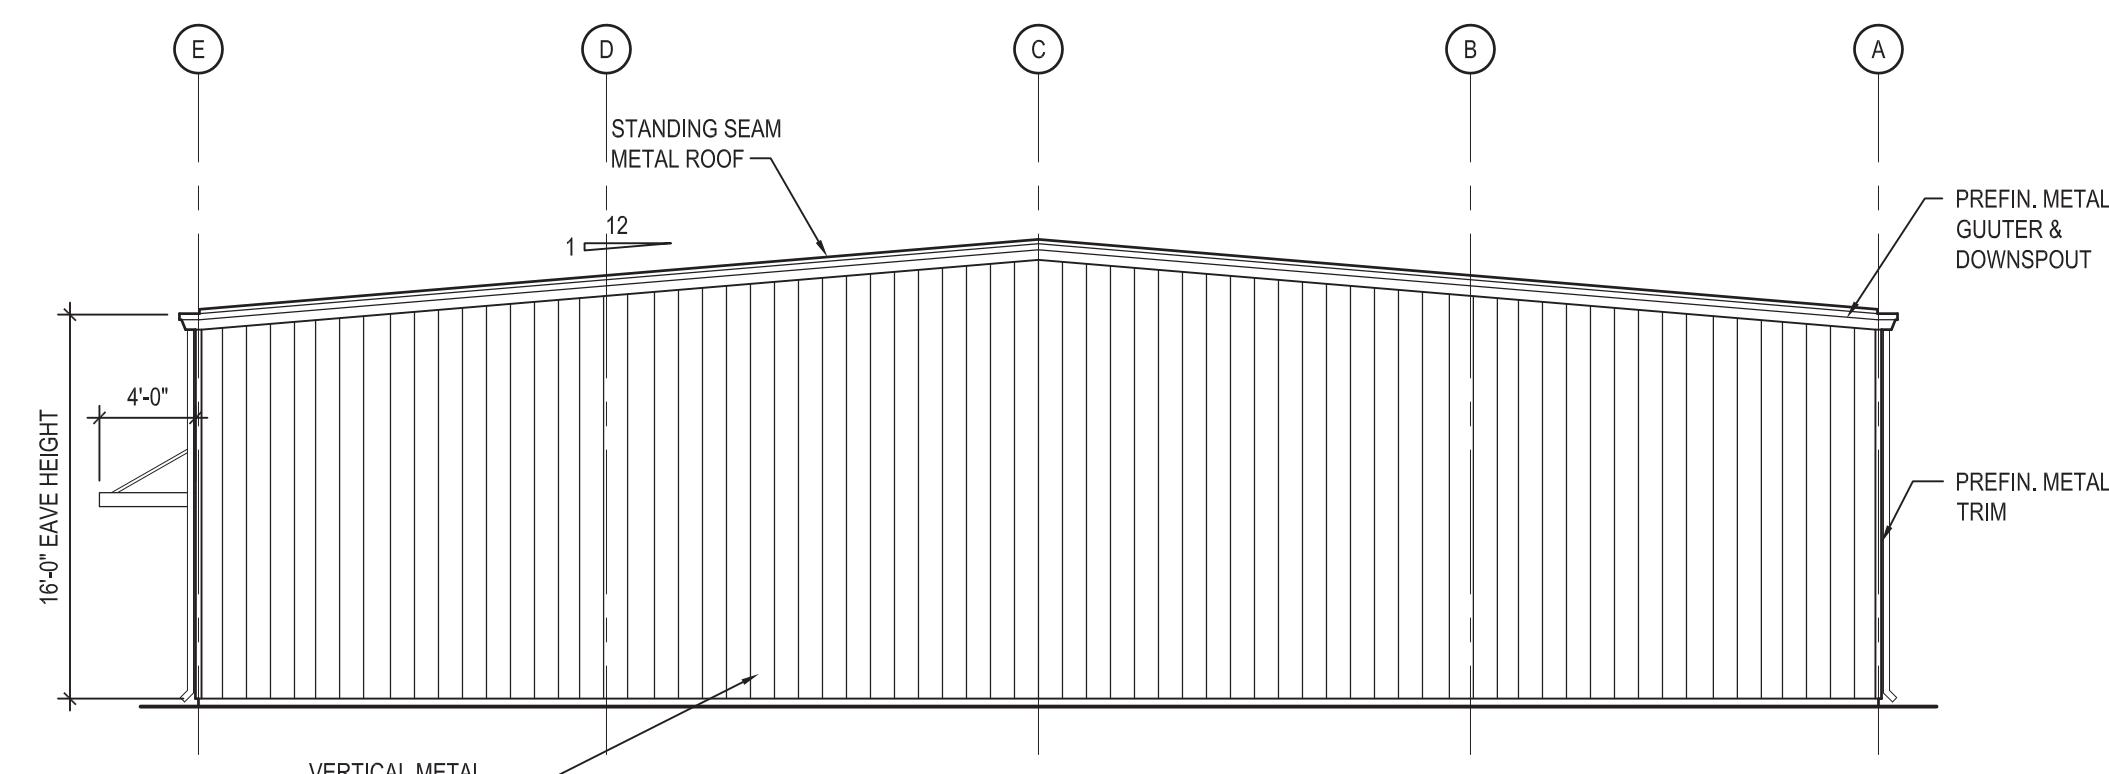


RIGHT SIDE ELEVATION

SCALE: 1/8" = 1'-0"

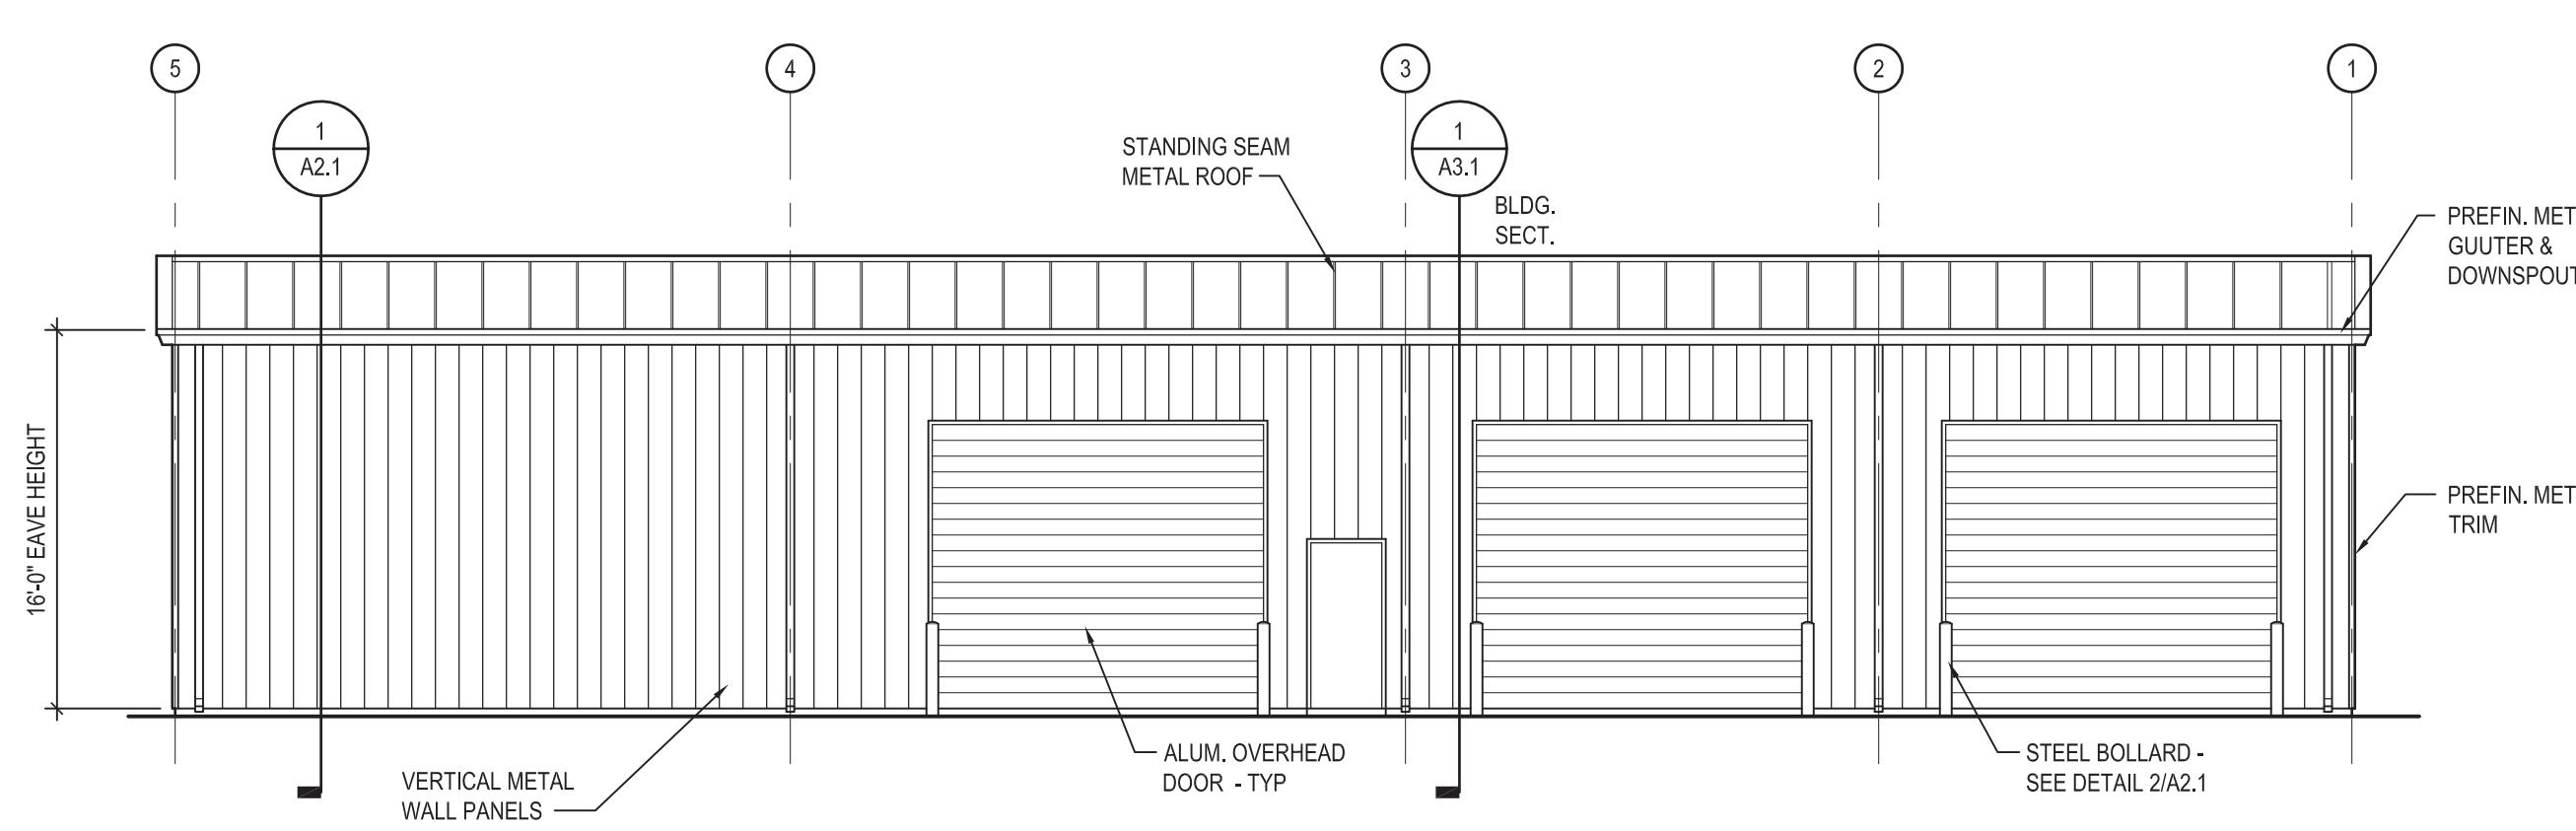


REAR ELEVATION

SCALE: 1/8" = 1'-0"

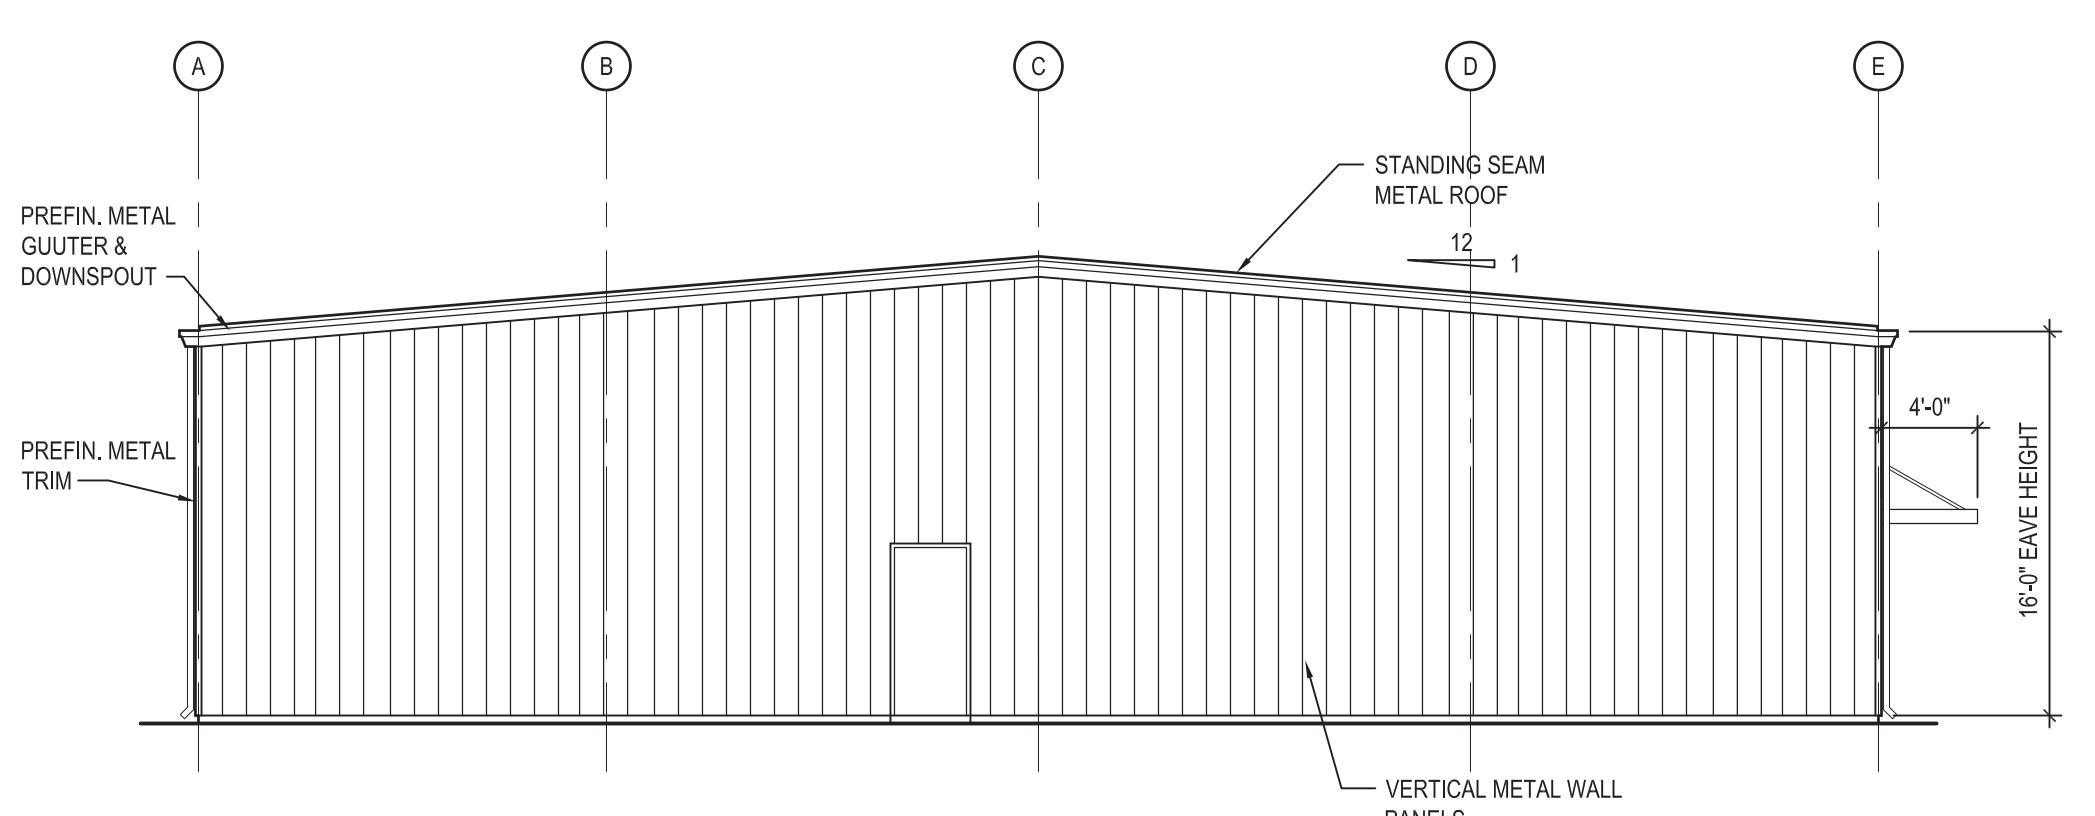

LEFT SIDE ELEVATION

SCALE: 1/8" = 1'-0"

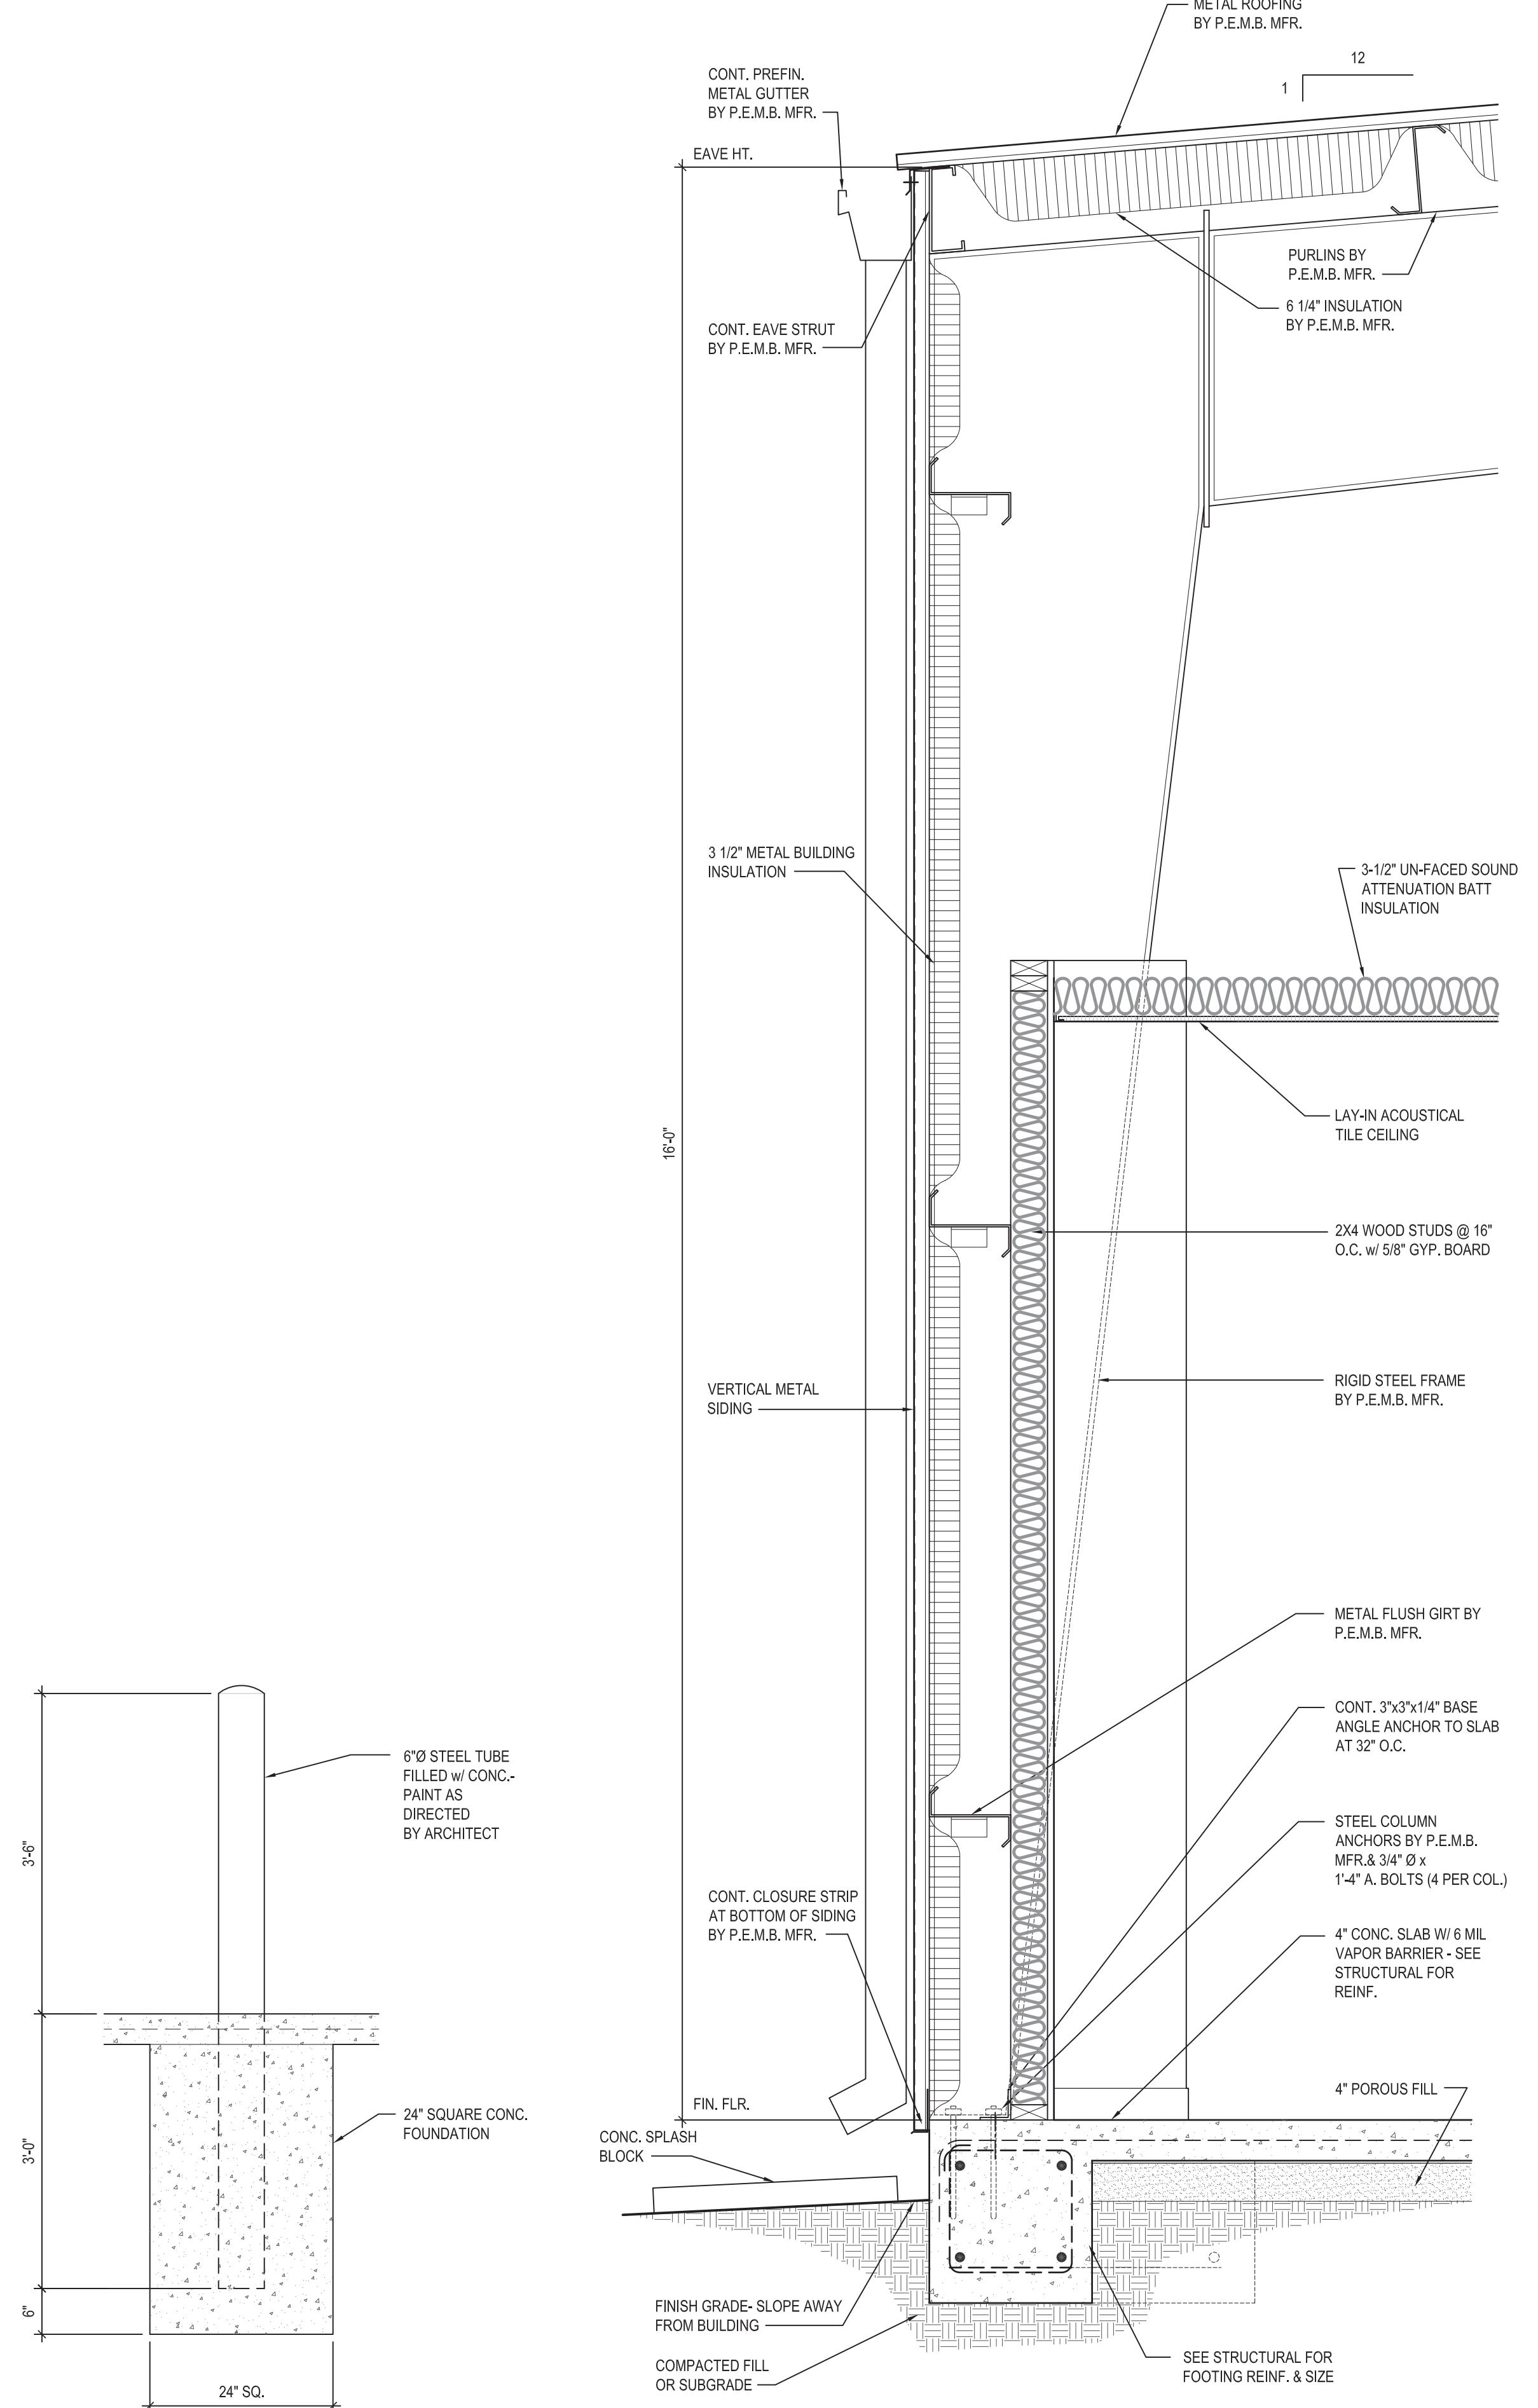

WALL SECTION

WALL SECTION

SCALE: 1" = 1'-0"

BOLLARD DETAIL

SCALE: 1/2" = 1'-0"

A2.1

SHEET 3 OF 5



A NEW FIRE STATION  
FOR THE  
CITY OF ASHFORD  
ASHFORD, ALABAMA

OWNER:  
CITY OF ASHFORD  
525 N BROADWAY STREET  
ASHFORD, ALABAMA 36312


ISSUE: APRIL 19, 2022  
MARK DATE DESCRIPTION

PROJECT NO: 21-20  
DRAWN BY: JAMEY AVERY  
CHECKED BY: CHAD M. BROWN

SHEET TITLE

BUILDING  
SECTION

A3.1  
SHEET 4 OF 5

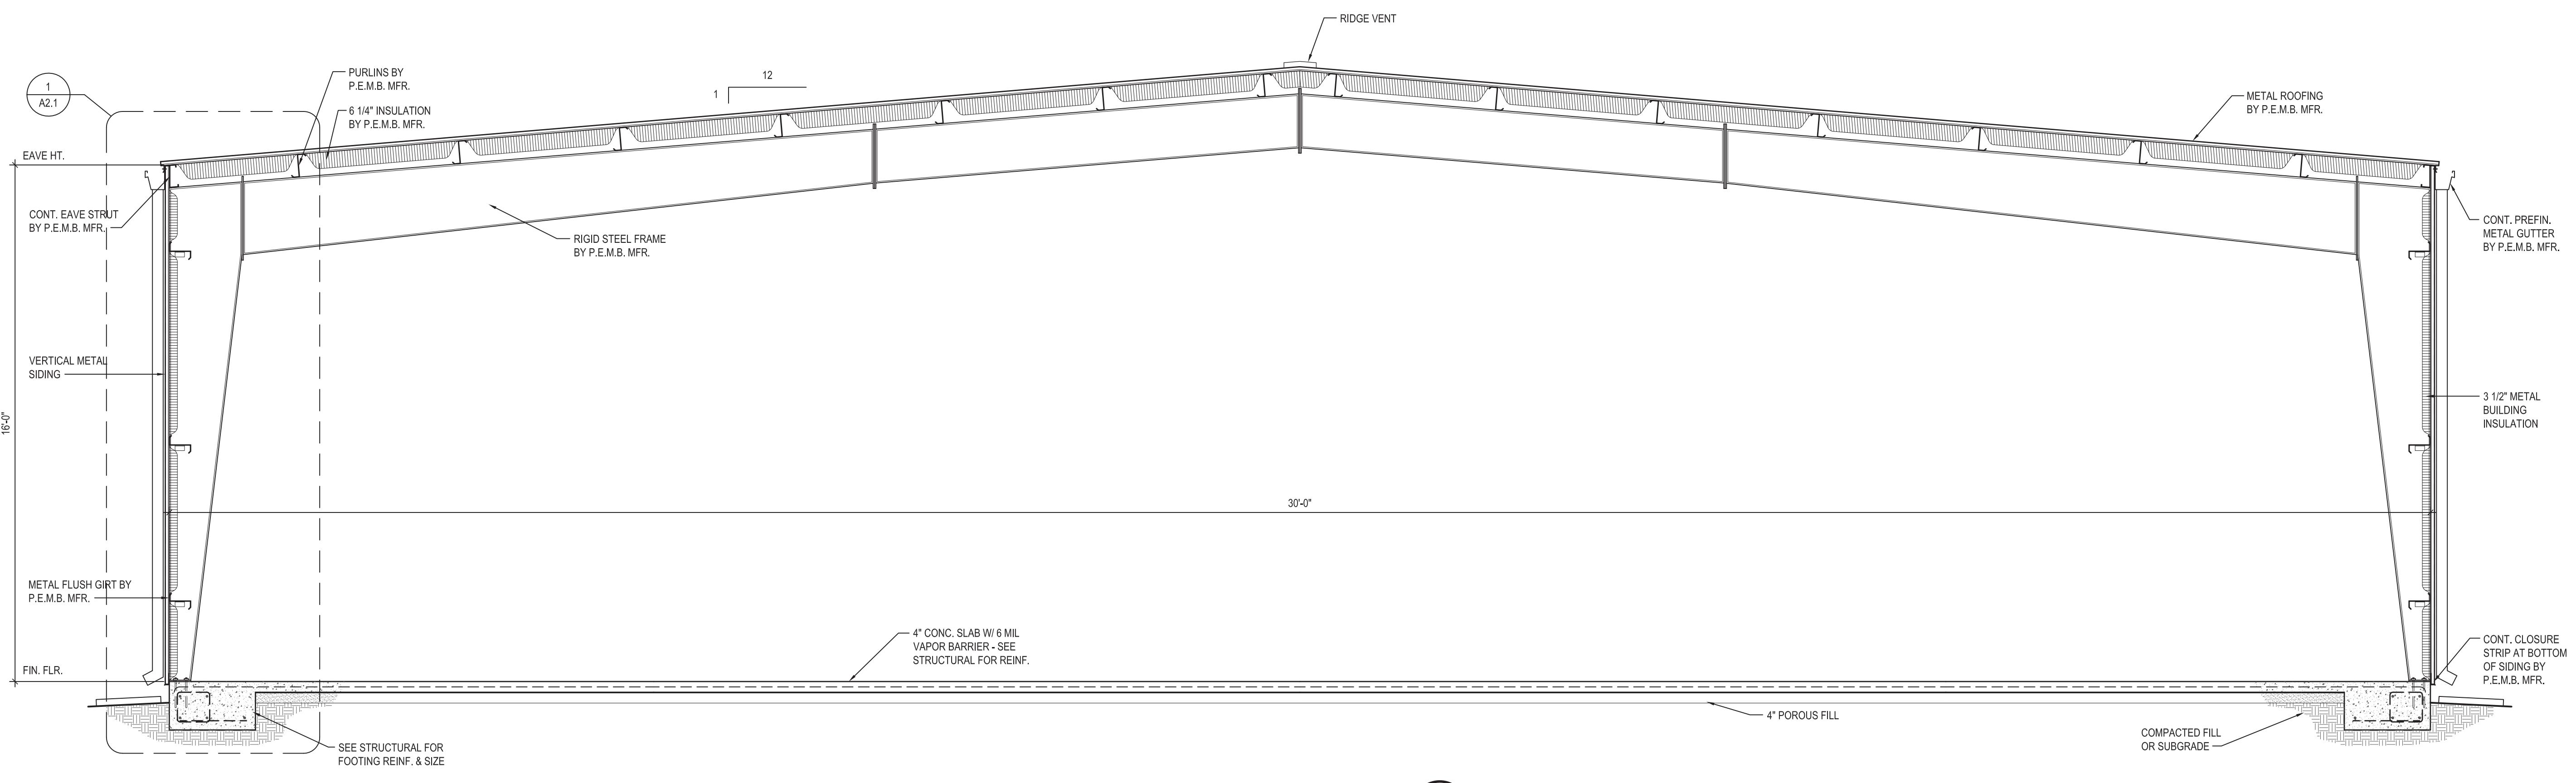



A NEW FIRE STATION  
FOR THE  
CITY OF ASHFORD  
ASHFORD, ALABAMA

OWNER:  
CITY OF ASHFORD  
525 N BROADWAY STREET  
ASHFORD, ALABAMA 36312



ISSUE: APRIL 19, 2022  
MARK DATE DESCRIPTION

PROJECT NO: 21-20  
DRAWN BY: JAMEY AVERY  
CHECKED BY: CHAD BROWN  
SHEET TITLE

INTERIOR  
ELEVATIONS  
AND SECTIONS

A4.1

SHEET 5 OF 5

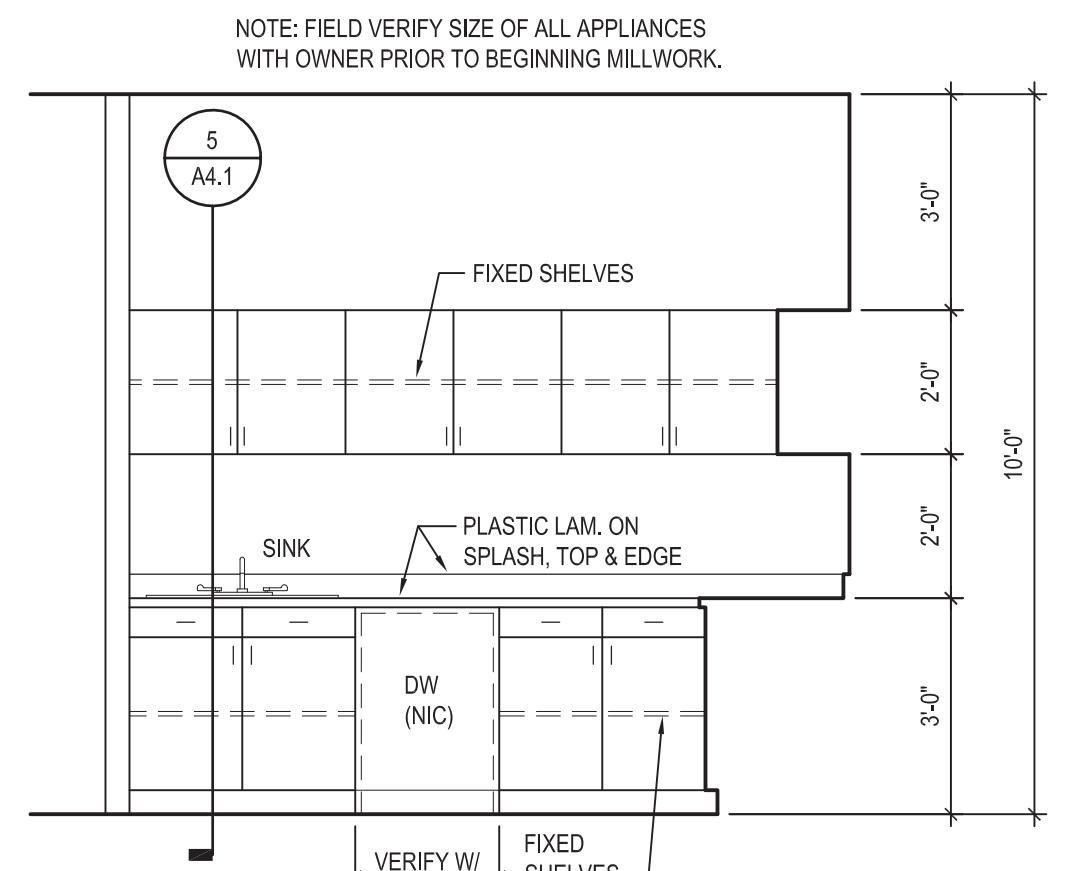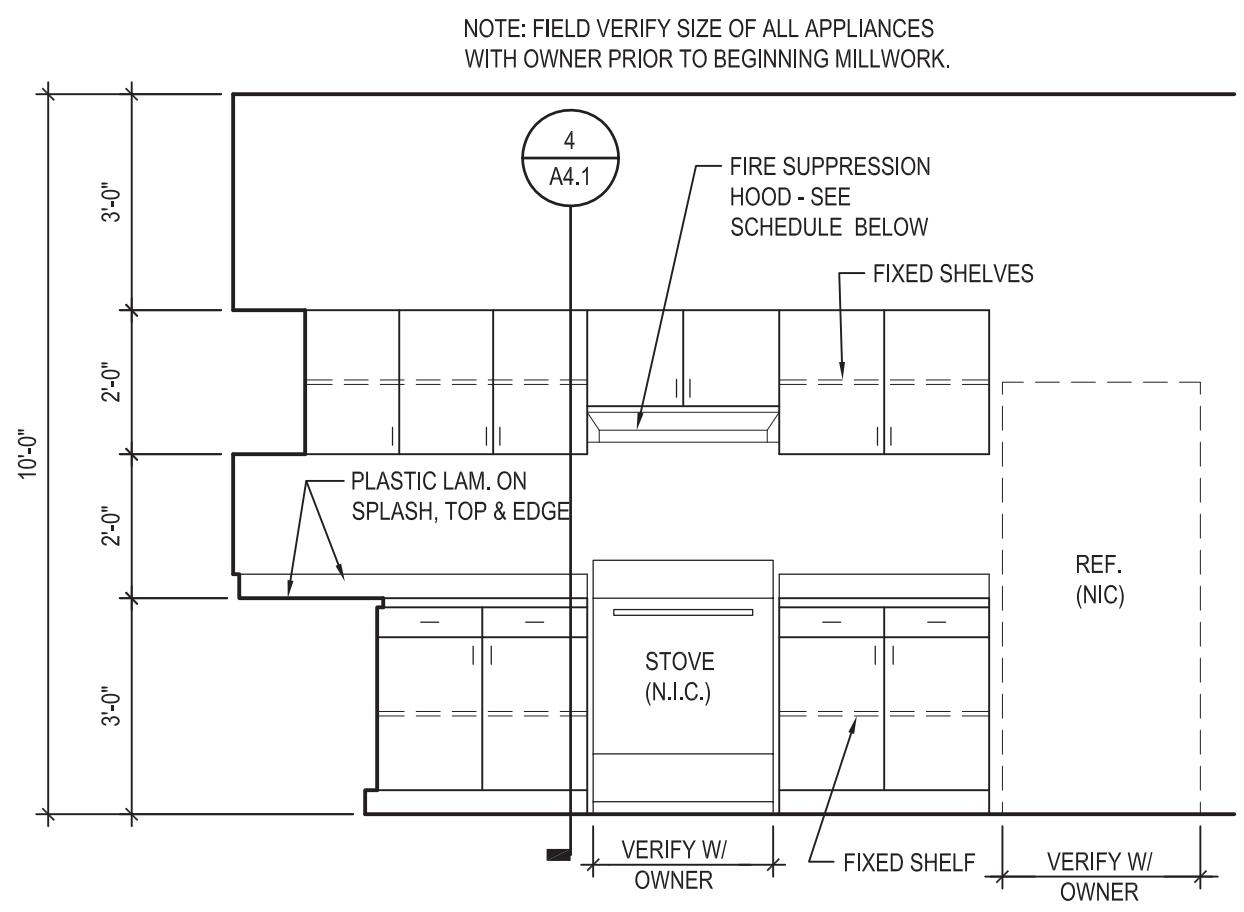


BREAK ROOM ELEVATION  
SCALE: 3/8" = 1'-0"

FIRE SUPPRESSION RANGE HOOD

MFRG	MODEL#	CFM	VOLTAGE	AMPS
DENLAR	D1030-F (NFPA101)	500	120 / 1 / 60	5

NOTES: 1. HOOD SHALL HAVE AN INTEGRAL FIRE SUPPRESSION SYSTEM WITH AUTOMATIC POWER DISCONNECT.  
2. HOOD TO BE RETICULATING TYPE AND BE COMPLIANT WITH NFPA 101.  
3. EQUAL PRODUCT ACCEPTED BY PRE-APPROVED MFRG.

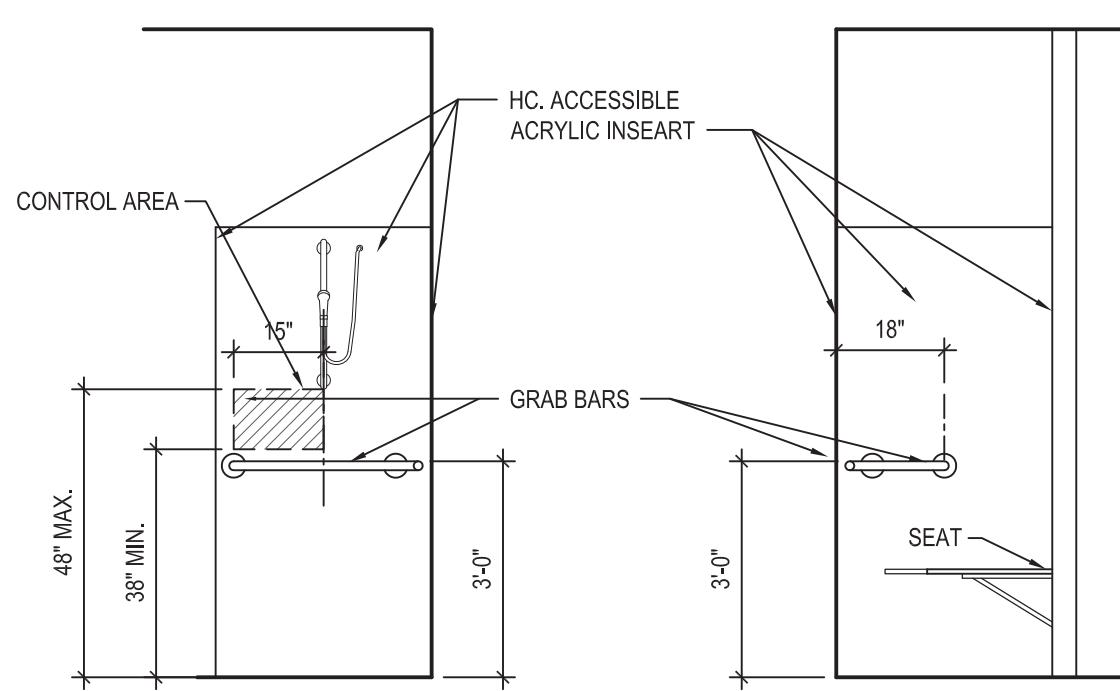

HC SHOWER - TYP.

SCALE: 3/8" = 1'-0"

BREAK ROOM ELEVATION  
SCALE: 3/8" = 1'-0"

MANEUVERING CLEARANCES - ACCESSIBLE ROUTES


SCALE: 3/8" = 1'-0"

TOILET ACCESSORIES LEGEND


TA-1	TISSUE HOLDER - BRADLEY 5224
TA-2	SOAP DISPENSER - BRADLEY 6562
TA-3	TOWEL DISPENSER - BRADLEY 250-15
TA-4	WASTE RECEPTACLE - BRADLEY 346
TA-5	36" GRAB BAR - BRADLEY 812
TA-6	42" GRAB BAR - BRADLEY 812
TA-7	18" x 36" MIRROR - BRADLEY 781-1836
TA-8	COAT HOOK - BRADLEY 9134
TA-9	OUNTING HT. 48" MAX. - 33" MIN. A.F.F.
	SANITARY NAPKIN DISPOSAL - BRADLEY 4781-15

NOTE:  
1. THE NUMBERS ABOVE REFER TO MODEL NUMBERS FOR UNITS AS MANUFACTURED BY BRADLEY CORP.  
2. TOILET ACCESSORIES SHALL BE SIMILAR OR EQUAL TO THESE MODELS SPECIFIED.


TOILET ACCESSORIES AND ADA MOUNTING HEIGHT SCHEDULE

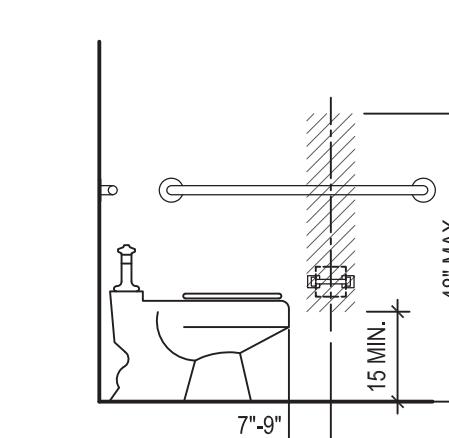


TA-1  
(T.P. DISPENSER)

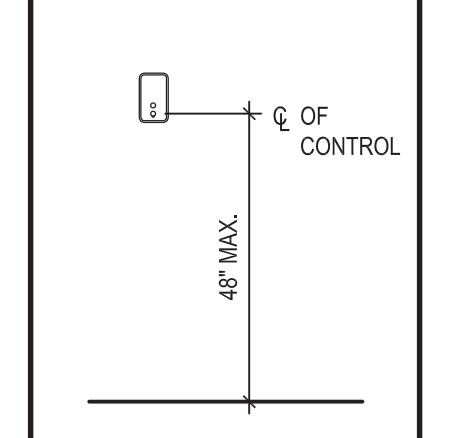


TA-2  
(SOAP DISPENSER)

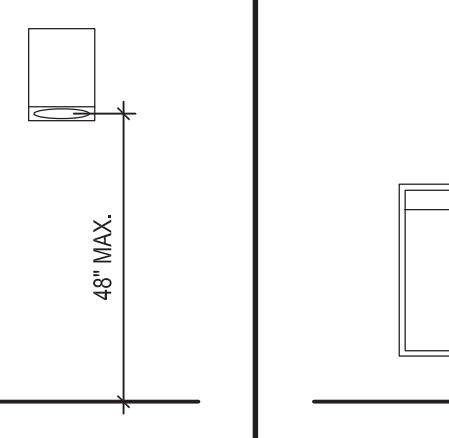


TA-3  
(TOWEL DISPENSER)

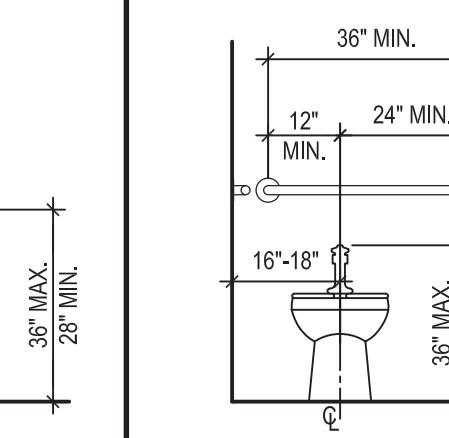


TA-4  
(WASTE RECEPTACLE)

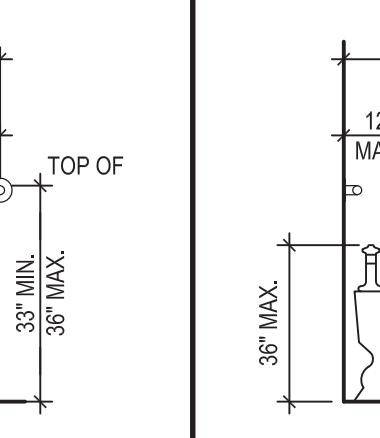


TA-5  
(BACK GRAB BAR)

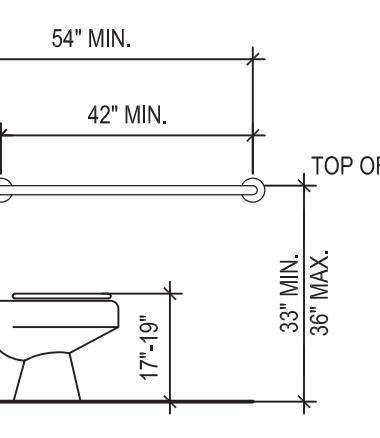


TA-6  
(SIDE GRAB BAR)

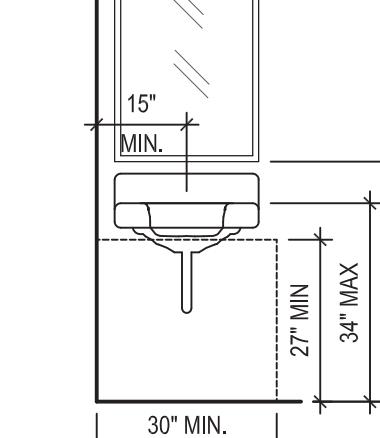


TA-7  
(MIRROR W/ S.S. FRAME)

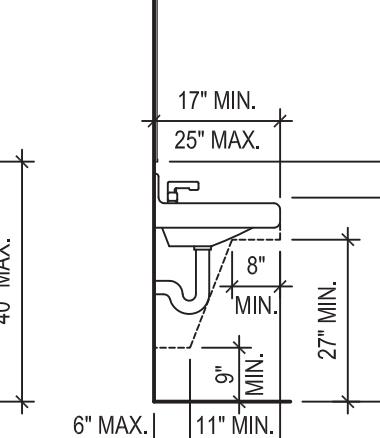


TA-9  
(SANITARY NAPKIN DISPOSAL)

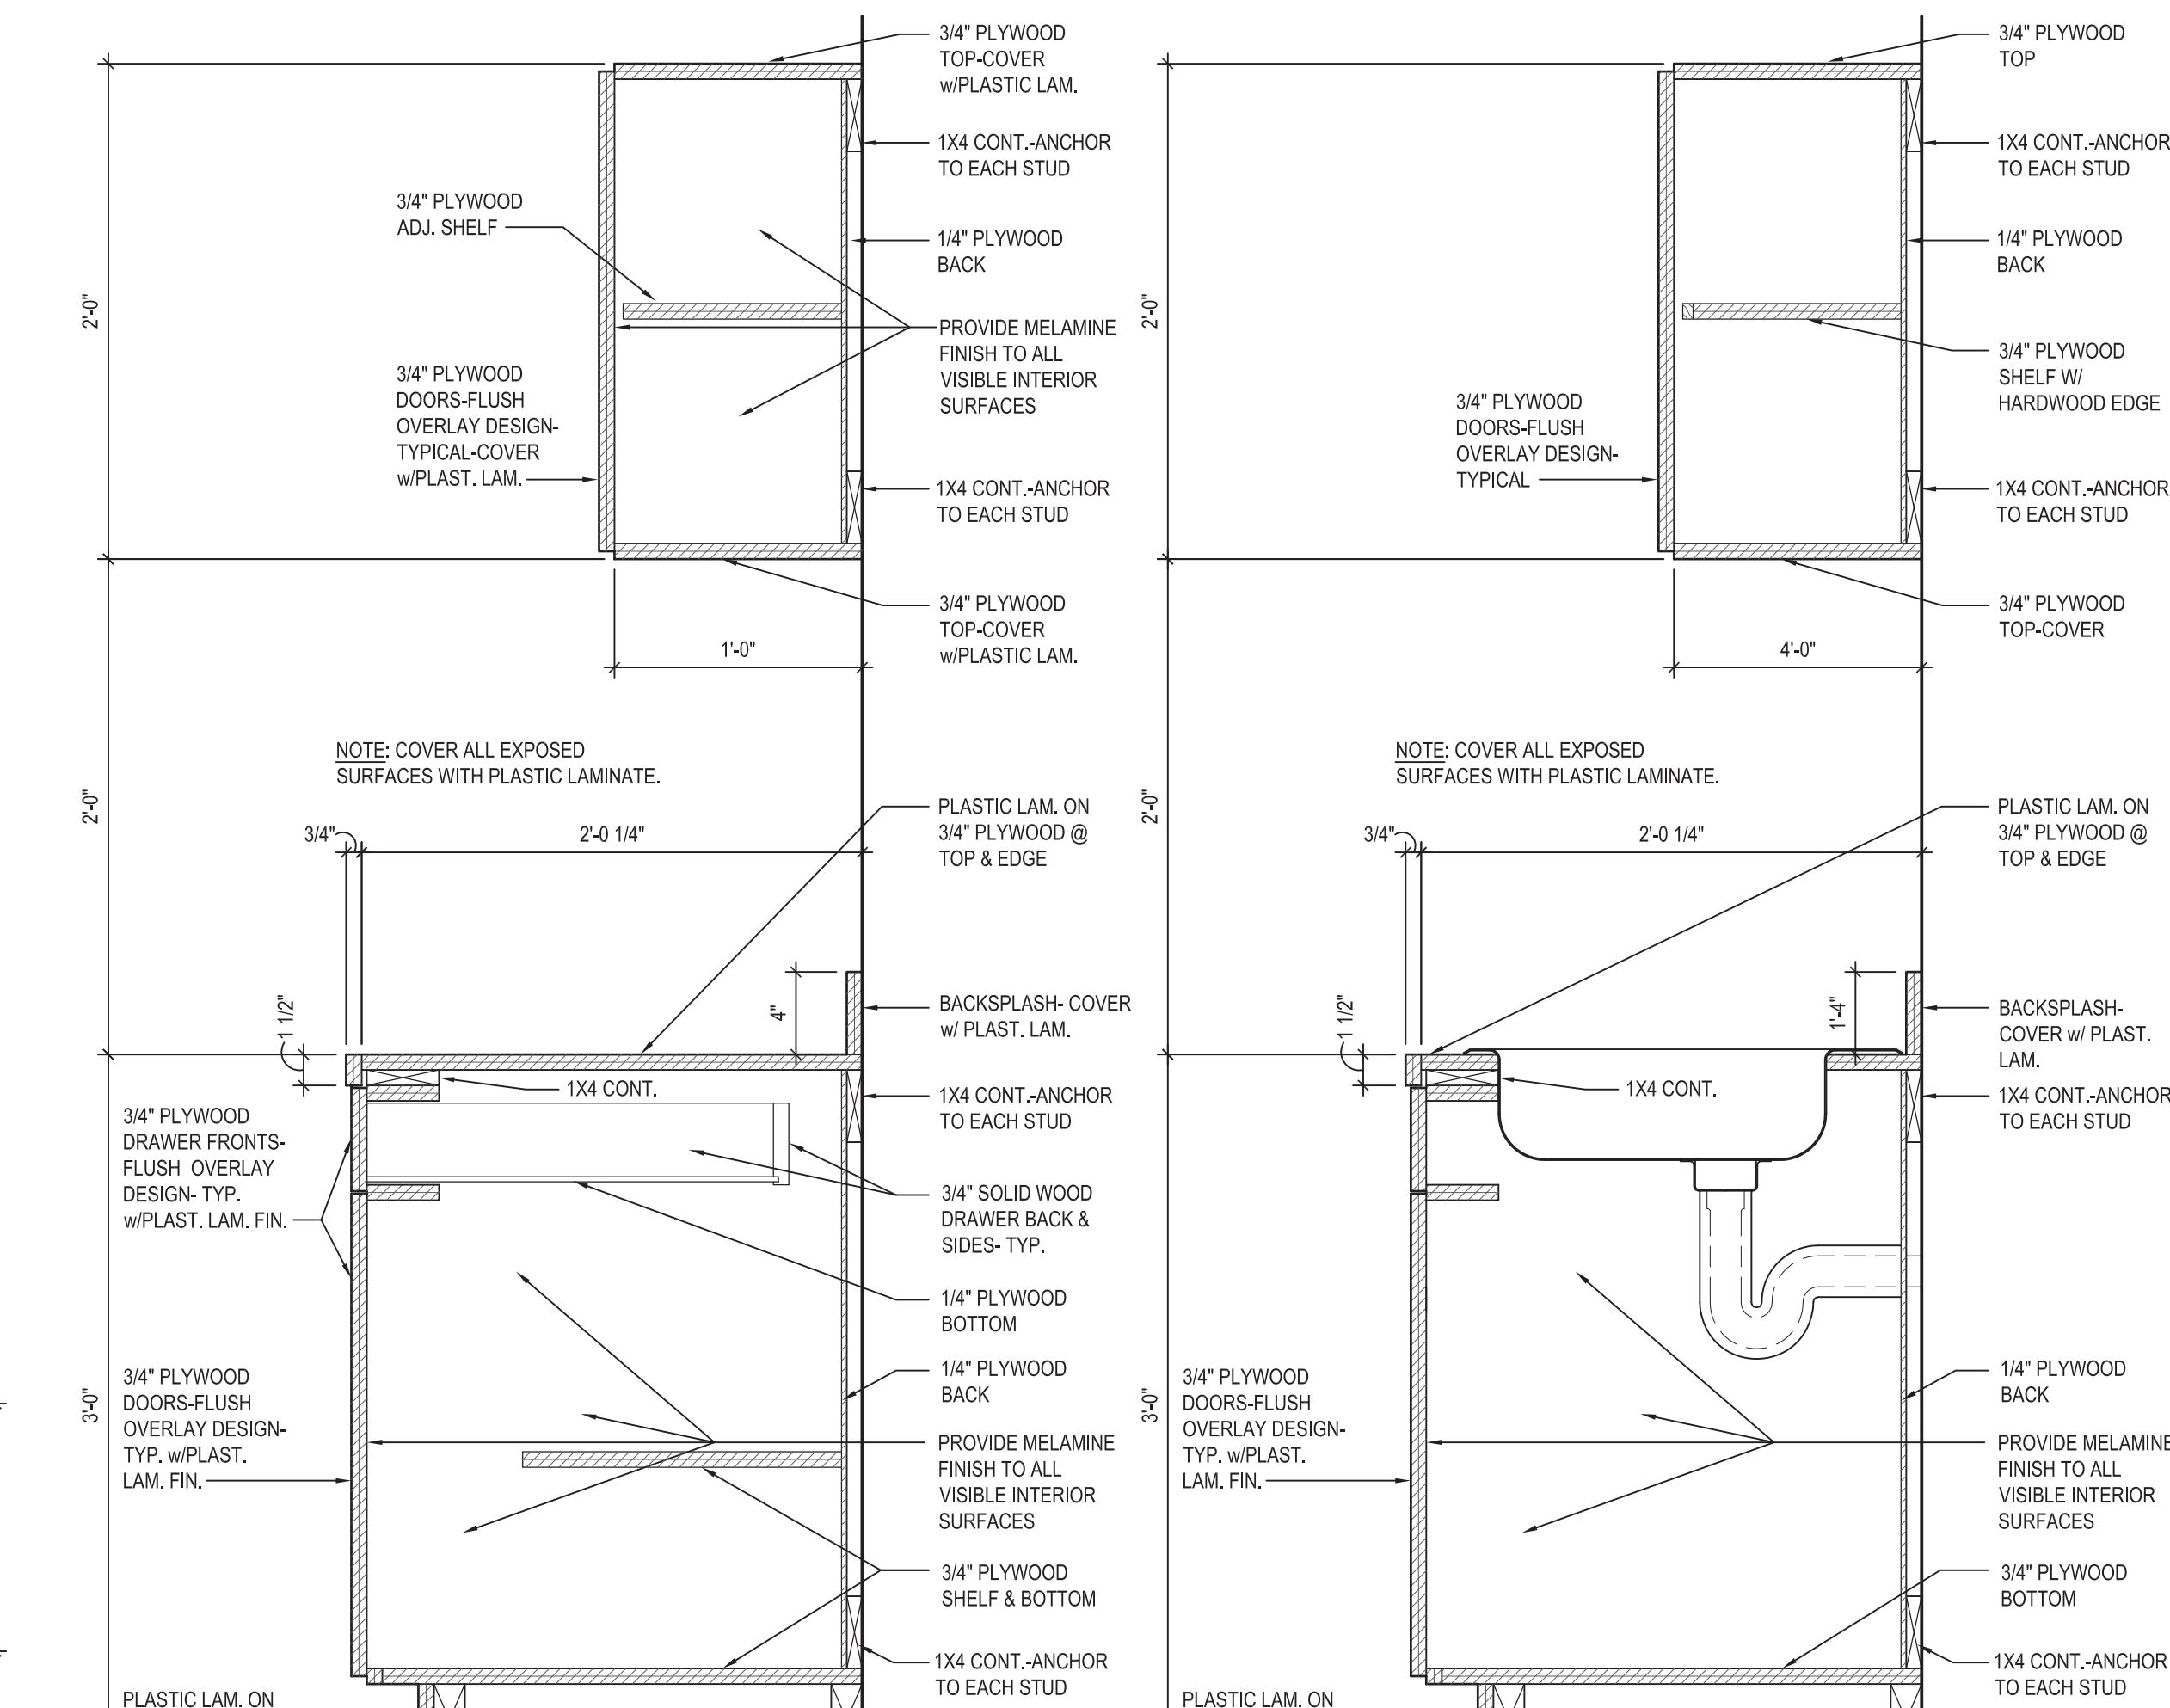


CABINET SECTION  
SCALE: 1 1/2" = 1'-0"

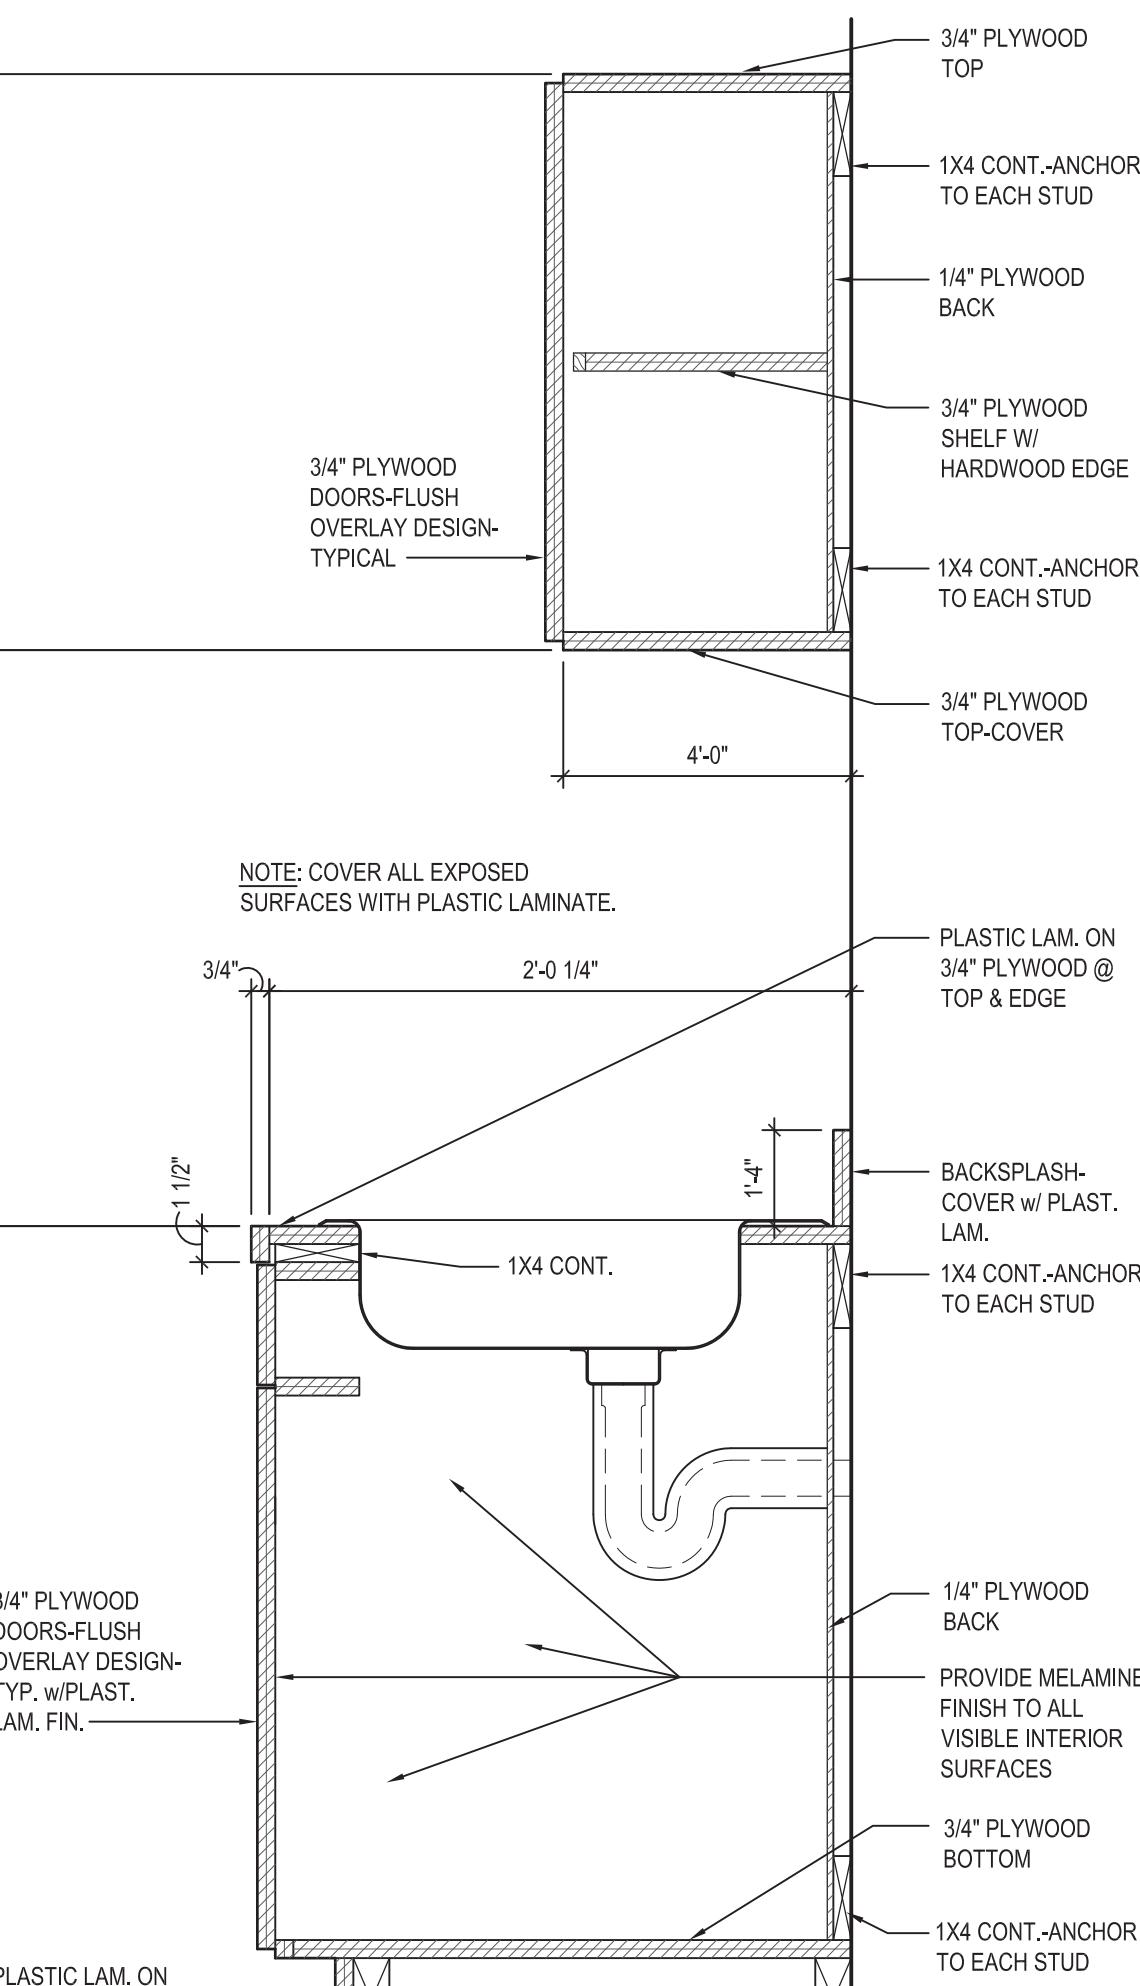

CABINET SECTION  
SCALE: 1 1/2" = 1'-0"

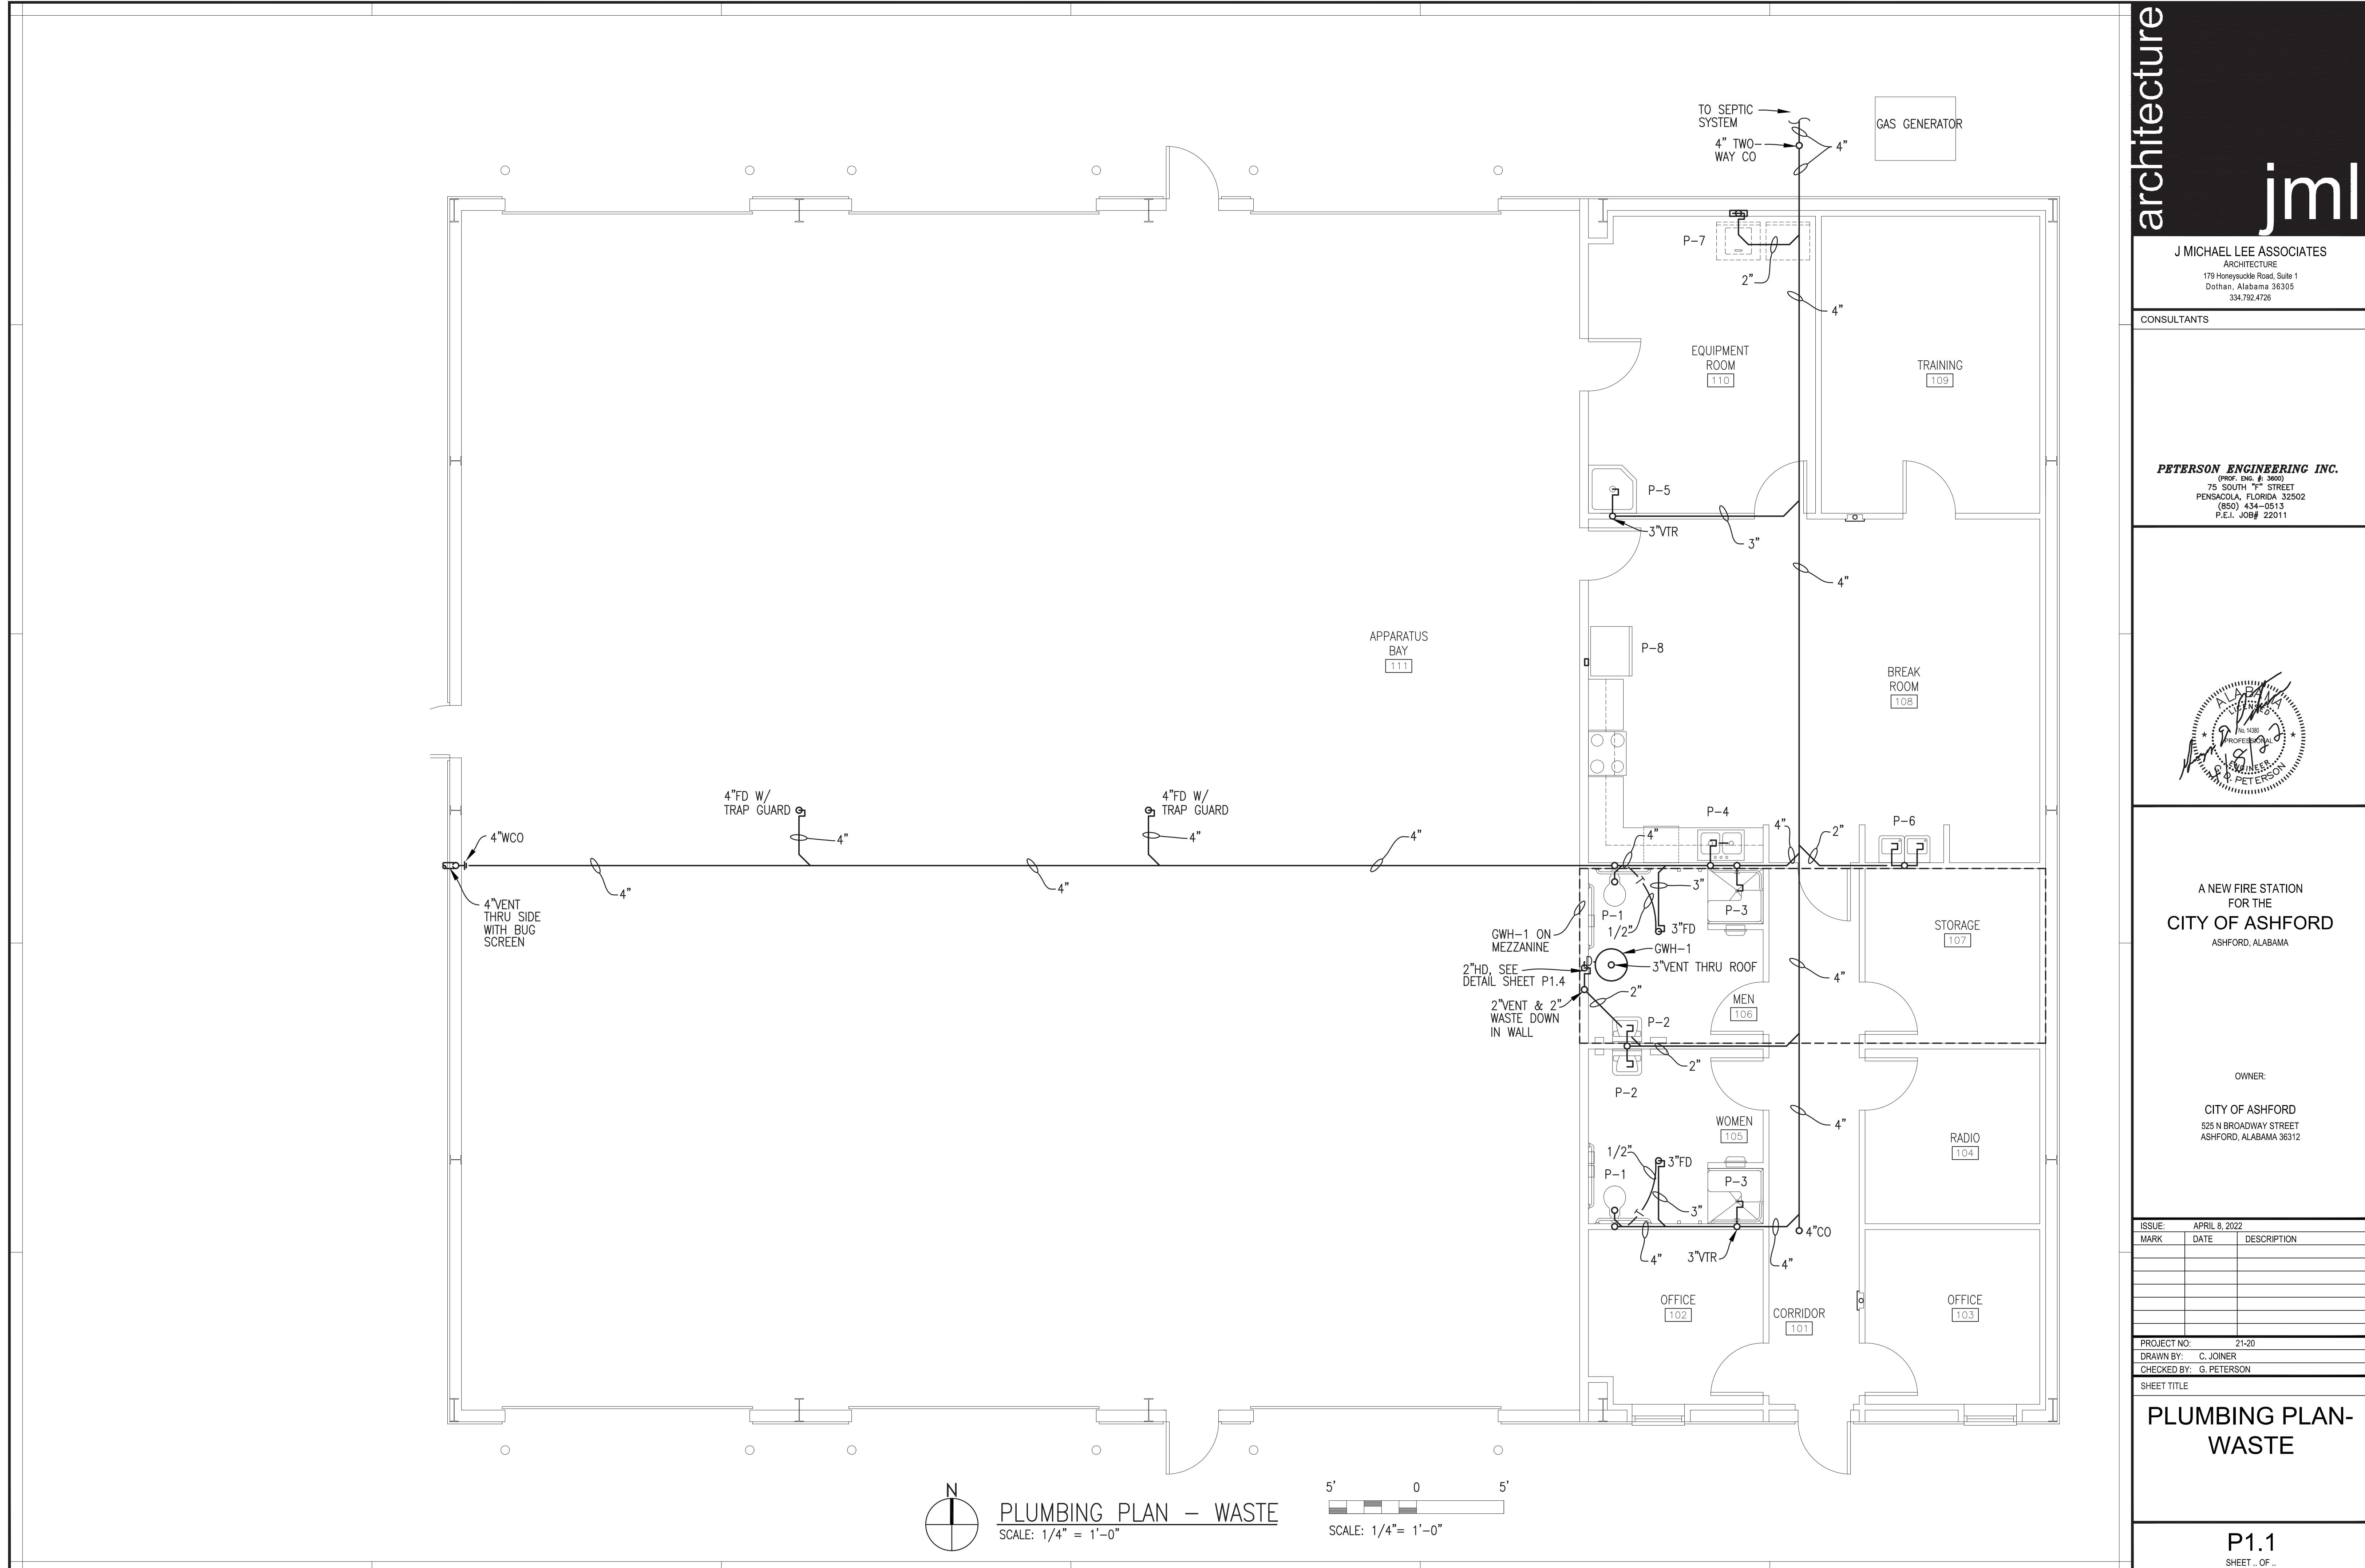

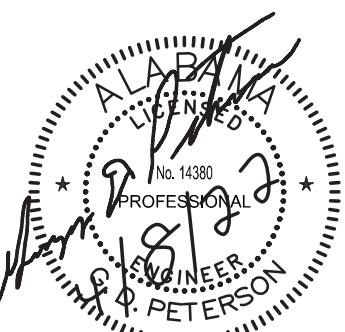

A NEW FIRE STATION  
FOR THE  
**CITY OF ASHFORD**  
ASHFORD, ALABAMA

**OWNER:**


CITY OF ASHFORD  
25 N BROADWAY STREET  
ASHFORD, ALABAMA 36312

APRIL 8, 2022

CT NO: 21-20  
BY: C. JOINER  
ED BY: G. PETERSON  
TITLE

# PLUMBING PLAN - WATER & GAS

P1.2  
SHEET .. OF ..

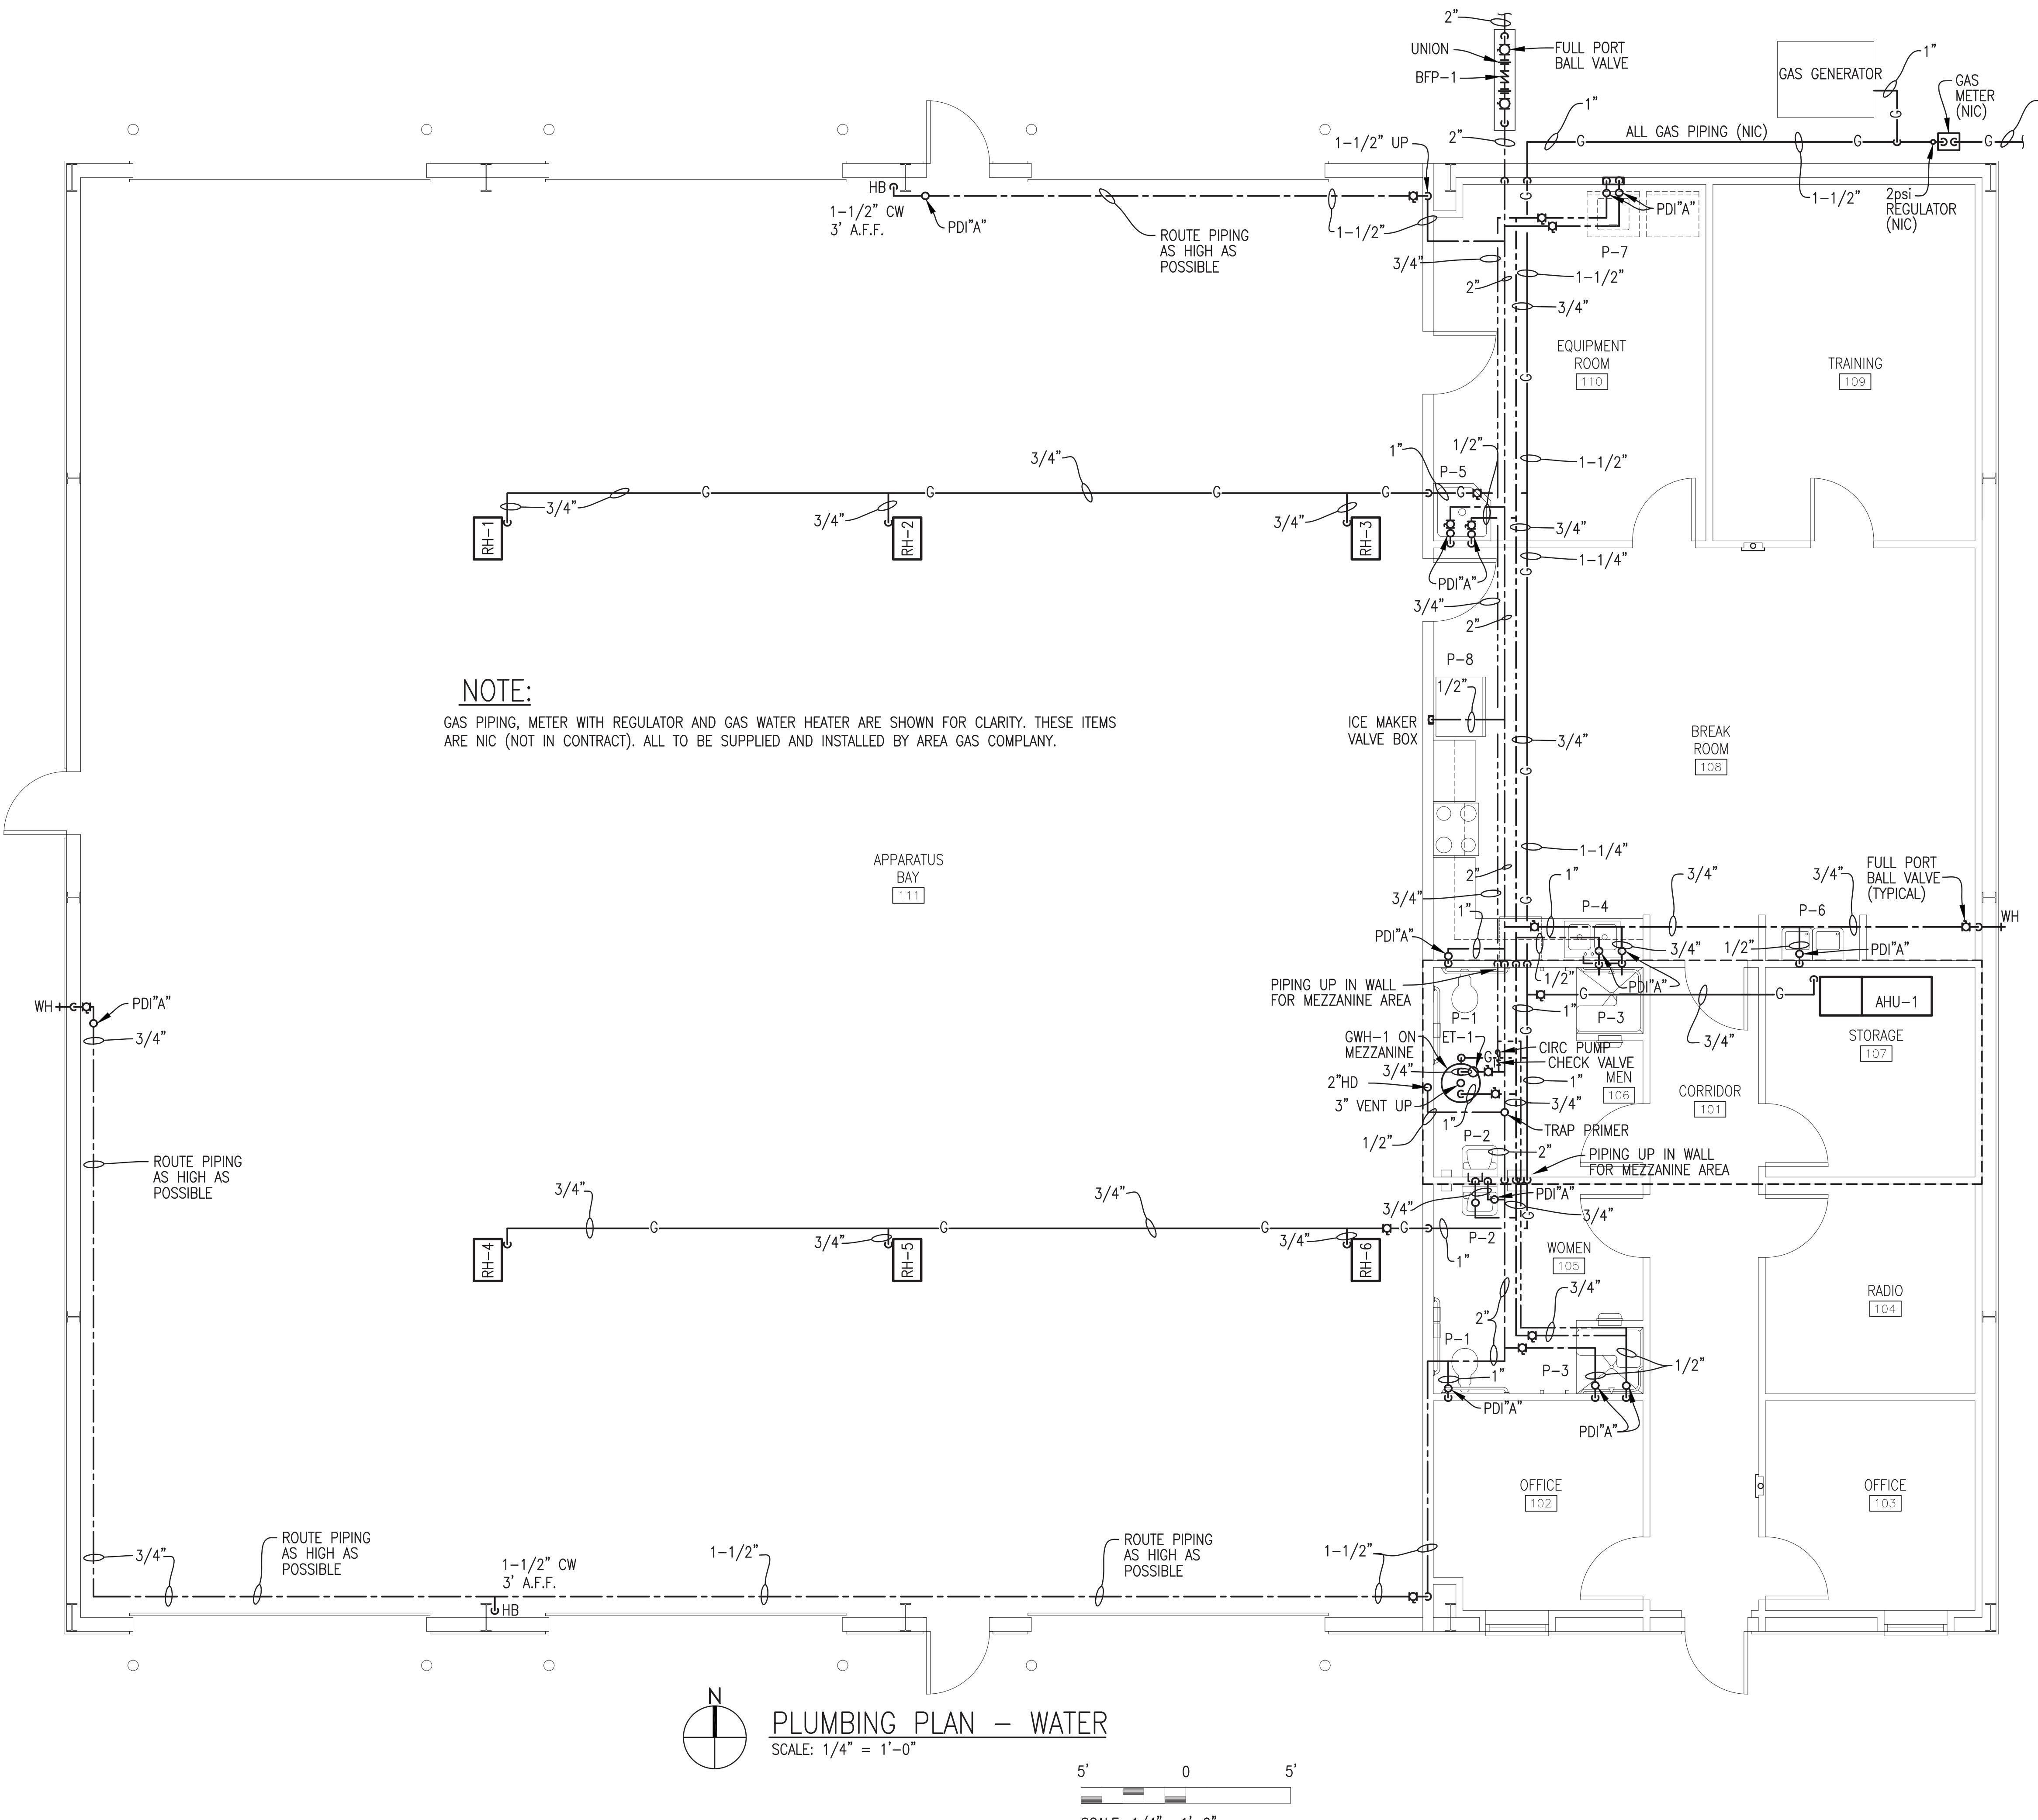



A NEW FIRE STATION  
FOR THE  
CITY OF ASHFORD  
ASHFORD, ALABAMA

OWNER:

CITY OF ASHFORD  
525 N BROADWAY STREET  
ASHFORD, ALABAMA 36312

ISSUE: APRIL 8, 2022  
MARK DATE DESCRIPTION

PROJECT NO: 21-20  
DRAWN BY: C. JOINER  
CHECKED BY: G. PETERSON  
SHEET TITLE

SCHEDULES AND  
LEGEND

P1.3  
SHEET OF ..

### Fixture Connection Schedule

MARK	DESCRIPTION	WASTE	CW	HW	REMARKS
P-1	WATER CLOSET (ADA)	4"	1"	--	FLOOR MOUNTED VITREOUS CHINA FLUSH VALVE TYPE MOUNTED FOR ADA AT 1.28 GPF
P-2	LAVATORY (ADA)	1-1/4"	1/2"	1/2"	WALL HUNG VITREOUS CHINA WITH SINGLE LEVER FAUCET FOR ADA AT 0.5 GPM
P-3	SHOWER (ADA)	2"	1/2"	1/2"	ROLL IN WITH FOLD DOWN TRANSFER SEAT, 30" SLIDE BAR WITH 60" HAND HELD SHOWER HEAD
P-4	KITCHEN SINK	1-1/2"	1/2"	1/2"	TWO COMPARTMENT STAINLESS STEEL WITH GOOSENECK FAUCET AND SPRAYER
P-5	MOP SINK	3"	1/2"	1/2"	FLOOR MOUNTED TERRAZZO WITH WALL MOUNTED FAUCET, 3/4" HOSE CONNECTION, VACUUM BREAKER AND MOP HANGER
P-6	WATER COOLER (ADA)	1-1/2"	1/2"	--	SPLIT LEVEL BUBBLER STYLE WITH BOTTLE FILLER
P-7	WASHER BOX	2"	1/2"	1/2"	WALL RECESSED
P-8	ICE MAKER VALVE BOX	--	1/2"	--	WALL RECESSED
P-9	ELECTRIC STOVE	--	--	--	STAND ALONE
FD	FLOOR DRAIN	3"	--	--	PROVIDE WITH DEEP SEAL TRAP AND PRIMER UNLESS OTHERWISE NOTED
WH	WALL HYDRANT	--	3/4"	--	FREEZE PROOF WITH VACUUM BREAKER AND SHUT OFF VALVE
HB	HOSE BIBB	--	1-1/2"	--	FREEZE PROOF WITH VACUUM BREAKER AND SHUT OFF VALVE

(ADA) DENOTES FIXTURES TO BE MANUFACTURED AND MOUNTED FOR AMERICANS WITH DISABILITIES ACT USE. INSULATE SUPPLIES AND P-TRAP.

### Expansion Tank Schedule

MARK	TYPE	VOLUME ACCEPTANCE	VOLUME	AIR CHARGE	MAX. WORKING PRESSURE	REMARKS BASIS OF DESIGN:
ET-1	VERTICAL	0.9 GAL	2.1 GAL	SYSTEM PRESSURE	150 PSI	AMTROL - ST-5

### Backflow Preventer Schedule

NUMBER	LINE SIZE, IN.	GPM	MAX. PRESSURE DROP	REMARKS *
BFP-1	2"	HOLD	10#	HORIZONTAL TYPE WITH SHUTOFF VALVES

* REDUCED PRESSURE TYPE

### GAS WATER HEATER SCHEDULE - NIC (BASIS OF DESIGN)

MARK	MBH NAT. GAS INPUT	GALLONS PER HR RECOVERY	TEMP. RISE °F	TANK CAP.	FLUE SIZE	GAS CONN.	ELECTRICAL			REMARKS
							HP	Volts	PH	
GWH-1	40	41	90	50 GAL	3"	1/2"	1/25	120	1	60 CIRCULATING PUMP TO BE BRONZE FLANGED

### Legend:


—	SOIL OR WASTE PIPING
—	VENT PIPING
—	COLD WATER PIPING
—	HOT WATER PIPING
T	TRAP PRIME PIPING
D	DRAIN PIPING
G	GAS PIPING
GWH	GAS WATER HEATER
ET	EXPANSION TANK
FD	FLOOR DRAIN
VTR	VENT THRU ROOF
WH	WALL HYDRANT
BFP	BACKFLOW PREVENTER
CO	CLEANOUT
HD	HUB DRAIN
PDI	PLUMBING AND DRAINAGE INSTITUTE
HB	HOSE BIBB
WCO	WALL CLEANOUT
NIC	NOT IN CONTRACT

### Plumbing Specifications:

- REGULATORY REQUIREMENTS
  - THE CONTRACTOR SHALL COMPLY WITH ALL LEGAL REGULATIONS THAT MAY BE NECESSARY FOR FULLY COMPLETEING THE WORK. WHEN THE CONTRACTOR FINDS THE SPECIFICATIONS AND/OR DRAWINGS TO BE IN CONFLICT OR NOT CLEAR, OR ANY PORTION TO BE IN CONFLICT WITH ANY APPLICABLE CODE OR REGULATION, SAME SHALL BE BROUGHT TO THE ATTENTION OF THE ARCHITECT PRIOR TO SUBMITTING A BID. ALL WORK IN THIS SECTION SHALL BE IN COMPLIANCE WITH THE FLORIDA BUILDING CODE - PLUMBING, THE STATE OF FLORIDA DEPARTMENT OF HEALTH, CHAPTER 64E-6, FLORIDA ADMINISTRATIVE CODE, AND FLORIDA BUILDING CODE - GAS. LATEST APPROVED ADDITION.
- DELIVERY, STORAGE, AND HANDLING
  - DELIVERY, STORE, PROTECT AND HANDLE PRODUCTS TO SITE ACCORDING TO THE MANUFACTURER'S RECOMMENDATIONS.
  - ALL PIPE OPENINGS SHALL BE ENCLOSED WITH PLUGS OR CAPS DURING CONSTRUCTION AND NOT BE REMOVED UNTIL FINAL CONNECTIONS ARE MADE.
- WATER PIPING
  - HARD COPPER TUBE: ASTM B 88, TYPE L
    - 1. FITTINGS: COPPER PUSH-ON ASME B16.22.
- DRAIN WASTE AND VENT PIPING
  - POLYVINYL CHLORIDE PLASTIC PIPE (PVC); TYPE DWV; PVC PLASTIC TYPE DWV SOCKET-TYPE FITTING, SOLVENT CEMENT JOINTS.
- HOSE BIBBS
  - PROVIDE ANGLE TYPE COPPER ALLOY HOSE BIBB WITH LOCK SHIELD AND HAND WHEEL. INLET SHALL HAVE INTERNAL THREADS. OUTLET SHALL HAVE VACUUM BREAKER WITH 3/4" EXTERNAL HOSE THREADS.
- GAS PIPING
  - PROVIDE BLACK STEEL SCHEDULE 40 WITH MALLEABLE IRON OR STEEL FITTINGS.
  - GAS PIPING AND METER W/REGULATOR (NIC) TO BE SUPPLIED AND INSTALLED BY AREA GAS COMPANY.
- FIXTURES, FITTINGS, ACCESSORIES, AND SUPPLIES
  - PROVIDE CONTROL-STOP VALVES IN EACH SUPPLY TO EACH FIXTURE. THE FINISH OF FITTINGS, ACCESSORIES, AND SUPPLIES EXPOSED TO VIEW SHALL BE CHROMIUM-PLATED PER ASME A112.18.1M. CENTER SET FAUCETS SHALL BE TOP-MOUNTED WITH INLETS ON NOT GREATER THAN 4-INCH CENTERS. PROVIDE SPECIAL ROUGHING-IN FOR WHEELCHAIR FIXTURES.
- FLUSH VALVE TYPE WATER CLOSETS (P-1): ASME A112.19.2M, WHITE VITREOUS CHINA, FLOOR MOUNTED, FLOOR OUTLET AS INDICATED, SIPHON JET, ELONGATED BOWL, WHITE SOLID PLASTIC ELONGATED OPEN-FRONT SEAT, AND ASME A112.19.5 TRIM. PROVIDE LARGE DIAPHRAGM (NOT LESS THAN 2.625 INCHES UPPER CHAMBER INSIDE DIAMETER AT THE POINT WHERE THE DIAPHRAGM IS SEALED BETWEEN THE UPPER AND LOWER CHAMBERS) NON-HOLD-OPEN FLUSH VALVE OF CHROME PLATED CAST BRASS, INCLUDING VACUUM BREAKER AND ANGLE (CONTROL-STOP) VALVE WITH BACK CHECK. THE WATER FLUSHING VOLUME OF THE FLUSH VALVE AND WATER CLOSET COMBINATION SHALL NOT EXCEED 1.28 GALLONS PER FLUSH.
- WASHER BOX (P-7): VALVES TO MEET ASME A112.18.1 PVC BOX WITH "AA" WATER HAMMER ARRESTOR COMPLYING WITH ASSE STANDARD 1010 AND 2" DRAIN OPENING.
- ICE MAKER VALVE BOX (P-8): BOX IS 20 GAUGE GALVANIZED STEEL WITH VALVE TO MEET ASME 112.18.1 WITH "AA" WATER HAMMER ARRESTOR ASSE STANDARD 1010.
- ALL FLOOR DRAINS SHALL HAVE A DEEP SEAL P-TRAP AND BE PROVIDED WITH TRAP PRIME PIPING UNLESS OTHERWISE NOTED.

### Schedules and Legend

P1.3  
SHEET OF ..

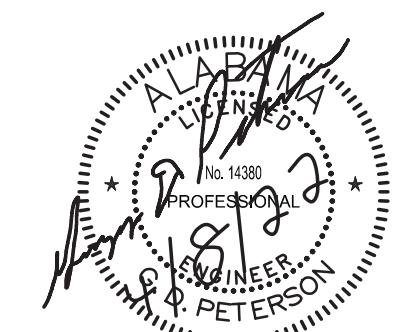
A NEW FIRE STATION  
FOR THE  
CITY OF ASHFORD  
ASHFORD, ALABAMA

OWNER:

CITY OF ASHFORD  
525 N BROADWAY STREET  
ASHFORD, ALABAMA 36312ISSUE: APRIL 8, 2022  
MARK DATE DESCRIPTIONPROJECT NO: 21-20  
DRAWN BY: C. JOINER  
CHECKED BY: G. PETERSON


SHEET TITLE

PLUMBING DETAILS

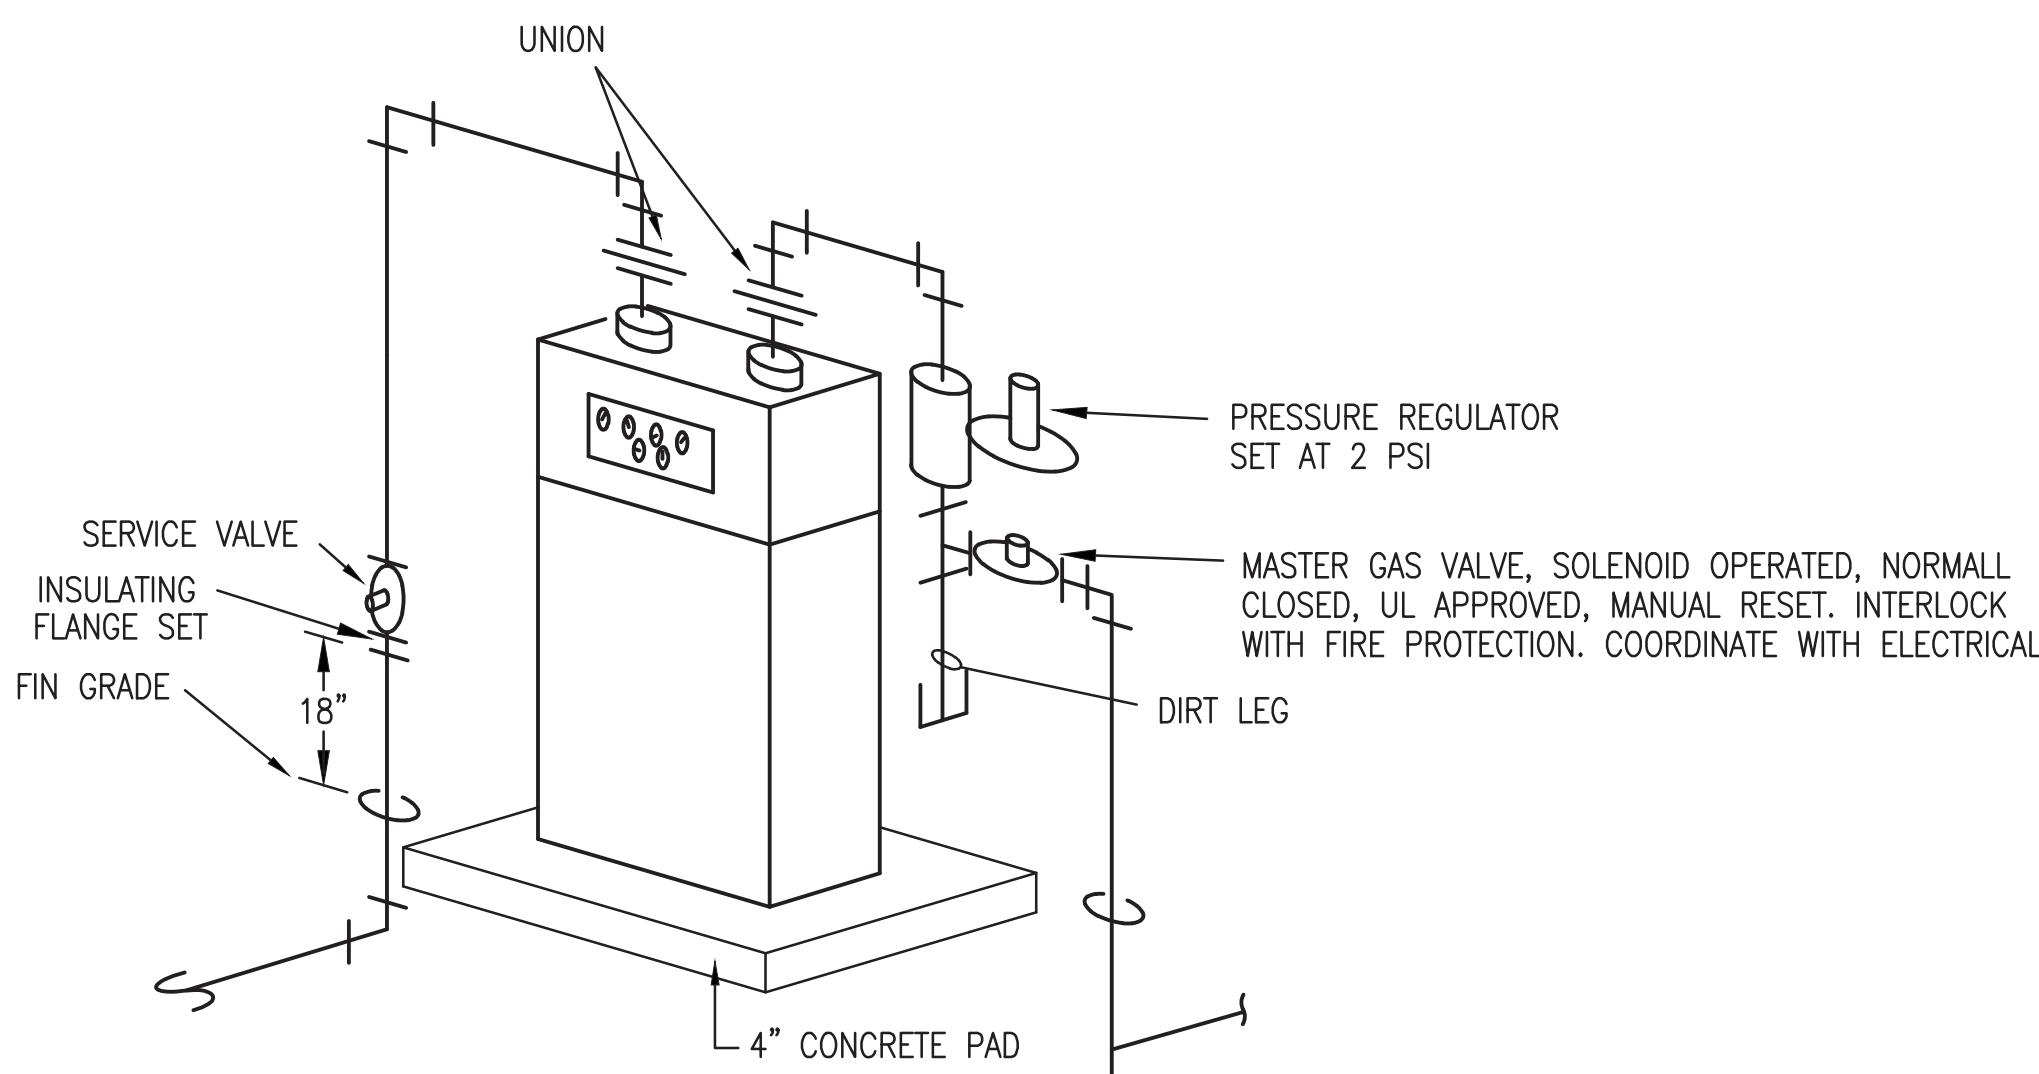


GAS METER CONNECTION DETAIL WITH EMERGENCY SHUTOFF

NOT TO SCALE (NIC)

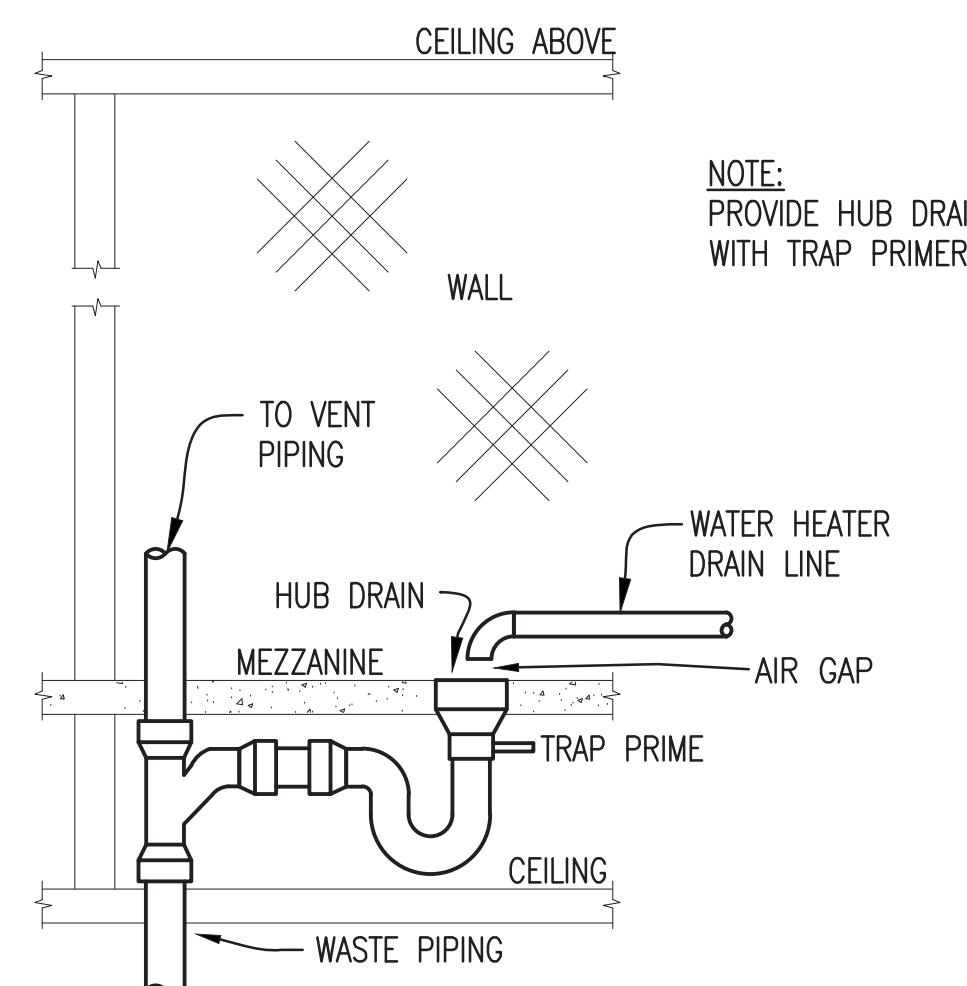


HUB DRAIN DETAIL

NOT TO SCALE (NIC)

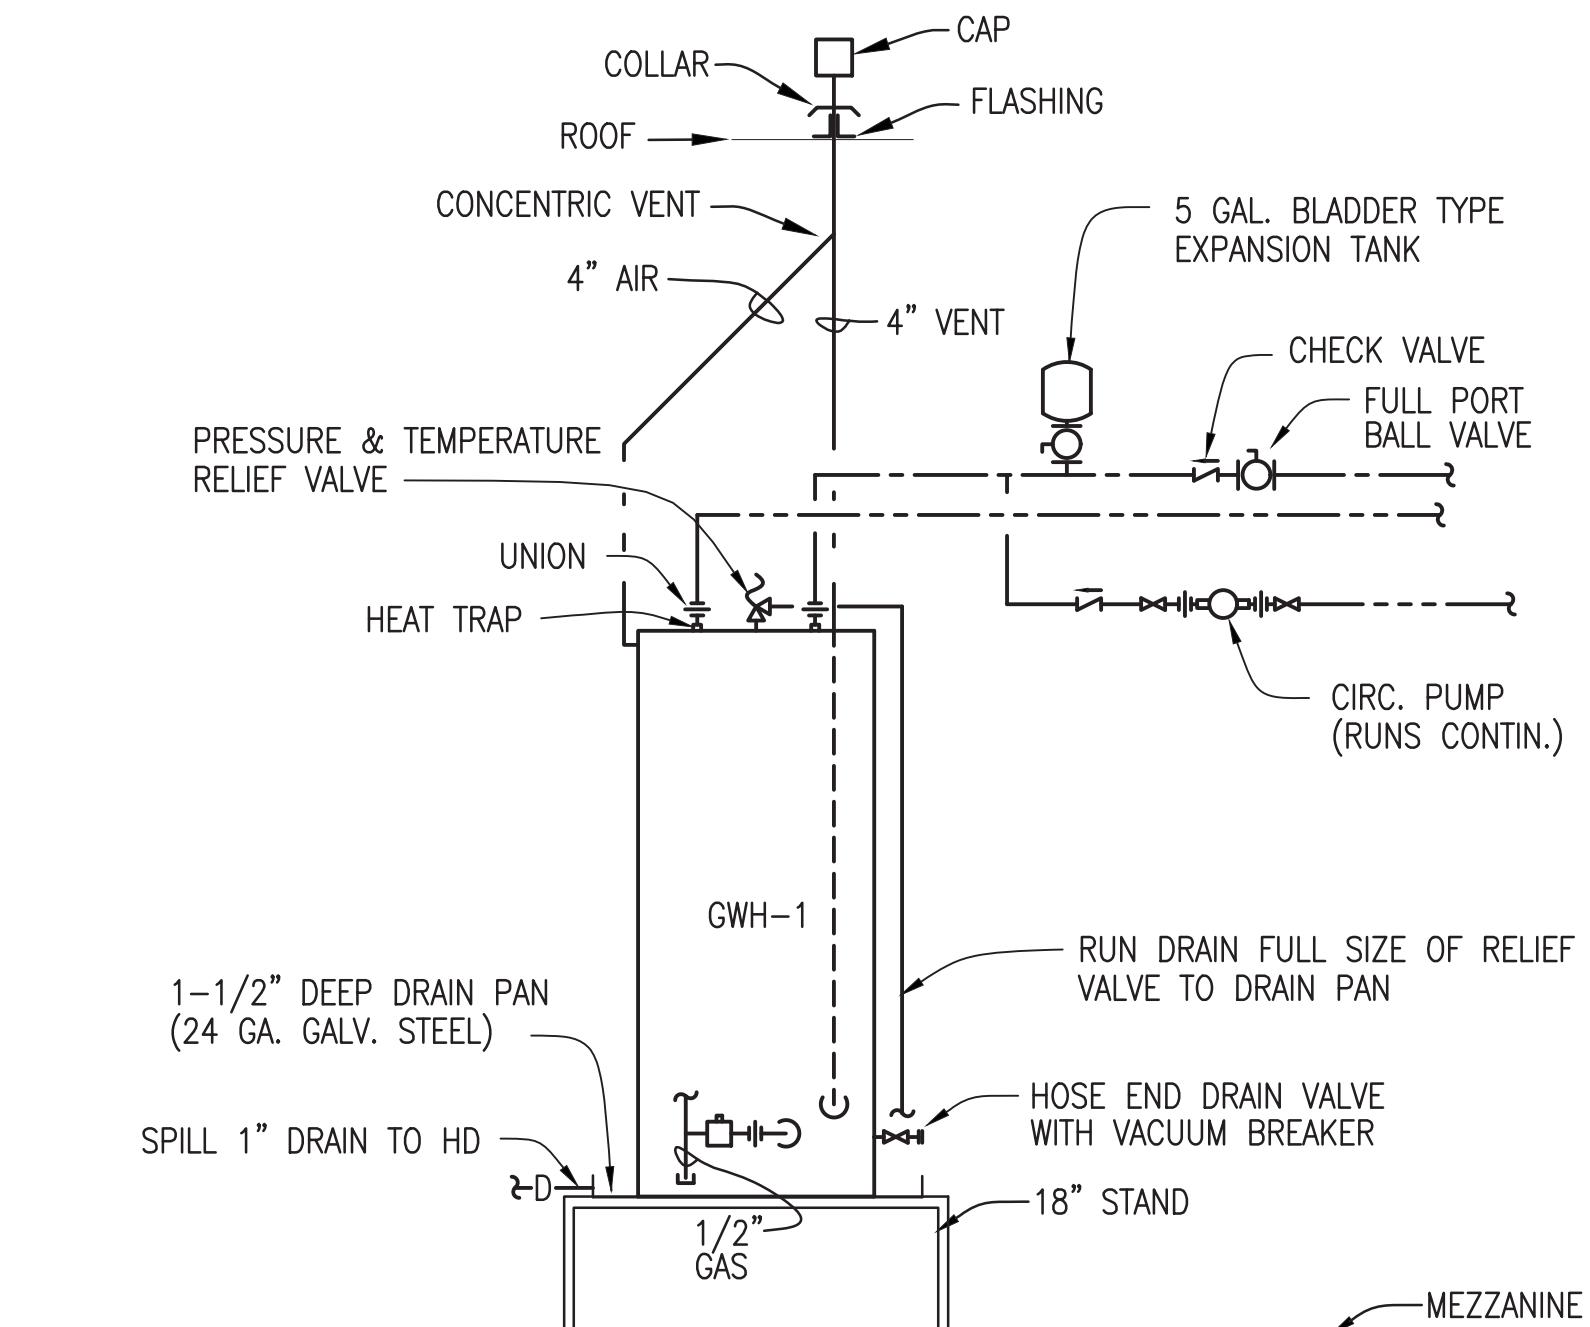


GAS WATER HEATER CONNECTION DETAIL

NOT TO SCALE (NIC)

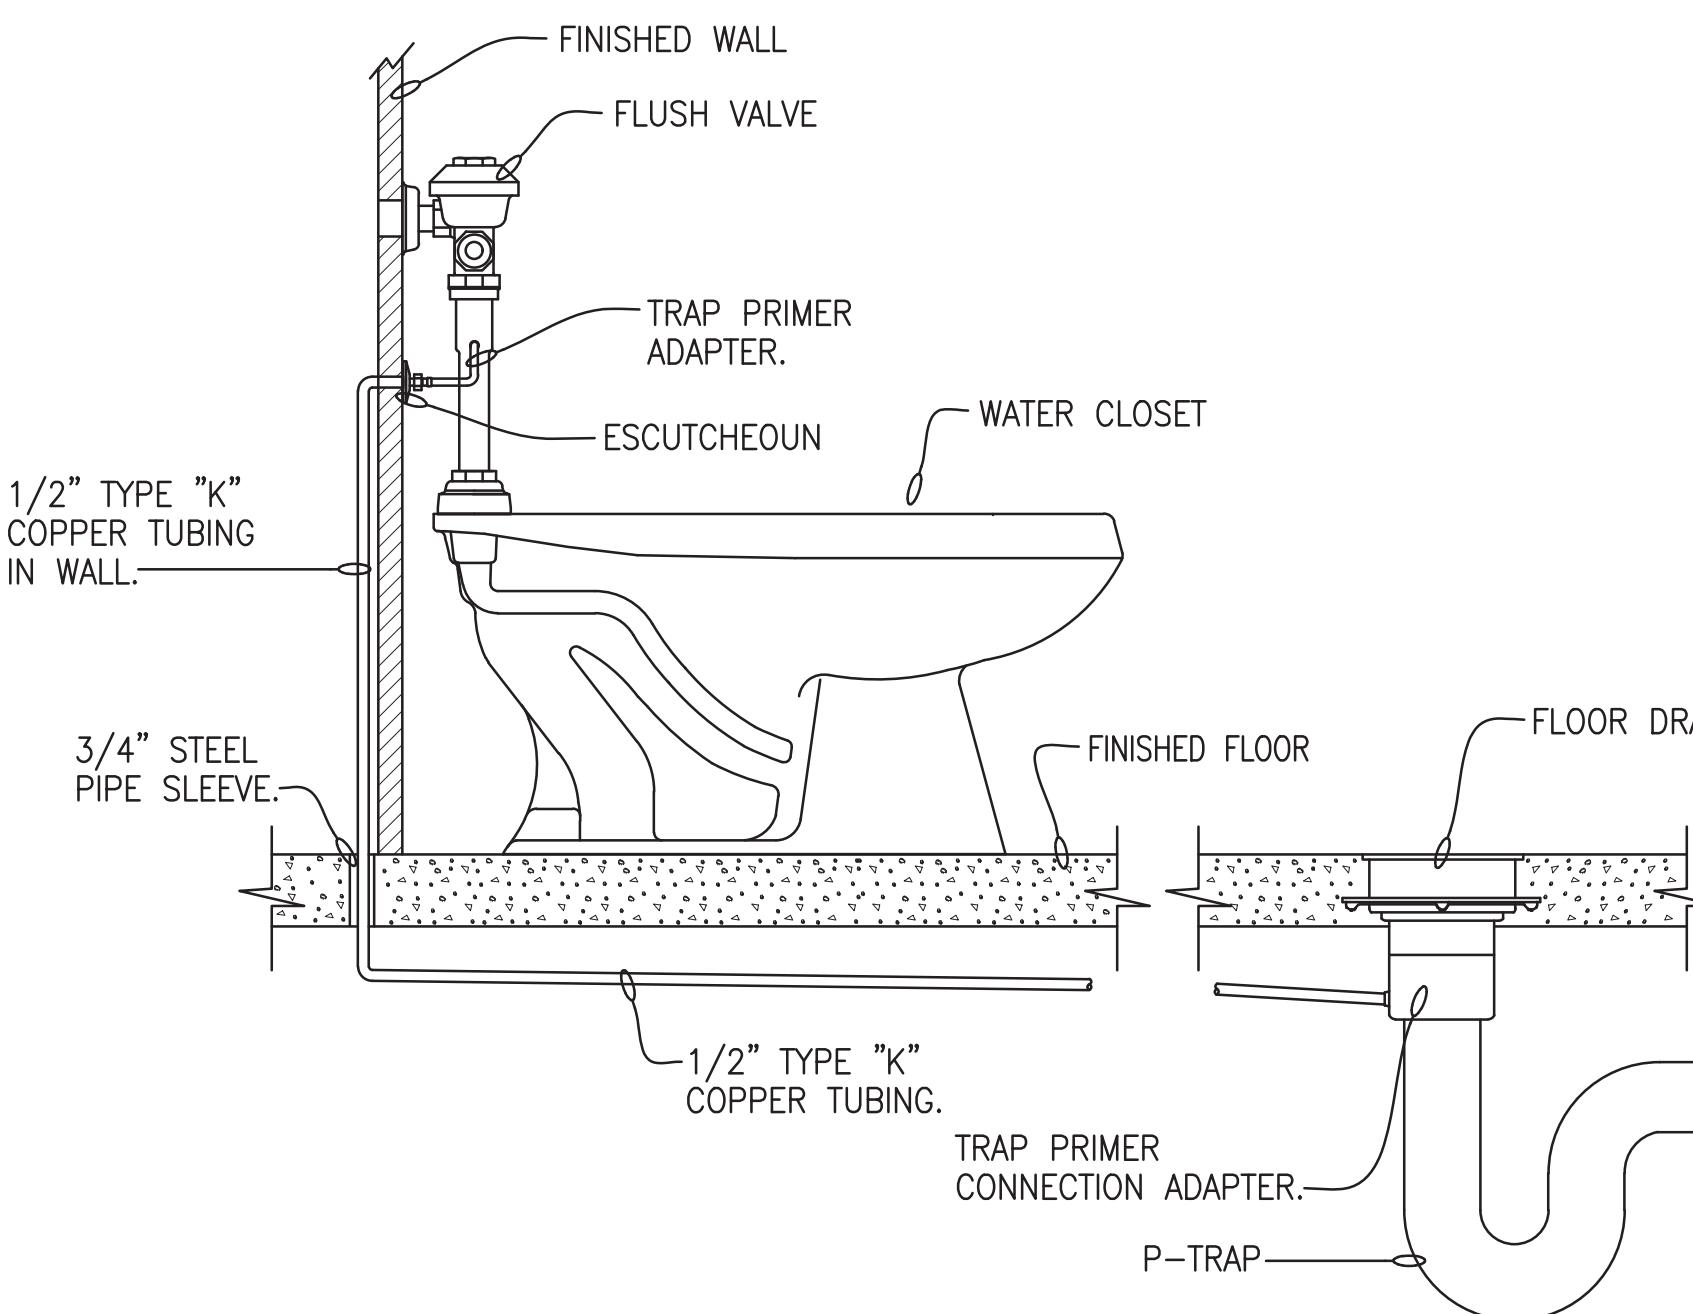


WATER CLOSET TRAP PRIMER INSTALLATION DETAIL

NOT TO SCALE

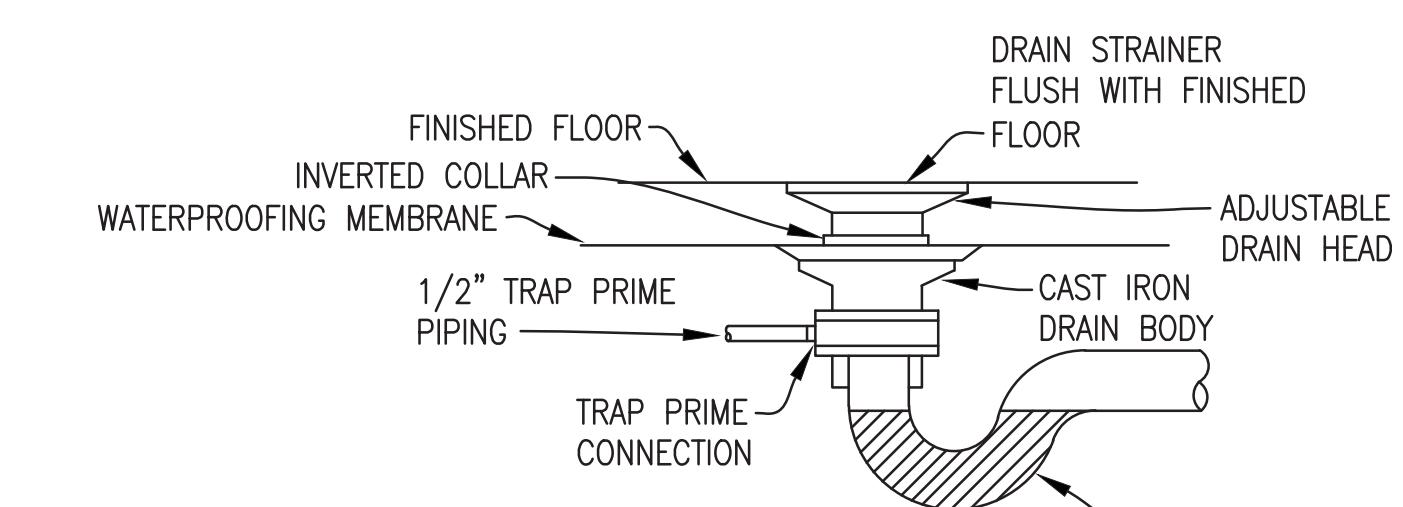


FLOOR DRAIN DETAIL

NOT TO SCALE

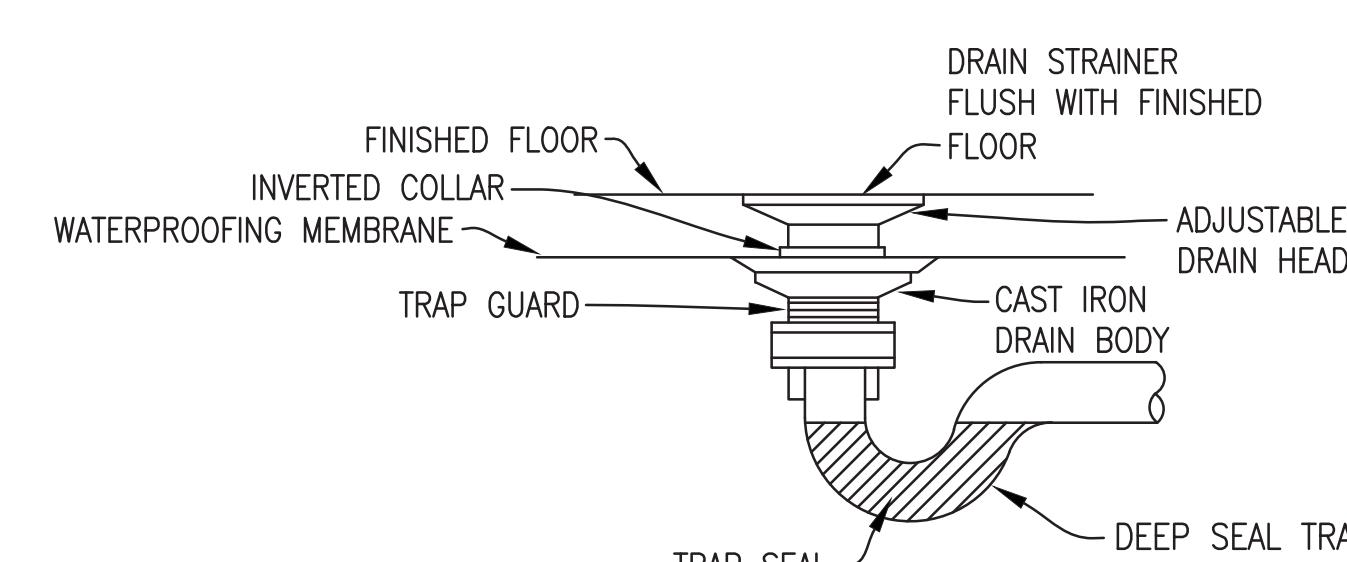

FLOOR DRAIN DETAIL W/ TRAP GUARD

NOT TO SCALE

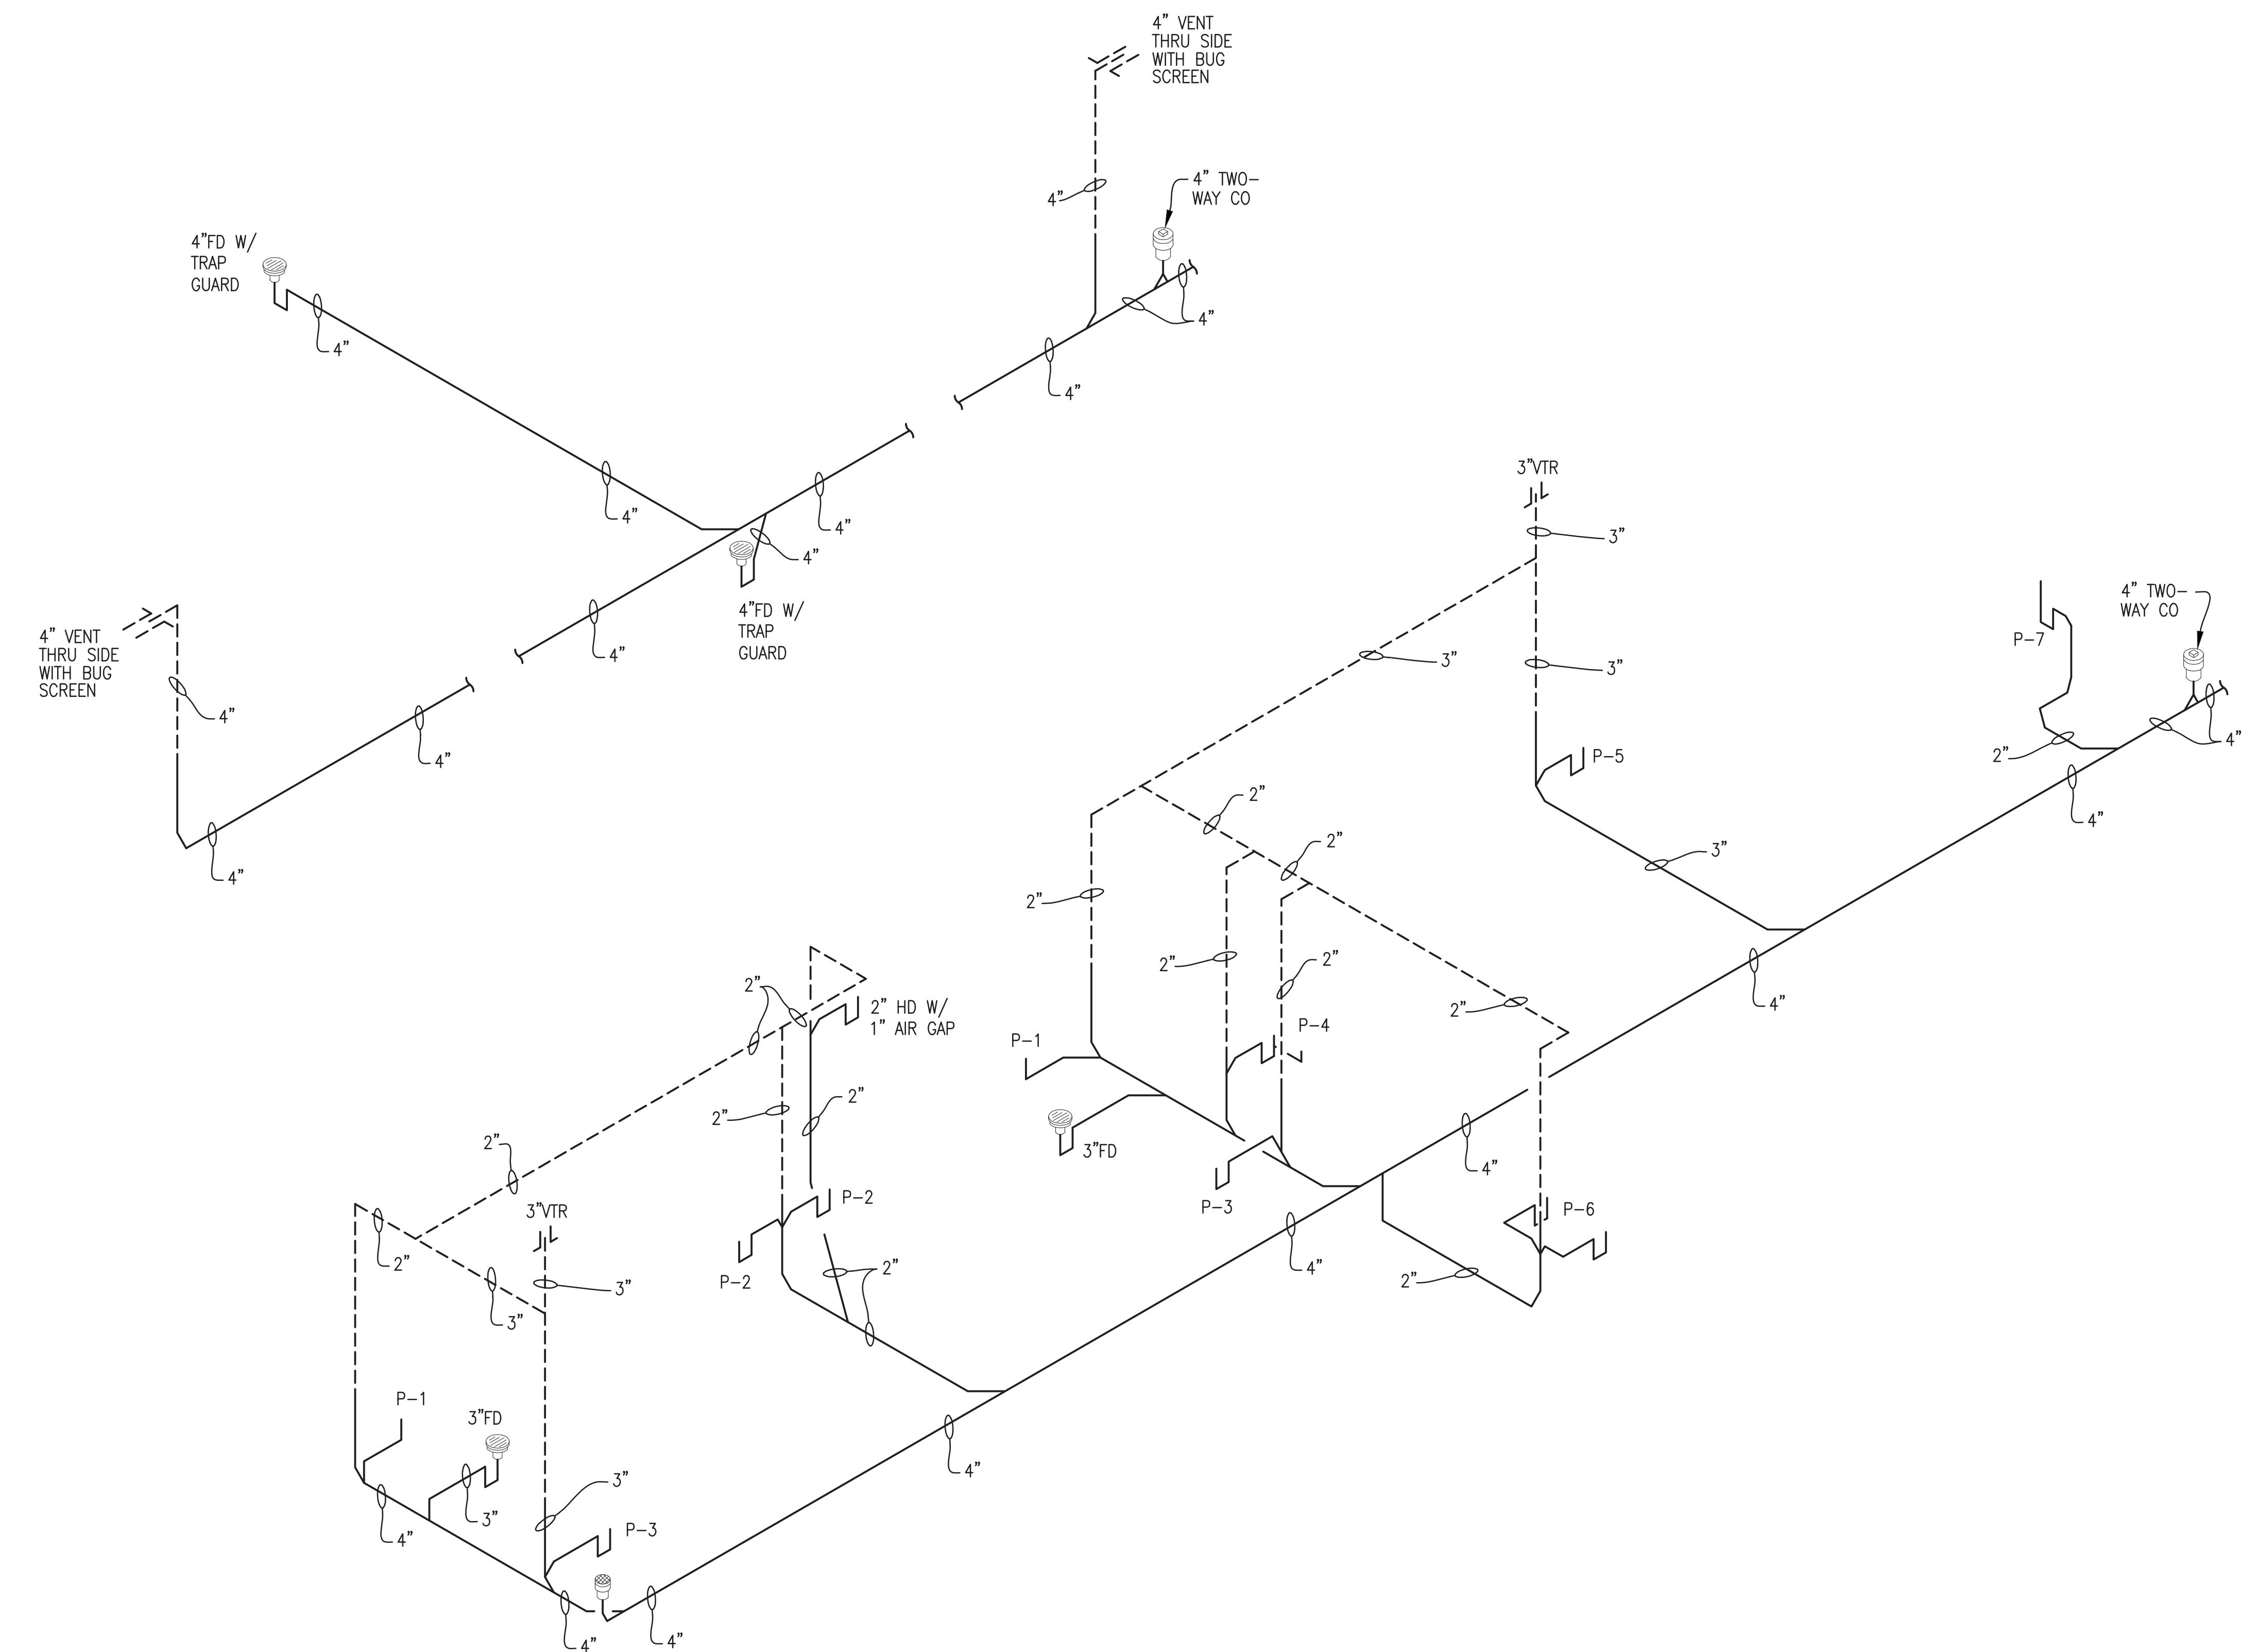

# WASTE AND VENT RISER DIAGRAM

NOT TO SCALE

## WASTE NOT TO SCALE

# Architecture

jm

J MICHAEL LEE ASSOCIATES  
ARCHITECTURE  
179 Honeysuckle Road, Suite 1  
Dothan, Alabama 36305  
334.792.4726

## CONSULTANTS

**PETERSON ENGINEERING INC.**  
(PROF. ENG. #: 3600)  
75 SOUTH "F" STREET  
PENSACOLA, FLORIDA 32502  
(850) 434-0513  
P.E.I. JOB# 22011

A NEW FIRE STATION  
FOR THE  
**CITY OF ASHFORD**  
ASHFORD, ALABAMA

OWNER:


CITY OF ASHFORD  
25 N BROADWAY STREET  
ASHFORD, ALABAMA 36312

UE:	APRIL 8, 2022	
K	DATE	DESCRIPTION

JECT NO:	21-20
WN BY:	C. JOINER
CKED BY:	G. PETERSON

# WASTE AND VENT RISER DIAGRAM

P1.5  
SHEET .. OF ..

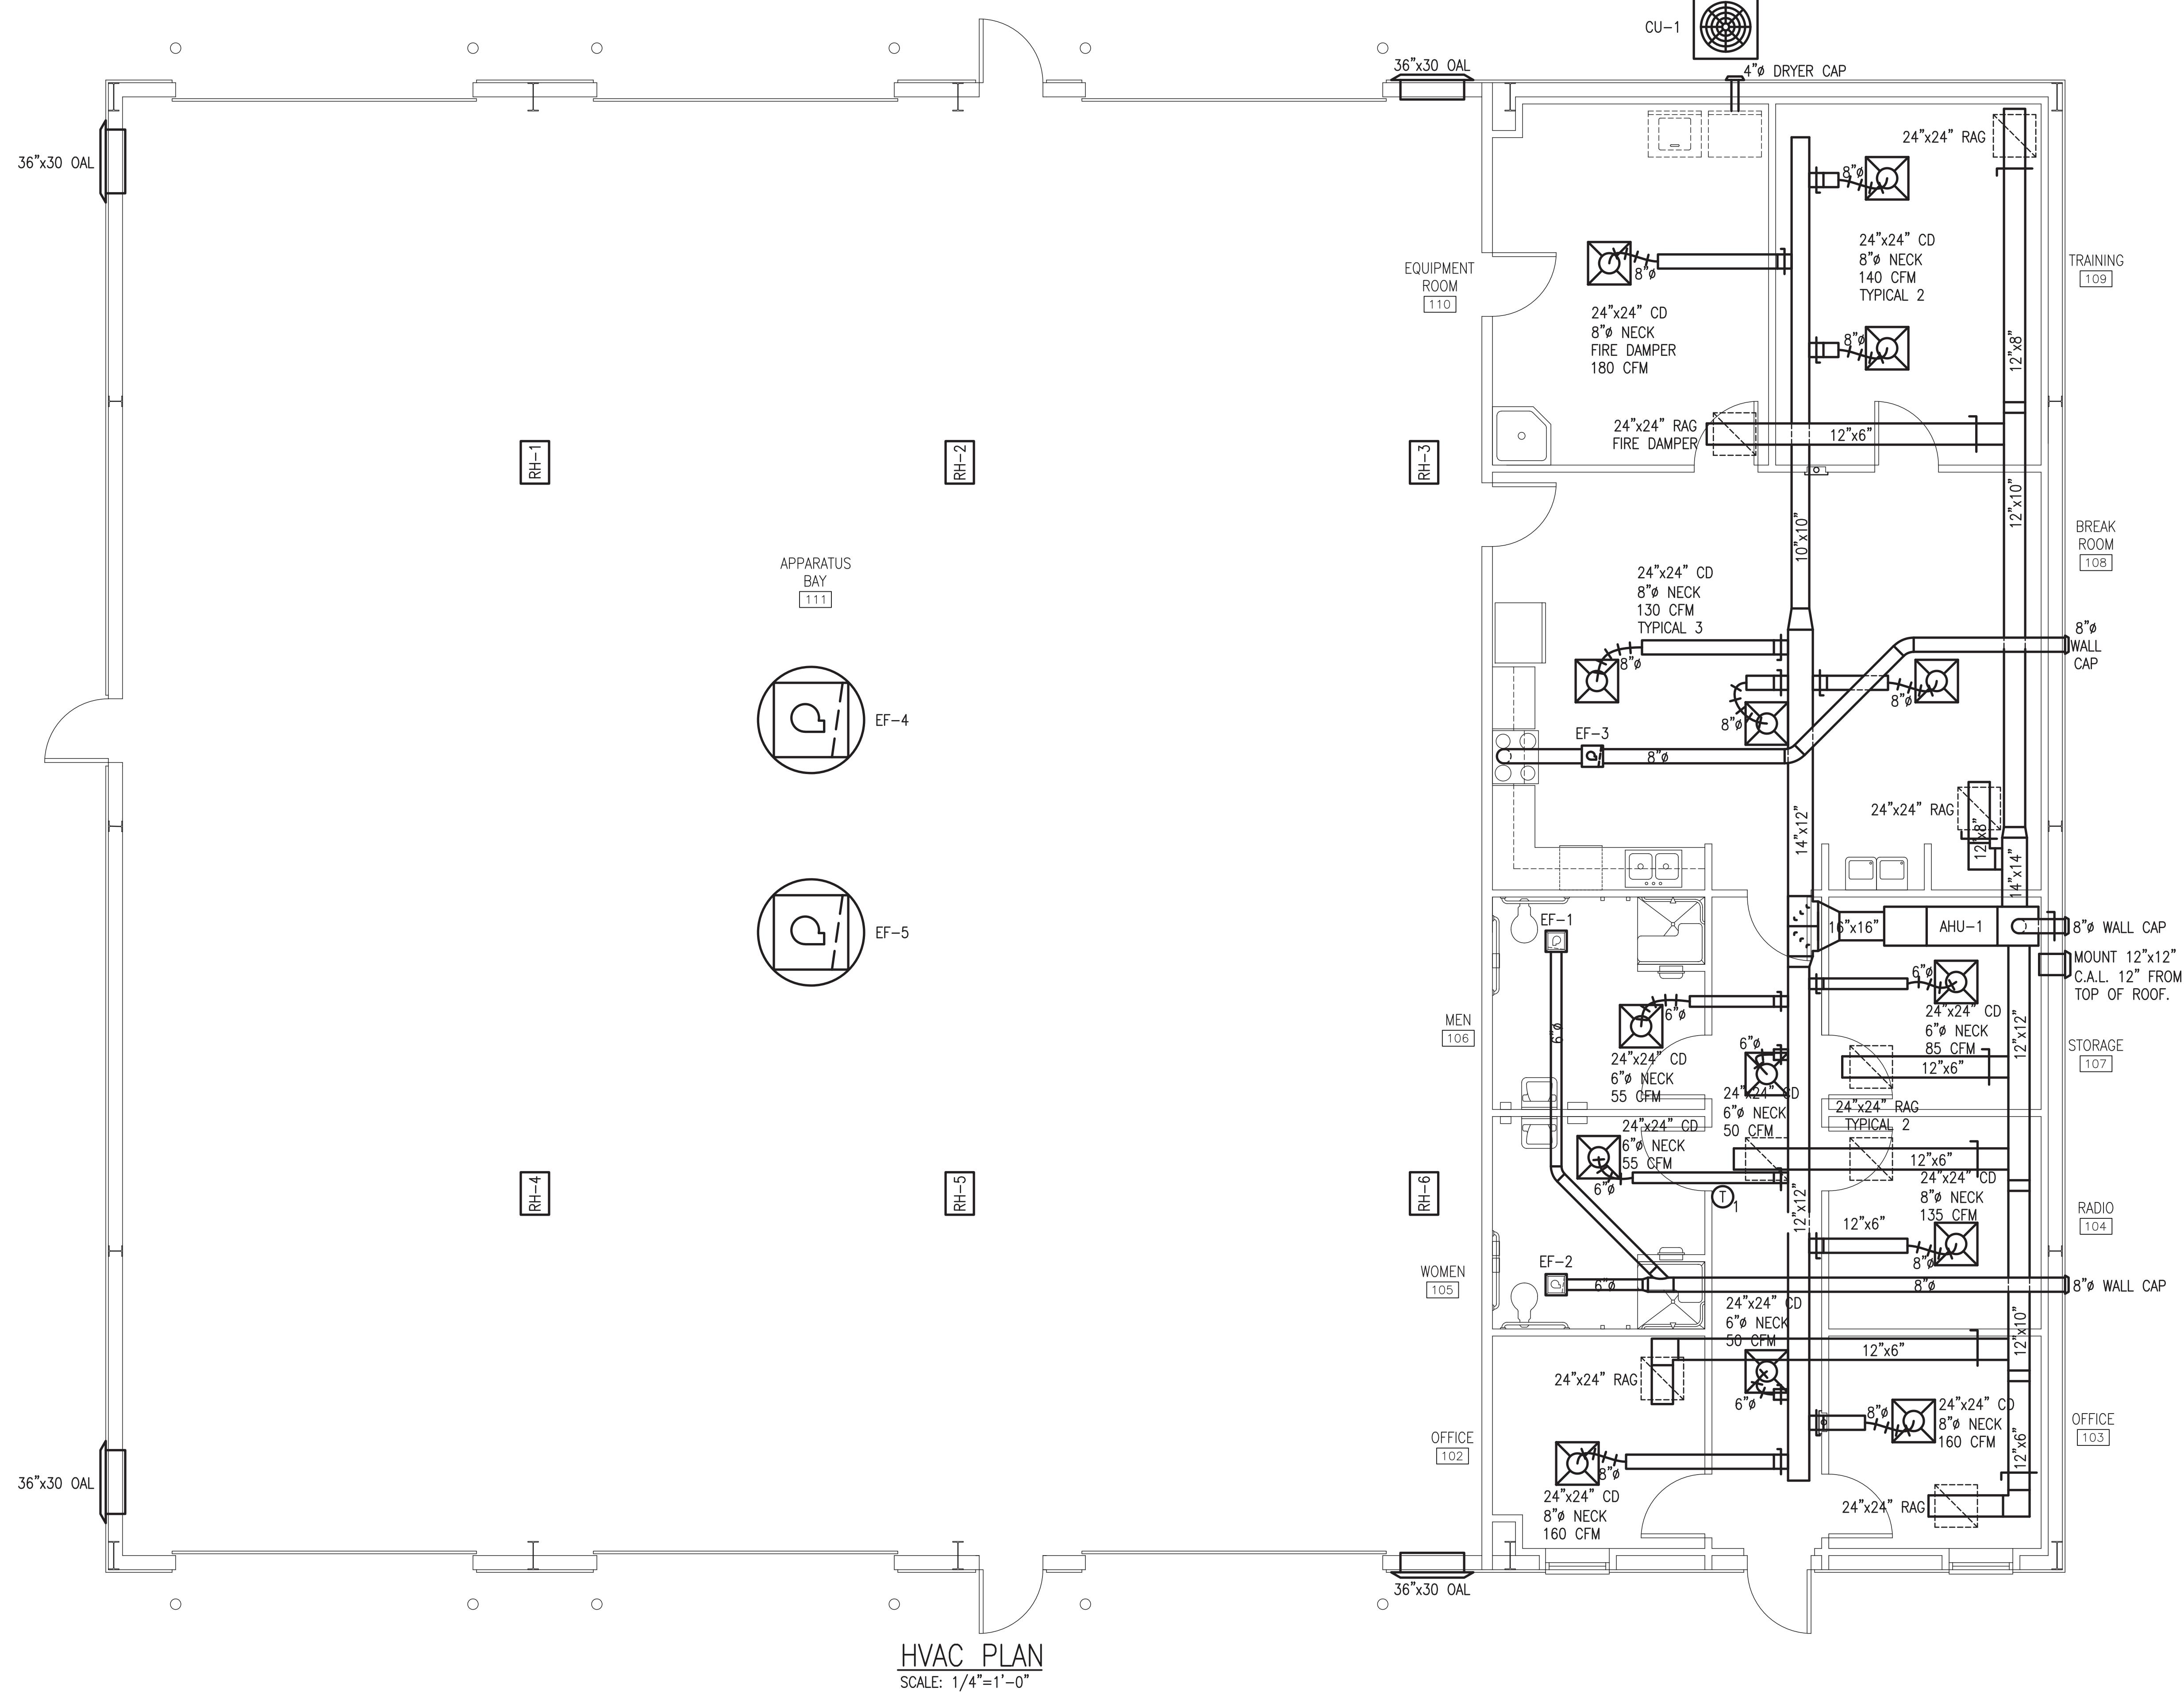

# HVAC PLAN

jml

J MICHAEL LEE ASSOCIATES  
ARCHITECTURE  
179 Honeysuckle Road, Suite 1  
Dothan, Alabama 36305  
334.792.4726

## RESULTS

**PETERSON ENGINEERING INC.**  
(PROF. ENG. #: 3600)  
75 SOUTH "F" STREET  
PENSACOLA, FLORIDA 32502  
(850) 434-0513  
P.E.I. JOB# 22011

# A NEW FIRE STATION FOR THE CITY OF ASHFORD

OWNER:


CITY OF ASHFORD  
25 N BROADWAY STREET  
ASHFORD, ALABAMA 36312

SUE: APRIL 8, 2022


PROJECT NO:	21-20
DRAWN BY:	
CHECKED BY:	
SHEET TITLE	

# HVAC PLAN


# M1.1

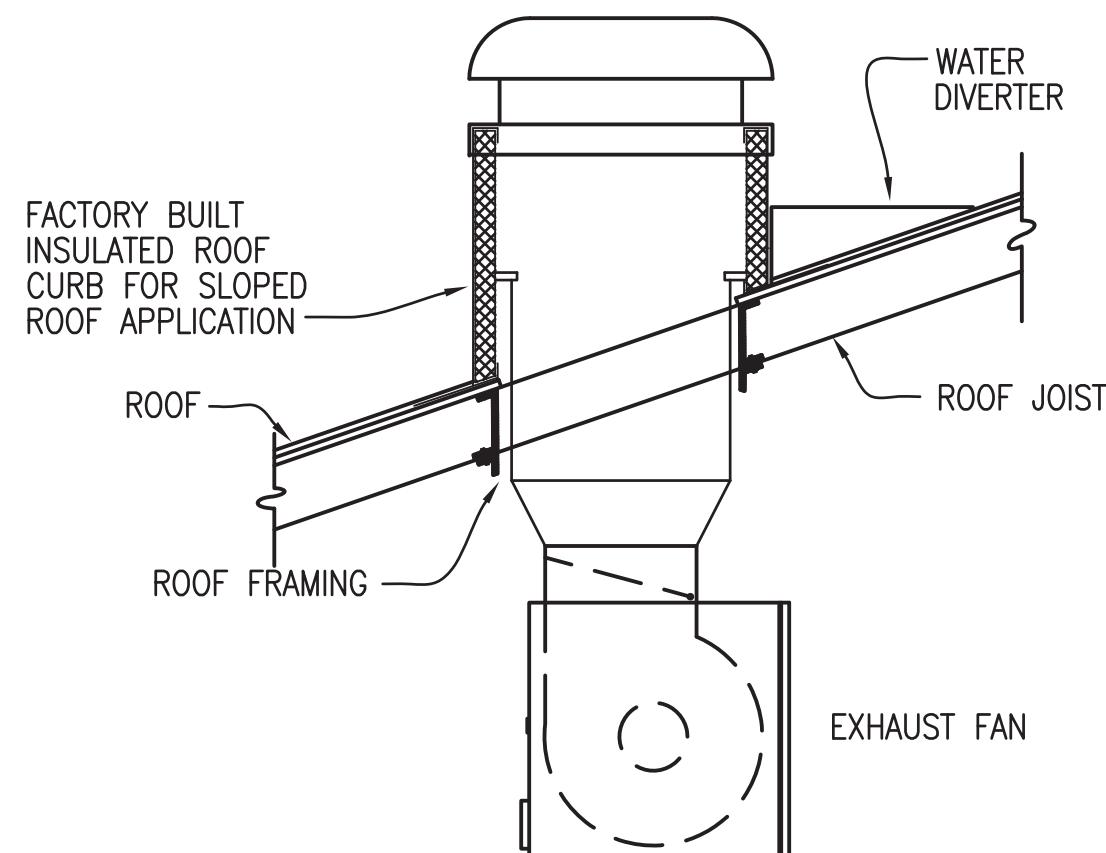


EXHAUST FAN\ROOF CAP DETAIL  
NOT TO SCALE

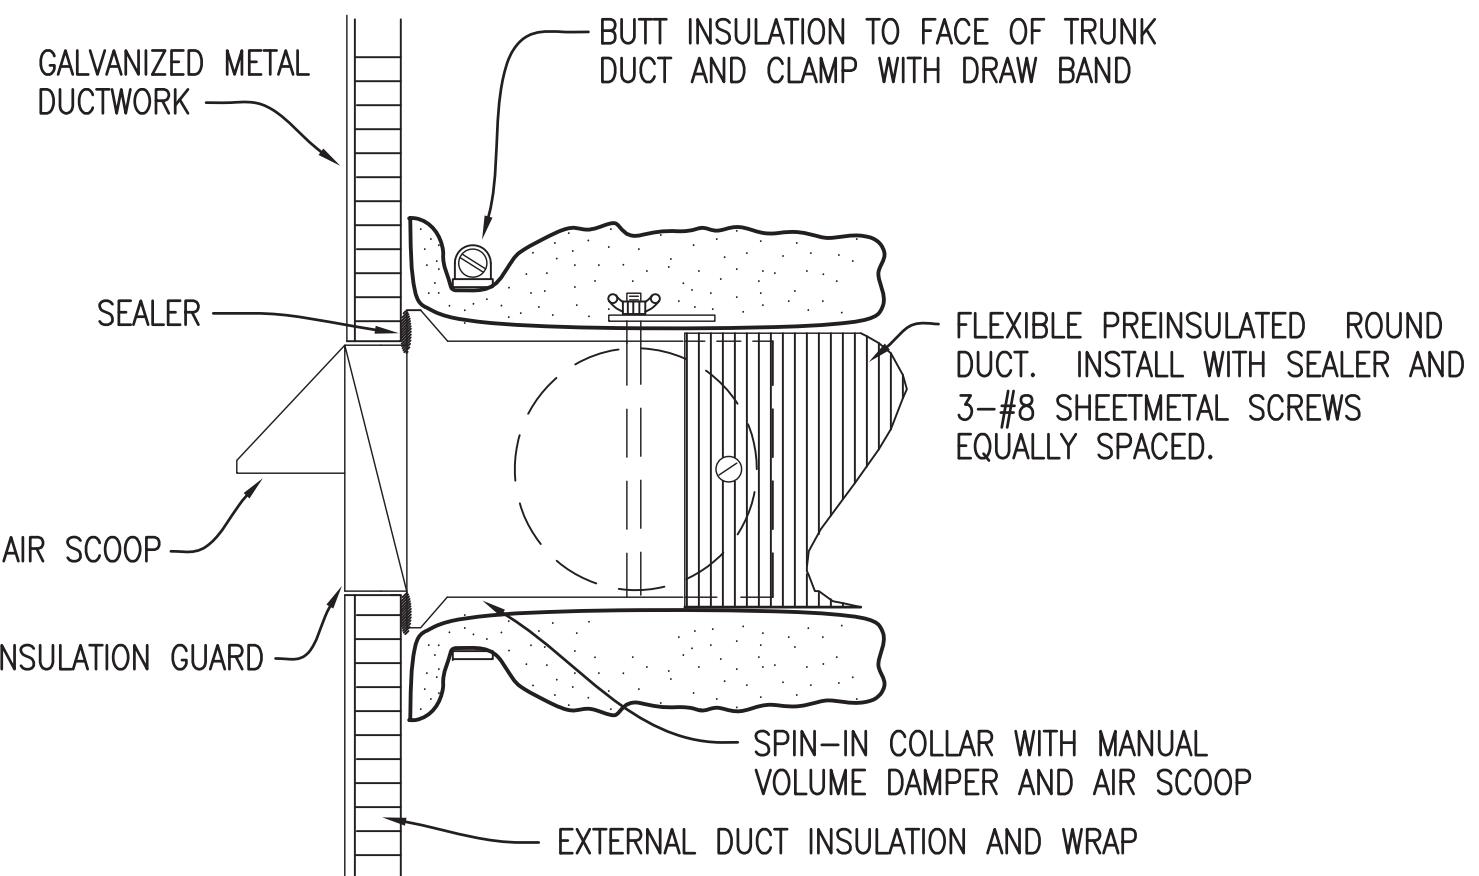


ROUND DUCT TAP-IN MOUNTING DETAIL  
NOT TO SCALE

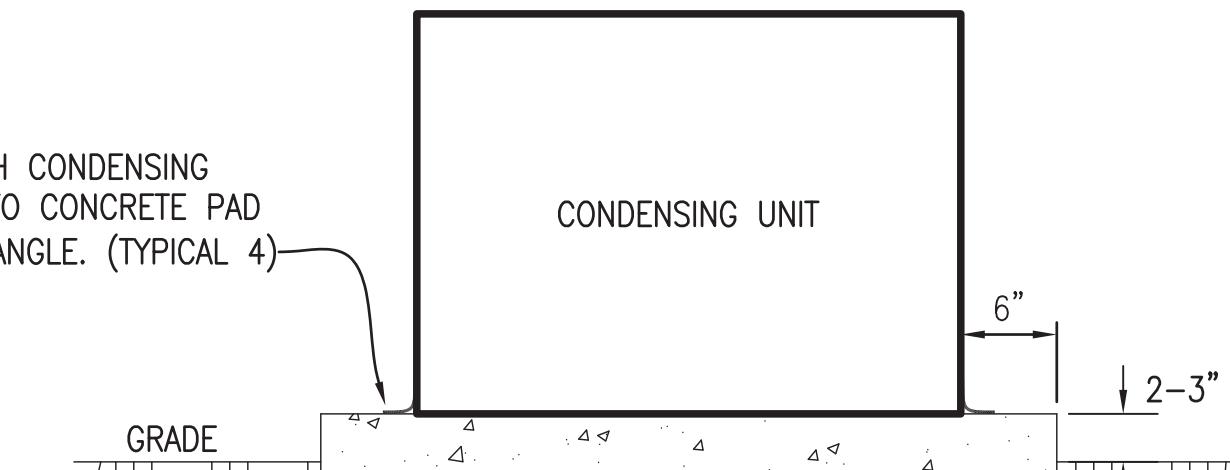


CONDENSING UNIT MOUNTING DETAIL  
NOT TO SCALE

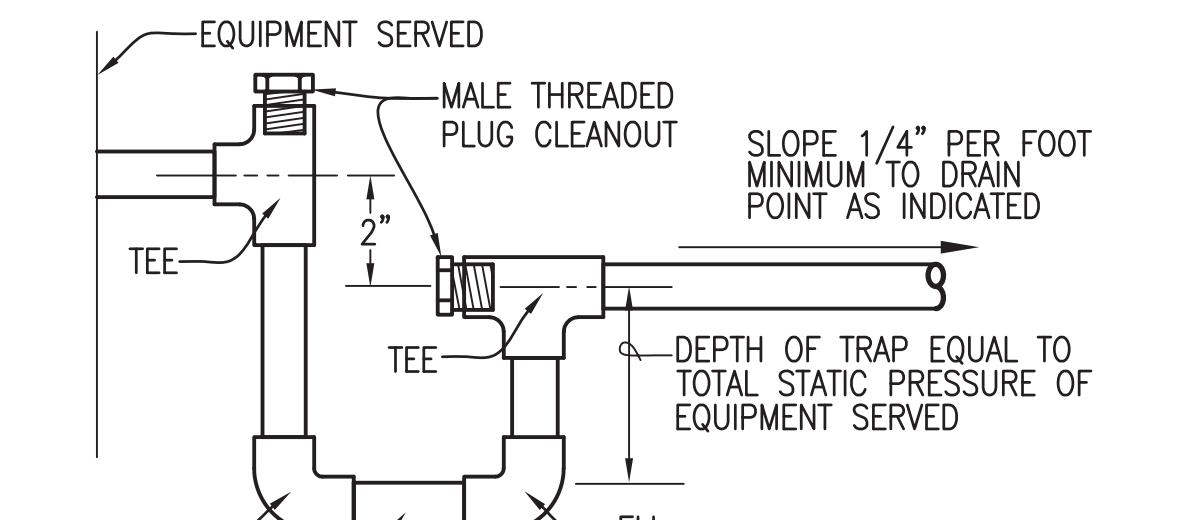


TYPICAL CONDENSATE DRAIN DETAIL  
NOT TO SCALE

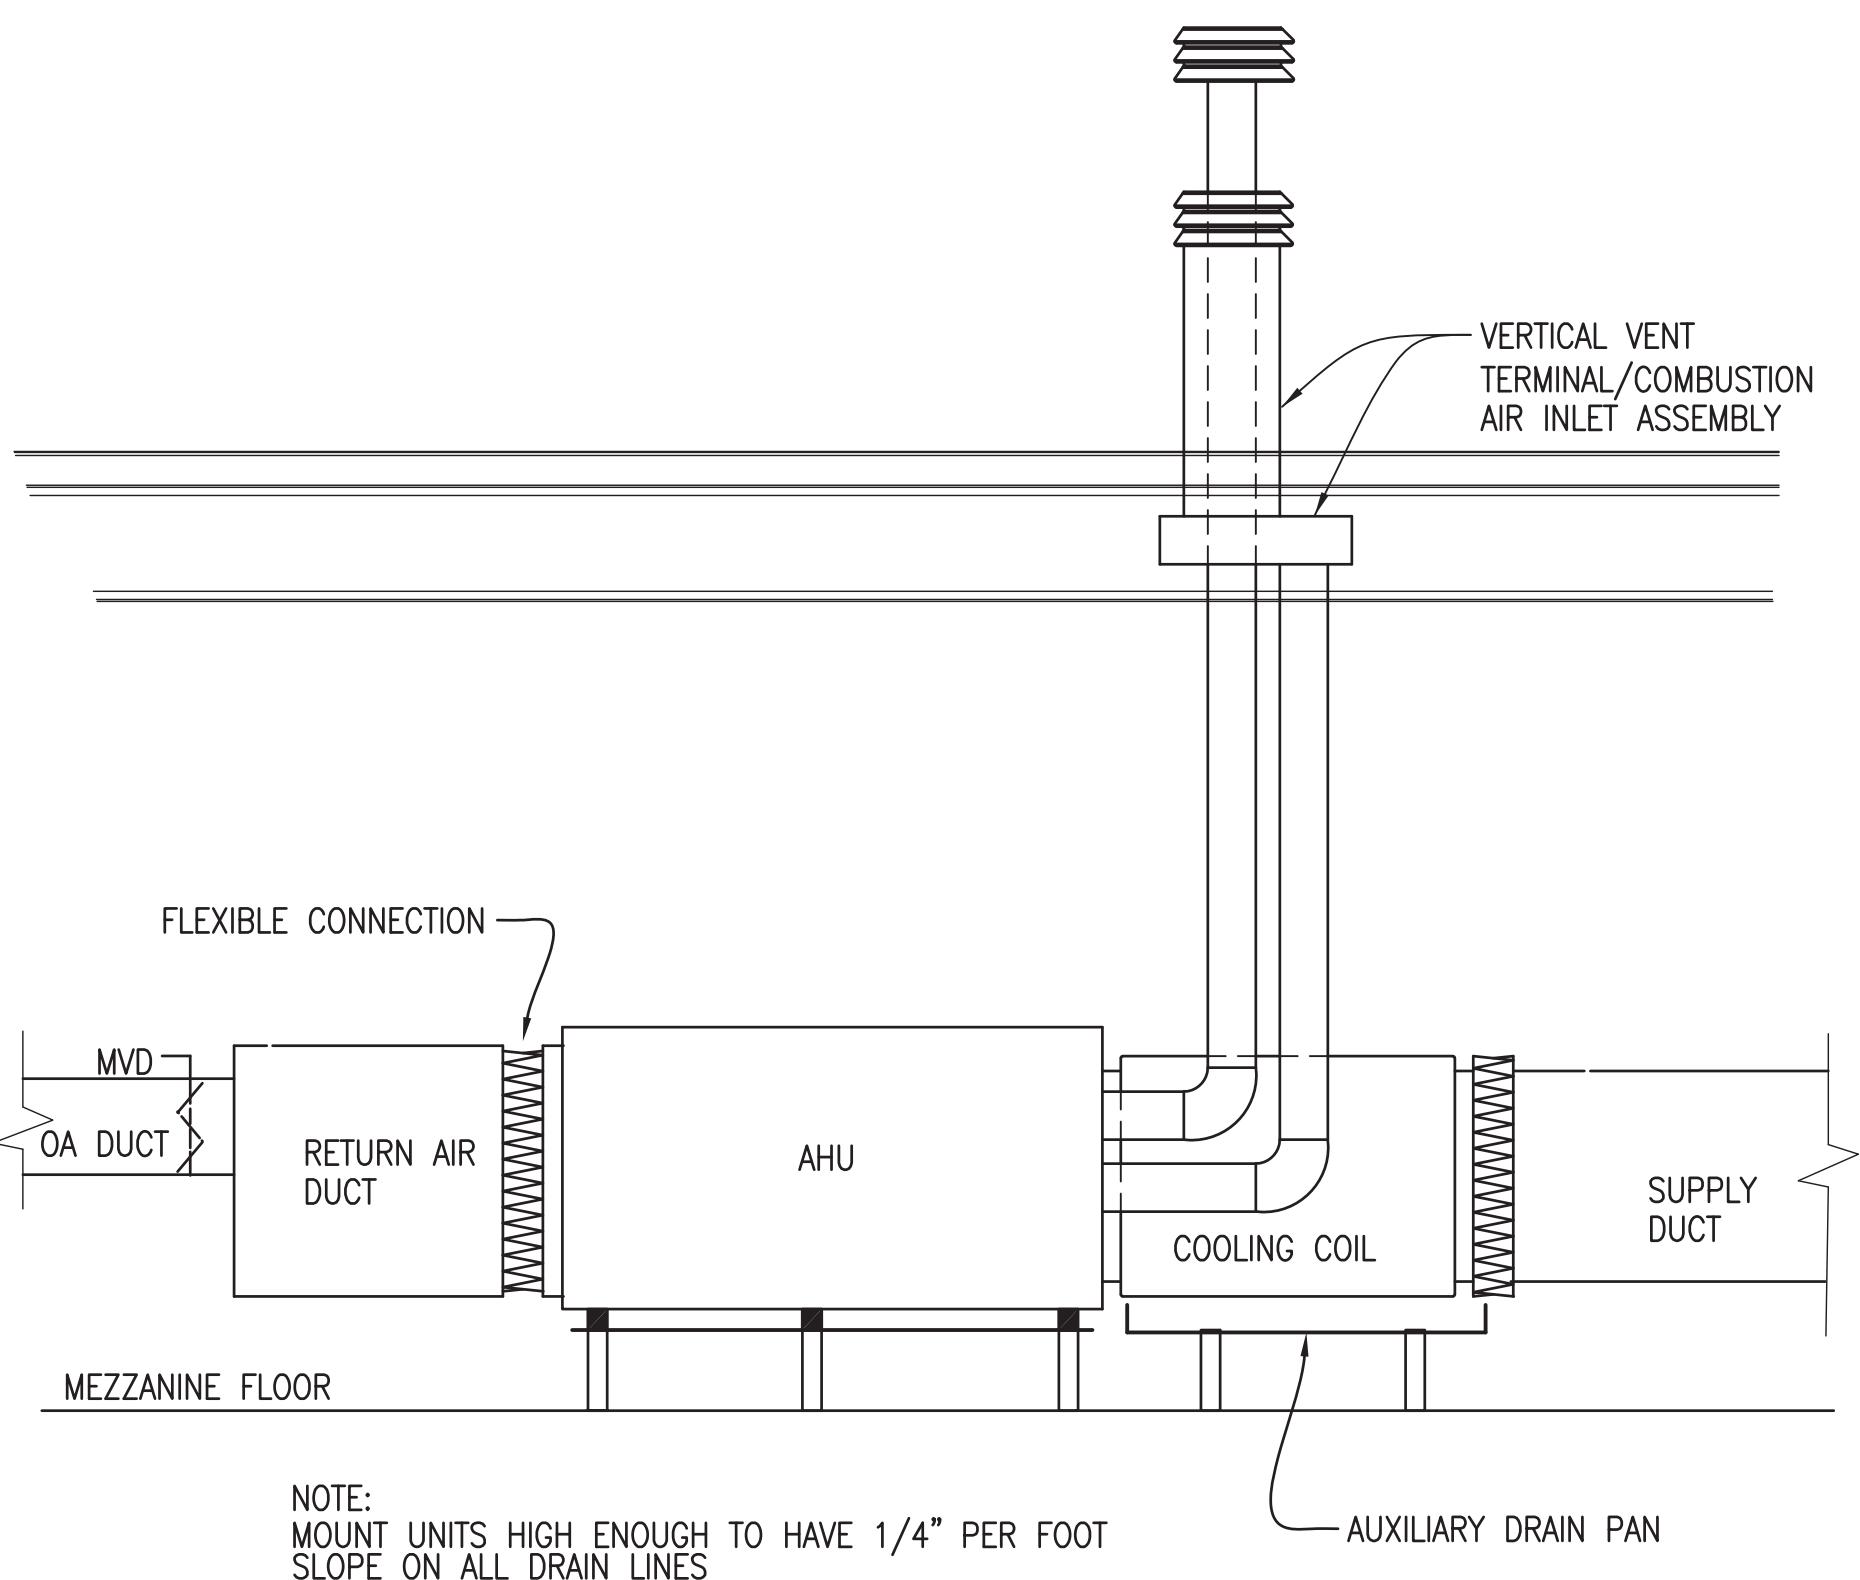

GAS FURNACE MOUNTING DETAIL  
N.T.S.

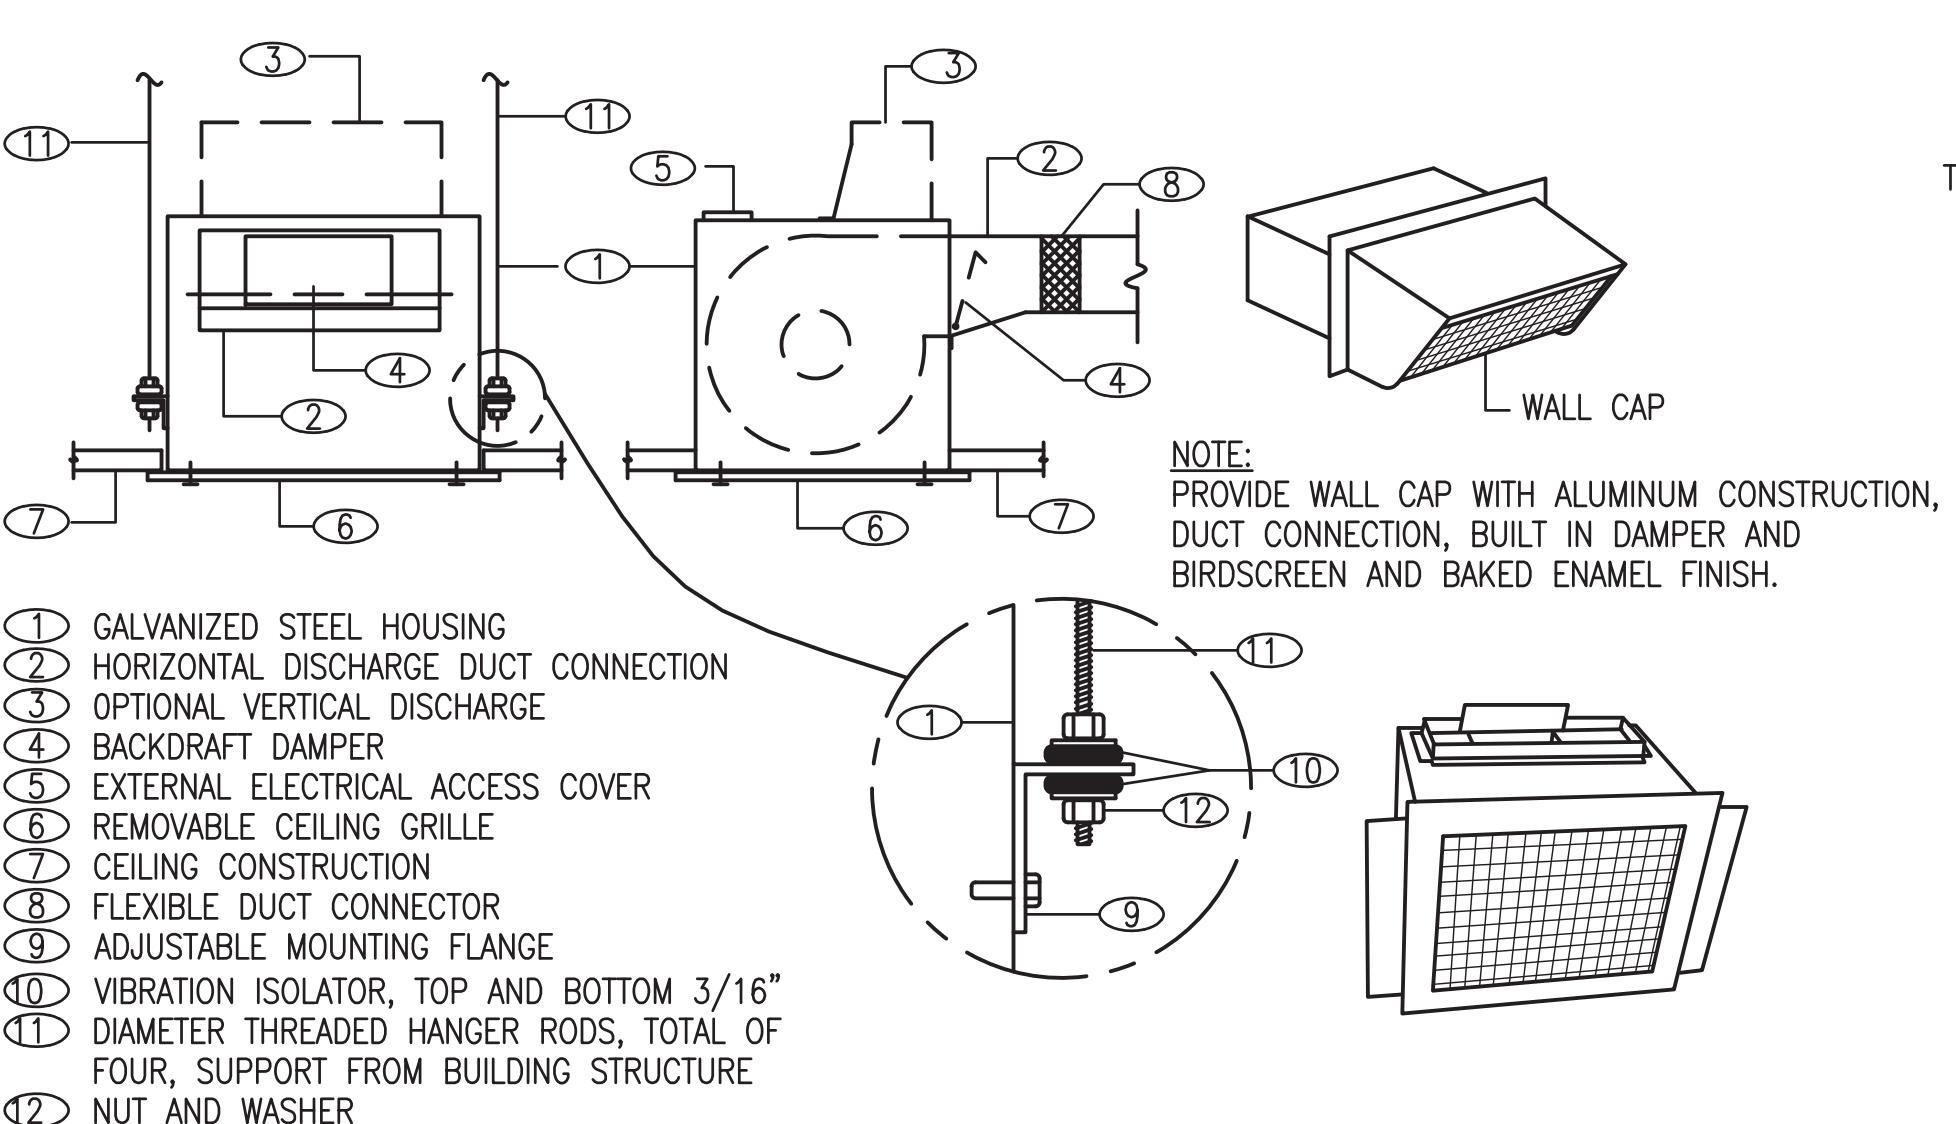


CEILING EXHAUST FAN DETAIL  
NOT TO SCALE

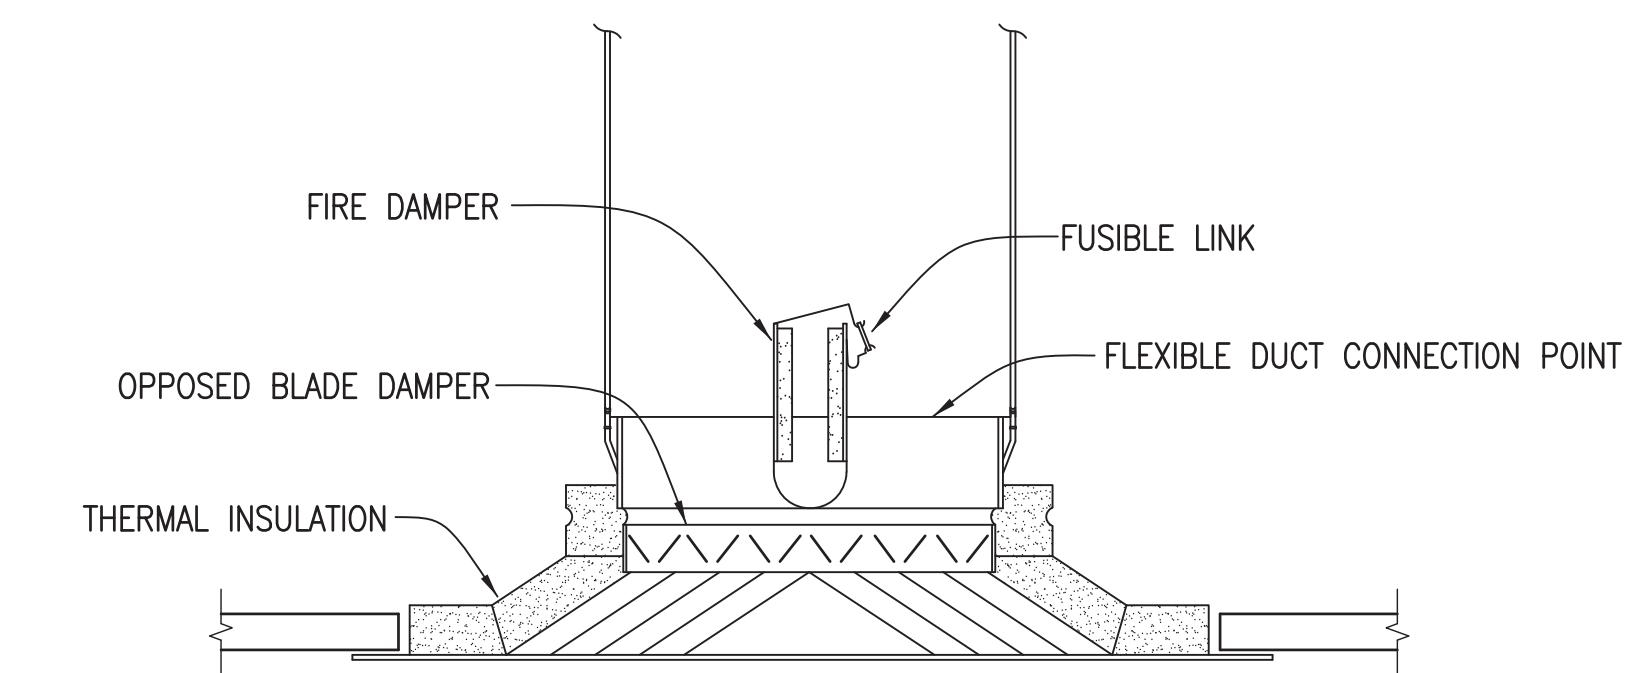


FIRE RATED CEILING DIFFUSER\GRILLE DETAIL  
NOT TO SCALE

## MECHANICAL LEGEND

RECTANGULAR DUCTWORK, SIZES SHOWN ARE INTERNAL CLEAR DIMENSIONS. (WIDTH X HEIGHT) FIRST FIGURE IS SIDE SHOWN.

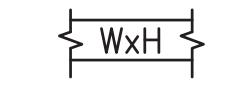

DUCT SECTION, POSITIVE PRESSURE, FIRST FIGURE IS TOP DIMENSION

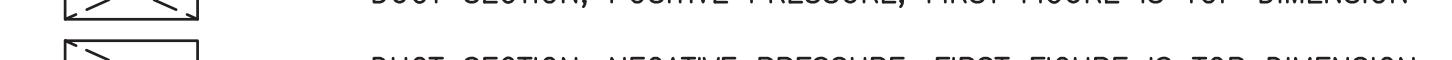

DUCT SECTION, NEGATIVE PRESSURE, FIRST FIGURE IS TOP DIMENSION

ROUND BRANCH DUCT TAKEOFF FROM RECTANGULAR DUCT MAIN. BRANCH DUCT SHALL BE FLEXIBLE ROUND DUCT OR ROUND SNAPLOCK DUCT AS INDICATED. ROUND DUCT TAP IN SHALL BE MADE WITH SPIN-IN COLLAR WITH MANUAL VOLUME DAMPER.

ROUND SNAPLOCK GALVANIZED STEEL DUCTWORK, EXTERNALLY INSULATED, SMACNA STATIC PRESSURE CONSTRUCTION CLASS 1/2" w.g., SEAL CLASS C. SIZE SHOWN IS SHEET METAL DIAMETER.

FACTORY FABRICATED/INSULATED FLEXIBLE ROUND DUCT, SIZE SHOWN IS INSIDE DIAMETER.

SQUARE THROAT ELBOW IN RECTANGULAR DUCT WITH DOUBLE WALL TURNING VENES.

LONG RADIUS ELBOW IN RECTANGULAR DUCT.

THERMOSTAT, MOUNT 48" A.F.F.

HUMIDISTAT, MOUNT 48" A.F.F.

DUCT MOUNTED SMOKE DETECTOR

MANUAL VOLUME DAMPER, PROVIDE WITH LOCKING QUADRANT

CEILING DIFFUSER WITH 24"x24" FACE SIZE DESIGNED FOR LAY-IN INSTALLATION IN 24"x24" T-BAR CEILING GRID. ROUND NECK SIZE AND AIRFLOW AS INDICATED. 360° DIRECTION OF THROW. PROVIDE WITH OPPOSED BLADE VOLUME CONTROL DAMPER. BACK FACE OF DIFFUSER SHALL HAVE INSULATION BLANKET.

RETURN AIR GRILLE, NECK SIZE AS INDICATED.

IN-LINE CENTRIFUGAL FAN WITH BACK DRAFT DAMPER.

CENTRIFUGAL FAN WITH INTEGRAL GRILLE AND BACK DRAFT DAMPER.

## FAN SCHEDULE

MARK	LOCATION	TYPE	DRIVE	PERFORMANCE DATA			ELECTRICAL			CONTROL	NOTES	
				AIR FLOW CFM	E.S.P. IN H ₂ O	MAX. RPM	MAX. SONES	MAX. HP/WATTS	Volts	Phase	Hz	
EF-1,2	RESTROOM	CF	DD	70	0.375	635	1.0	135 W	115	1	60	MOTION SENSOR WITH TIME DELAY 1,2,4,5
EF-3	BREAK ROOM	ILC	DD	150	0.375	825	1.6	125 W	115	1	60	HOOD SWITCH 1,2,3
EF-4	APPARATUS	ILC	BD	3500	0.375	395	8.4	0.75 HP	208	1	60	WALL SWITCH 1,2
EF-5	APPARATUS	ILC	BD	3500	0.375	395	8.4	0.75 HP	208	1	60	THERMOSTAT 1,2

## FAN SCHEDULE LEGEND

BD - BELT DRIVE  
CF - CABINET FAN  
DD - DIRECT DRIVE  
EF - EXHAUST FAN  
ESP - EXTERNAL STATIC PRESSURE  
ILC - INLINE CENTRIFUGAL FAN

## FAN NOTES

- ALL EXHAUST FANS SHALL BE INSTALLED WITH FLEXIBLE DUCT CONNECTION, VIBRATION ISOLATORS AND FLEXIBLE CONDUIT. FAN SHALL NOT BE IN CONTACT WITH ANY OTHER DUCT, PIPING, CONDUIT OR STRUCTURAL MEMBERS.
- THE FANS SHALL BE PROVIDED WITH BACKDRAFT DAMPERS.
- THE ROOF MOUNTED FANS SHALL BE PROVIDED WITH PREFABRICATED ROOF CURBS AND BACKDRAFT DAMPER.
- ALL DIRECT DRIVE FANS WITH MOTORS LESS THAN 1/2 HP SHALL BE PROVIDED WITH AN ADJUSTABLE ELECTRONIC SPEED CONTROLLER.
- PROVIDE WALL MOUNTED MOTION SENSOR WITH TIME DELAY.

## INFARED HEATER UNIT SCHEDULE

MARK	ELECTRICAL DATA			HEATING DATA		REMARKS
	VOLTS	PHASE	HERTZ	FUEL	HEATING BTU/H	
RH-1, 2, 3, 4, 5, 6	120	1	60	NAT. GAS	30000	-

## INFARED UNIT HEATER SCHEDULE NOTES:

AUTOMATIC IGNITION/REIGNITION OF A CYCLING PILOT THROUGH A SOILD STATE DIRECT SPARK IGNITION SYSTEM. LOSS OF GAS OR POWER SUPPLY CAUSES 100% SHUT-OFF OF MAIN AND PILOT BURNER. THERMOSTATICALLY CONTROLLED.

## GAS FIRED FURNACE WITH DX COIL

MARK	TYPE	FAN DATA				DIRECT EXPANSION COOLING COIL DATA				GAS FURNACE				FILTER DATA			REMARKS					
		TOTAL AIR CFM	OUTSIDE AIR CFM	E.S.P. INCHES H ₂ O	FAN MOTOR HP	ELECTRICAL DATA			MAX. FACE VEL FPM	TOT. COOLING CAP MBTU/HR	LATENT COOLING CAP MBTU/HR	ENTERING AIR TEMP. °Fdb	LEAVING AIR TEMP. °Fwb	GAS TYPE	INPUT MBTU/HR	% EFFICIENCY	FLUE SIZE INCH	MAX. FACE VEL. FPM	TYPE	THICK		
GF-1	HDZ	1600	200	0.9	0.75	120	1	60	500	48.0	12.0	80.0	67.0	55.0	55.0	NAT. GAS	80.0	80	4"	350	T-AWAY	1"

NOTES:  
HDT - HORIZONTAL DRAW THRU  
MTZ - MULTI-ZONE  
ADJUST LOCATION OF UNITS IN MECHANICAL ROOMS AS REQUIRED  
FOR SERVICE AS RECOMMENDED BY MANUFACTURER.

## CONDENSING UNIT SCHEDULE

MARK	DESIGN COOLING TOTAL MBTU/HR	AMBIENT °F	REF. TYPE	COMPRESSORS		FANS		ELECTRICAL			REMARKS
				NO.	RLA EACH	NO.	FLA EACH	VOLTS	PHASE	Hz	
CU-1	48.0	95	410A	1	21.2	1	1.1	230	1	60	

## HVAC GENERAL NOTES

- INSTALL A COMPLETE AND OPERABLE MECHANICAL SYSTEM AS INDICATED ON THE DRAWINGS, AS SPECIFIED AND AS REQUIRED BY CODE.
- CONTRACT DOCUMENT DRAWINGS FOR MECHANICAL WORK ARE DIAGRAMMATIC AND ARE INTENDED TO CONVEY SCOPE AND GENERAL ARRANGEMENT ONLY.
- INSTALL ALL MECHANICAL EQUIPMENT IN ACCORDANCE WITH MANUFACTURERS' RECOMMENDATIONS, CONTRACT DOCUMENTS AND APPLICABLE CODES AND REGULATIONS.
- COORDINATE EQUIPMENT CLEARANCES (AS RECOMMENDED BY MANUFACTURER) WITH ALL DISCIPLINES BEFORE INSTALLATION.
- COORDINATE AND PROVIDE ALL DUCTS AND PIPING TRANSITION REQUIRED FOR FINAL EQUIPMENT CONNECTIONS TO FURNISHED EQUIPMENT, VERIFY AND COORDINATE ALL DUCT AND PIPING DIMENSIONS BEFORE FABRICATION.
- CONCRETE HOUSEKEEPING PADS TO SUIT MECHANICAL EQUIPMENT, MINIMUM CONCRETE PAD THICKNESS SHALL BE 6". PAD SHALL EXTEND BEYOND THE EQUIPMENT A MINIMUM OF 6" ON ALL SIDES.
- PROVIDE ACCESS PANELS FOR INSTALLATION IN WALLS AND CEILINGS, WHERE REQUIRED, TO SERVICE DAMPERS, VALVES, SMOKE DETECTORS AND OTHER CONCEALED MECHANICAL EQUIPMENT.
- PROVIDE ACCESS DOORS IN DUCTWORK TO PROVIDE ACCESS FOR ALL SMOKE DETECTORS, FIRE DAMPERS, SMOKE DAMPERS VOLUME DAMPERS, HUMIDIFIERS, COILS AND OTHER ITEMS LOCATED IN THE DUCTWORK THAT REQUIRE SERVICE AND/OR INSPECTION.
- ALL EQUIPMENT, PIPING, DUCTWORK, ETC., SHALL BE SUPPORTED AS DETAILED, SPECIFIED AND REQUIRED TO PROVIDE A VIBRATION-FREE INSTALLATION.
- LOCATIONS AND SIZES OF ALL FLOOR, WALL AND ROOF OPENINGS SHALL BE COORDINATED WITH ALL OTHER TRADES INVOLVED.
- ALL OPENINGS IN FIRE WALL DUE TO DUCTWORK, PIPING, CONDUIT, ETC., SHALL BE FIRE STOPPED WITH AN APPROVED PRODUCT.
- ALL EQUIPMENT REQUIRING CONDENSATE DRAIN LINES SHALL BE PIPED FULL SIZE OF THE UNIT DRAIN OUTLET, WITH "P" TRAP AND PIPED TO THE NEAREST DRAIN AS INDICATED.
- REFER TO TYPICAL DETAILS FOR DUCTWORK, PIPING AND EQUIPMENT INSTALLATION.
- THERMOSTATS INDICATED ADJACENT TO DOORWAYS SHALL BE LOCATED WITHIN 18" OF JAMB AT LOCATIONS WITH LIGHT SWITCHES AND MOUNT THERMOSTAT 48" A.F.F. LOCATE THERMOSTAT SUCH THAT LIGHT SWITCH IS BETWEEN THERMOSTAT AND JAMB. VERIFY THERMOSTAT LOCATION WITH SYSTEM FURNITURE LAYOUT PRIOR TO INSTALLING THERMOSTATS.
- ALL DUCTWORK DIMENSIONS, AS SHOWN ON THE DRAWINGS, ARE INTERNAL CLEAR DIMENSIONS AND DUCT SIZE SHALL BE INCREASED TO COMPENSATE FOR DUCT LINING THICKNESS.
- PROVIDE ALL 90-DEGREE SQUARE ELBOWS WITH DOUBLE RADIUS TURNING VENES. PROVIDE ACCESS DOORS UPSTREAM OF ALL ELBOWS WITH TURNING VENES.
- COORDINATE DIFFUSER, REGISTER AND GRILLE LOCATIONS WITH ARCHITECTURAL REFLECTED CEILING PLANS, LIGHTING AND OTHER CEILING MOUNTED EQUIPMENT AND MAKE DUCT MODIFICATION TO SUIT.
- EXTERIOR LOUVERS ARE INDICATED FOR INFORMATION ONLY. LOUVER DIMENSIONS INDICATED DOES NOT INCLUDE FRAME OR FLANGES. APPROXIMATE ROUGH OPENING IN WALL ASSEMBLY IS INDICATED ON ARCHITECTURAL.
- AVOID ROUTING DUCTWORK AND MECHANICAL EQUIPMENT OVER LIGHTS WHEREVER POSSIBLE. MAINTAIN MINIMUM 6" CLEARANCE BETWEEN MECHANICAL EQUIPMENT AND DUCT INSULATION TO TOP OF LIGHTS. PROVIDE CLEARANCE AND ACCESS ALL AROUND AND BELOW MECHANICAL EQUIPMENT AS REQUIRED FOR ROUTINE MAINTENANCE.
- SEAL ALL DUCT PENETRATIONS OF WALLS AIRTIGHT, REGARDLESS OF WHETHER WALLS ARE FIRE RATED OR NOT.
- ALL AIR INTAKES OPENING TO EXTERIOR SHALL HAVE A MIN 10'-0" CLEARANCE FROM ANY EXHAUST OPENING TO PREVENT RECIRCULATION.
- MOUNT DUCTWORK AS HIGH AS POSSIBLE WHERE EXPOSED, UNLESS OTHERWISE NOTED.
- ALL ROUND FLEXIBLE DUCT SHALL BE FACTORY PREINSULATED THERMOFLEX OR EQUAL. MAXIMUM LENGTH OF ANY FLEXIBLE DUCT RUNOUT SHALL BE 8'-0". WHERE LENGTH REQUIRED EXCEEDS 8'-0", INSTALL EXTERNALLY INSULATED ROUND SNAPLOCK DUCT FOR BALANCE OF DISTANCE TO SPIN-IN TAP AT MAIN DUCT TRUNK.
- ALL SUPPLY AIR DUCTWORK SHALL BE LOW PRESSURE RECTANGULAR, SMACNA STATIC PRESSURE CLASS 2" W.G., SEAL CLASS A, EXTERNALLY INSULATED WITH 2" R-6 INSULATION.
- ALL RETURN AIR DUCTWORK SHALL BE LOW PRESSURE RECTANGULAR, SMACNA STATIC PRESSURE CLASS 1" W.G., SEAL CLASS A, EXTERNALLY INSULATED 2" R-6 INSULATION.
- ALL OUTSIDE AIR DUCTWORK SHALL BE LOW PRESSURE RECTANGULAR, SMACNA STATIC PRESSURE CLASS 1" W.G., SEAL CLASS A, EXTERNALLY INSULATED 2" R-6 INSULATION.
- EXHAUST AIR DUCTWORK SHALL BE LOW PRESSURE RECTANGULAR, SMACNA STATIC PRESSURE CLASS 1/2" W.G., SEAL CLASS A, EXTERNALLY INSULATED 2" R-6 INSULATION.



A NEW FIRE STATION  
FOR THE  
CITY OF ASHFORD  
ASHFORD, ALABAMA

OWNER:  
CITY OF ASHFORD  
525 N BROADWAY STREET  
ASHFORD, ALABAMA 36312

ISSUE: APRIL 20, 2022  
MARK DATE DESCRIPTION

PROJECT NO: 21-20  
DRAWN BY: Quinn Yates  
CHECKED BY: Quinn Yates  
SHEET TITLE

ELECTRICAL  
LEGEND, NOTES &  
DETAILS

E0.1  
SHEET OF




### TYPICAL ARC FLASH HAZARD LABEL DETAIL

NOT TO SCALE

## ARC FLASH LABEL DETAIL NOTES:

1. PROVIDE SELF-ADHESIVE VINYL LABEL TO AFFIX TO ALL PANEL AND SWITCHBOARDS IN ACCORDANCE WITH NEC 110.16 AND NFPA 70E.
2. LABELING MAY BE COMPLETED BY EQUIPMENT MANUFACTURER, VENDOR, OR CONTRACTOR. THE CONTRACTOR SHALL VERIFY ALL PANELS AND SWITCHBOARDS ARE LABELED IN THE FIELD.
3. THE LABEL SHALL BE LOCATED ON THE EQUIPMENT TO BE CLEARLY VISIBLE TO QUALIFIED PERSONS BEFORE EXAMINATION, ADJUSTMENT, SERVICING, OR MAINTENANCE OF THE EQUIPMENT.

-1/2" LETTERS

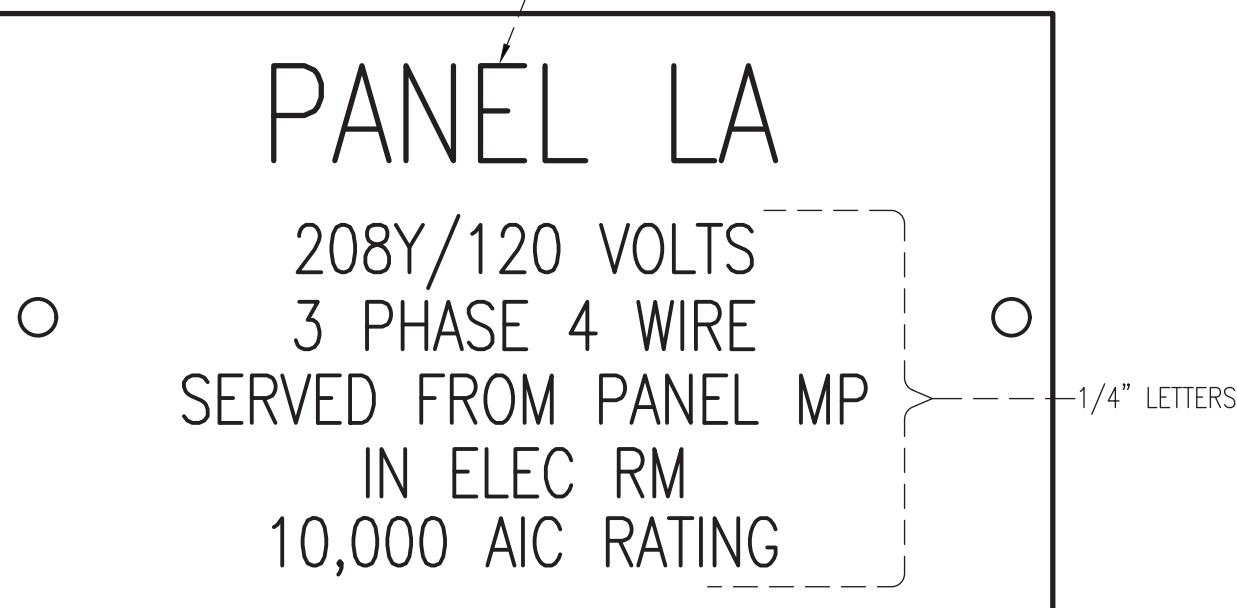

### TYPICAL ELECTRICAL EQUIPMENT IDENTIFICATION DETAIL

NOT TO SCALE

## ELECTRICAL EQUIPMENT IDENTIFICATION DETAIL NOTES:

1. MECHANICALLY AFFIX NAMEPLATE TO PANELBOARDS, CONTROL PANELS, MOTOR CONTROL CENTERS, DISCONNECTS, STARTERS OR SIMILAR DEVICES.
2. LETTERS SHALL BE WHITE ON BLACK BACKGROUND; SIZE OF LETTERS INDICATED ON DETAIL.
3. INFORMATION IN LABEL IS A GENERIC EXAMPLE - DESIGNATE EQUIPMENT IN A SIMILAR WAY USING RELEVANT INFORMATION (NAME OF PANEL, VOLTS, PHASE, LOCATION, AIC RATING ETC.) ACCORDING TO EACH INDIVIDUAL LOCATION OF EQUIPMENT.

MANUFACTURERS CONSIDERED EQUAL MUST SUBMIT TO ENGINEER 10 DAYS PRIOR TO BID FOR APPROVAL.

## LIGHTING FIXTURE SCHEDULE

MARK	MANUFACTURER AND CATALOG No. (or approved equal)	LAMPS No.   TYPE	MOUNTING	REMARKS
HB	H.E. WILLIAMS GH-4-L240-840-FA-(L200)-DIM-UN	17W LED ARRAY 24000 LUMENS/40000K	PENDANT 15'-0" AFF	4 FT LED COMPACT MODULAR HIGH BAY, 120V
HBE	H.E. WILLIAMS GH-4-L120-840-HA-FP-DIM-UNV-EM/12W	17W LED ARRAY 24000 LUMENS/40000K	PENDANT 15'-0" AFF	4 FT LED COMPACT MODULAR HIGH BAY, 120V, EMERGENCY UNIT BATTERY PACK
LT	H.E. WILLIAMS LT-24-L40-835-AF-DIM-UNV	32W LED ARRAY 4000 LUMENS/35000K	CEILING RECESSED	2X4 RECESSED LED TROFFER, 120V
LTE	H.E. WILLIAMS LT-24-L40-835-AF-DIM-UNV-EM/10W	32W LED ARRAY 4000 LUMENS/35000K	CEILING RECESSED	2X4 RECESSED LED TROFFER, 120V, EMERGENCY UNIT BATTERY PACK
LTA	H.E. WILLIAMS LT-24-L52-835-AF-DIM-UNV	37W LED ARRAY 5200 LUMENS/35000K	CEILING RECESSED	2X4 RECESSED LED TROFFER, 120V
LTAE	H.E. WILLIAMS LT-24-L52-835-AF-DIM-UNV-EM/10W	37W LED ARRAY 5200 LUMENS/35000K	CEILING RECESSED	2X4 RECESSED LED TROFFER, 120V, EMERGENCY UNIT BATTERY PACK
LW	H.E. WILLIAMS 17-4-L53-835-AF-DIM-UNV	53W LED ARRAY 5500 LUMENS/35000K	PENDANT @ 8'-0" AFF	4 FT LED WRAP FIXTURE, 120V
SH	H.E. WILLIAMS GDR-TL-15-835-DIM-UNV-OW-OF-CS-WET-CC-N-F1	60W LED ARRAY 15000 LUMENS/35000K	CEILING RECESSED	6" LED SHOWER LIGHT WITH DROP OPAL GLASS LENS, 120V
WB	H.E. WILLIAMS WPH-L30-740-T3-SDCL-DIM-UNV	36W LED ARRAY 3000 LUMEN/4000K	WALL @ 9'-0" AFF	WALL MOUNTED LED AREA LIGHT, 120V
WBE	H.E. WILLIAMS WPH-L30-740-T3-SDCL-DIM-UNV-EM/4W	36W LED ARRAY 3000 LUMEN/4000K	WALL @ 9'-0" AFF UNO	WALL MOUNTED LED AREA LIGHT, 120V, EMERGENCY UNIT BATTERY PACK
WP	H.E. WILLIAMS WPH-L60-740-T3-SDCL-DIM-UNV-PC	94W LED ARRAY 6000 LUMEN/4000K	WALL @ 14'-0" AFF	WALL MOUNTED LED AREA LIGHT, 120V
WPE	H.E. WILLIAMS WPH-L60-740-T3-SDCL-DIM-UNV-PC-EM/4W	94W LED ARRAY 6000 LUMEN/4000K	WALL @ 14'-0" AFF	WALL MOUNTED LED AREA LIGHT, 120V, EMERGENCY UNIT BATTERY PACK
X	WILLIAMS EXIT-R-WHT	LED	WALL ABOVE DOOR	LED EXIT LIGHT WITH THERMOPLASTIC HOUSING; PROVIDE DIRECTIONAL ARROWS AS INDICATED, 120V

## ELECTRICAL LEGEND

"A" RECESSED 2' x 4' FLUORESCENT FIXTURE MARK "A"

CEILING SURFACE MOUNTED 4 FT LONG LIGHT FIXTURE

SURFACE MOUNTED LED HIGH BAY LIGHT FIXTURE

JUNCTION BOX

CEILING RECESSED MOUNTED LIGHTING FIXTURE

CEILING SURFACE MOUNTED EXIT LIGHT; PROVIDE DIRECTION ARROW AS INDICATED EXISTING TO REMAIN

EXHAUST FAN

BRANCH CIRCUITING

RUN CONCEALED UNDER FLOOR

RUN CONCEALED IN CEILING OR WALLS

LA-1 HOMERUN TO PANEL; ANY CIRCUIT WITHOUT FURTHER IDENTIFICATION INDICATES 2 #12, 1 #12 GROUND - 3/4" C; 3 #12, 1 #12 GROUND - 1/2" C; 4 #12, 1 #12 GROUND - 3/4" C; ETC. AS PER NEC. NUMERALS INDICATE PANEL AND CIRCUIT NUMBER.

LIQUID-TIGHT FLEXIBLE CONDUIT CONNECTION

SURFACE MOUNTED CONDUIT; RUN PARALLEL OR PERPENDICULAR TO BUILDING LINES

WALL SWITCHES (UNLESS OTHERWISE NOTED, MOUNT 45° A.F.F.)

S A.C. TYPE, SINGLE POLE, 20 AMP, 120/277 VOLT

S3 A.C. TYPE, 3 WAY, 20 AMP, 120/277 VOLT

S4 A.C. TYPE, 4 WAY, 20 AMP, 120/277 VOLT

SRD WALL MOUNTED OCCUPANCY SENSOR; DUAL TYPE (INFRARED AND ULTRASONIC) TECHNOLOGY; MOUNT 45° AFF TO C/L; EQUAL TO WATTSTOPPER DW-100

WALL OUTLETS

RECESSED JUNCTION BOX WITH BLANK SCREW COVER AND FLEXIBLE CONDUIT CONNECTION

WALL MOUNTED EXIT LIGHT

WALL MOUNTED LIGHT FIXTURE

DUPLEX RECEPTACLE - 20 AMP, 125 VOLT, 2 POLE, 3 WIRE GROUNDED TYPE, NEMA 5-20R. MOUNT 18" A.F.F. UNLESS NOTED OTHERWISE

QUADRUPLEX (DOUBLE) RECEPTACLE - 20 AMP, 125 VOLT, 2 POLE, 3 WIRE GROUNDED TYPE, NEMA 5-20R. MOUNT 18" A.F.F. UNLESS NOTED OTHERWISE

DUPLEX RECEPTACLE - 20 AMP, 125 VOLT, GFI, 2 POLE, 3 WIRE GROUNDED TYPE, NEMA 5-20R. MOUNT 18" A.F.F. UNLESS NOTED OTHERWISE

WP=D DUPLEX RECEPTACLE - 20 AMP, 125 VOLT, GFI, 2 POLE, 3 WIRE GROUNDED TYPE, NEMA GF-5-20R. MOUNT 18" A.F.F. UNLESS NOTED OTHERWISE; PROVIDE WEATHERPROOF BOX FOR RECEPTACLE

DUPLEX RECEPTACLE - 20 AMP, 125 VOLT, 2 POLE, 3 WIRE GROUNDED TYPE, NEMA 5-20R. MOUNT 6" ABOVE COUNTER

DUPLEX RECEPTACLE - 20 AMP, 125 VOLT, GFI, 2 POLE, 3 WIRE GROUNDED TYPE, NEMA GF-5-20R. MOUNT 6" ABOVE COUNTER

DUPLEX RECEPTACLE - 20 AMP, 125 VOLT, GFI, 2 POLE, 3 WIRE GROUNDED TYPE, NEMA 5-20R. MOUNT 26" AFF TO C/L FOR DRINKING FOUNTAIN

250V RECEPTACLE FOR OWNER FURNISHED AUTOCLAVE EQUIPMENT - VERIFY OUTLET TYPE, POLES, ETC. AND LOCATION WITH OWNER'S KITCHEN EQUIPMENT PRIOR TO ROUGH-IN.

250V RECEPTACLE; 4 WIRE; MT 14" AFF TO C/L; NEMA 10-30R; HUBBELL SERIES 9350

COMMUNICATIONS SYSTEM

COMMUNICATIONS OUTLET AT 18" AFF; STUB 1" CONDUIT WITH PULL STRING TO ABOVE ACCESSIBLE CEILING

TELECOMMUNICATIONS OUTLET AT 6" ABOVE COUNTER; STUB 1" CONDUIT WITH PULL STRING TO ABOVE ACCESSIBLE CEILING

OCCUPANCY SENSORS AND RELAYS

360° CEILING MOUNTED OCCUPANCY SENSOR WITH DUAL TECHNOLOGY (INFRARED AND ULTRASONIC) WATTSTOPPER DT-300-1

POWER PACK RELAY EQUAL TO WATTSTOPPER BZ150; INSTALL IN ACCESSIBLE LOCATION FOR PANELS AND POWER

120/208 VOLT SURFACE MOUNTED PANELBOARD

NON-FUSIBLE DISCONNECT SWITCH; XX/YY/ZZ WHERE X INDICATES AMPERAGE, Y INDICATES # OF POLES, AND Z INDICATES NEMA RATING

MISCELLANEOUS

A.F.F. ABOVE FINISH FLOOR

WP WEATHERPROOF

U.N.O. UNLESS NOTED OTHERWISE


GARAGE DOOR OPENER PUSHBUTTON

CARBON MONOXIDE SYSTEM DETECTOR; VERIFY LOCATION WITH HVAC CONTRACTOR PRIOR TO ROUGH-IN; CONNECT ALL DETECTORS TOGETHER FOR COMMON ALARM AND CONNECT TO 120V CIRCUIT FOR POWER

ELECTRIC MOTOR; NUMERAL IN CIRCLE INDICATES HORSEPOWER RATING

## TYPICAL LAY-IN FIXTURE DETAIL

NOT TO SCALE

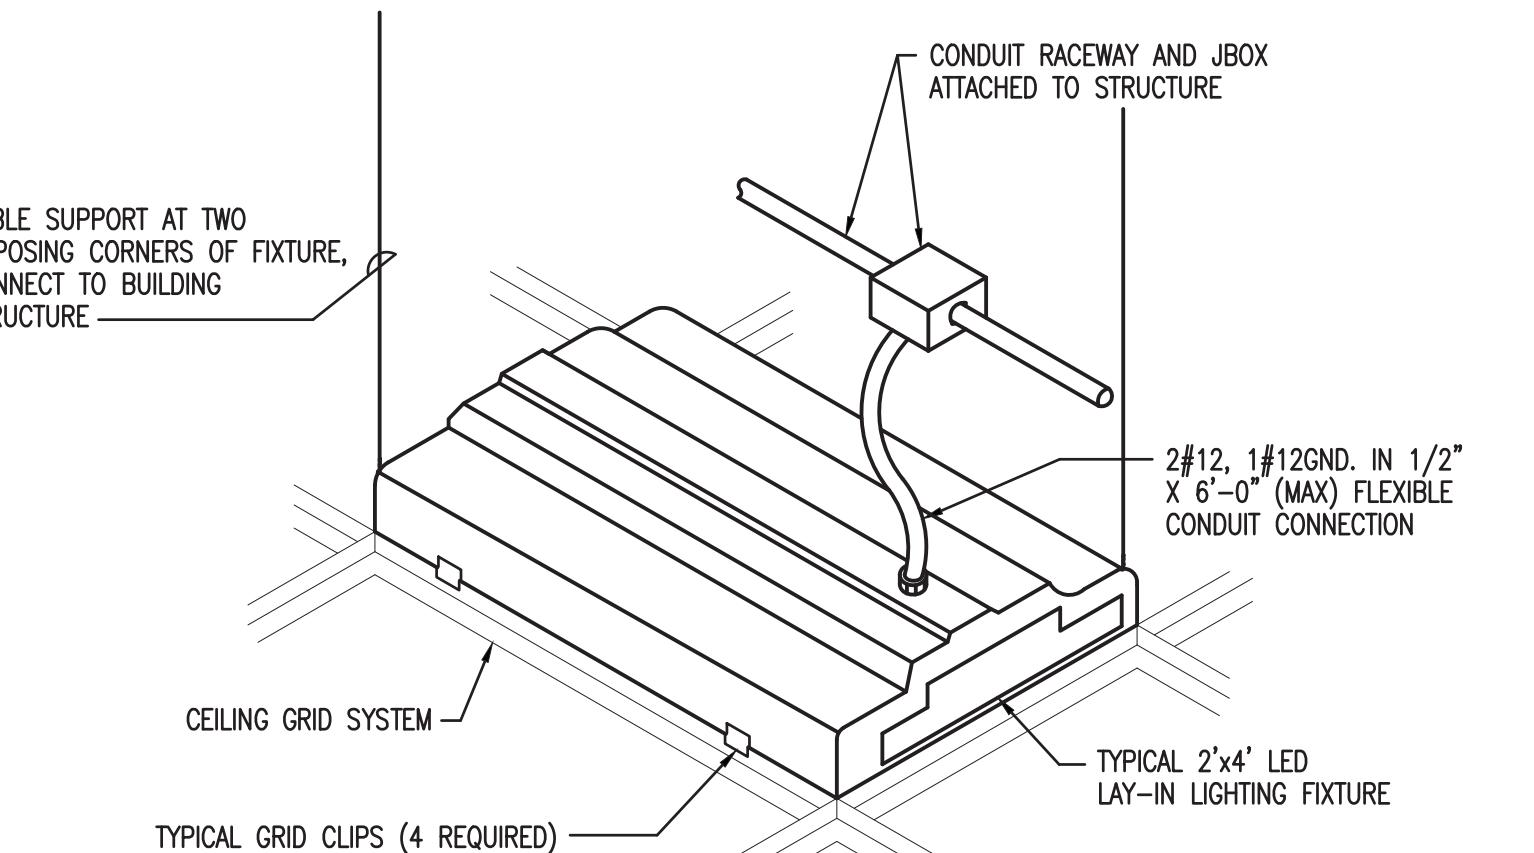

E0.1  
SHEET OF

A NEW FIRE STATION  
FOR THE  
CITY OF ASHFORD  
ASHFORD, ALABAMA

OWNER:


CITY OF ASHFORD  
525 N BROADWAY STREET  
ASHFORD, ALABAMA 36312ISSUE: APRIL 20, 2022  
MARK DATE DESCRIPTIONPROJECT NO: 21-20  
DRAWN BY: Quinn Yates  
CHECKED BY: Quinn Yates  
SHEET TITLEPOWER RISER  
DIAGRAM AND  
SCHEDULES

120/240 VOLT 1Ø 3W CIRCUIT BREAKER PANEL SCHEDULE 400 AMP MAIN BREAKER SURFACE MOUNTED PANEL MP						
CKT	LOAD DESCRIPTION	BREAKER POLE	AMP	LOAD KVA	BREAKER AMP	POLE
1	DRYER	2	30	4.50	1.66	20
3		2	50	11.0	1.66	20
5	RANGE	2	50	11.0	1.66	2
7		2	20	.64	2.5	20①
9	PARKING LOT LIGHTS	2	20	.64	2.5	2
11		2	100	2.0	20①	2
13	SPARE	2	30			
15		2	30			
17	SPARE	2	30			
19		1	---			
21	SPACE	1	---			
23	SPACE	1	---			
25	SPACE	1	---			
27	SPACE	1	---			
29	SPACE	1	---			
31	SPACE	1	---			
33	SPACE	1	---			
35	SPACE	1	---			
37	SPACE	1	---			
39	PANEL L1	2	125	14.40	23.37	200
41		2	2	PANEL EM VIA ATS	40	
						42

120/240 VOLT 1Ø 3W CIRCUIT BREAKER PANEL SCHEDULE 125 AMP M.L.O. FLUSH MOUNTED PANEL LI						
CKT	LOAD DESCRIPTION	BREAKER POLE	AMP	LOAD KVA	BREAKER AMP	POLE
1	REC-STORAGE, CORR	1	20	1.26	.50	20
3	REC-MEN, WOMEN	1	20	.36	.90	20
5	DRINK FOUNTAIN	1	20	1.20	.90	20
7	REC-BREAK RM COUNTER	1	20	.54	.90	20
9	REC-BREAK RM COUNTER	1	20	.54	.72	20
11	REC-DISHWASHER	1	20	.72	.72	20
13	OVERHEAD CORD REEL	1	20	.50	.72	20
15	OVERHEAD CORD REEL	1	20	.50	.90	20
17	OVERHEAD CORD REEL	1	20	.50	.30	20
19	OVERHEAD CORD REEL	1	20	.50	.30	20
21	GAS WATER HEATER	1	20	.20	.72	20
23	SPARE	1	20			
25	SPARE	1	20			
27	SPARE	1	20			
29	SPARE	1	20			
31	SPACE	1	---			
33	SPACE	1	---			
35	SPACE	1	---			
37	SPACE	1	---			
39	SPACE	1	---			
41	SPACE	1	---			

TOTAL CONNECTED LOAD: 14.40 KVA  
MINIMUM INTERRUPTING CAPACITY: 10,000 AMPS SYMMETRICAL

120/240 VOLT 1Ø 3W CIRCUIT BREAKER PANEL SCHEDULE 225 AMP M.L.O. SURFACE MOUNTED PANEL EM						
CKT	LOAD DESCRIPTION	BREAKER POLE	AMP	LOAD KVA	BREAKER AMP	POLE
1	LTS-EQUIP RM, TRAINING, BREAK	1	20	.56	.36	20
3	LTS-OFFICES, RADIO, MEN, WOMEN	1	20	.78	.36	20
5	LTS-APPARATUS BAY	1	20	1.44	.36	20
7	LTS-APPARATUS BAY	1	20	1.44	.36	20
9	LTS-EXTERIOR WALL	1	20	.84	.36	20
11	REFRIGERATOR	1	20	.72	.36	20
13	GARAGE DOOR OPENER (1/2HP)	2	20	1.02	.36	20
15		2	20		.72	20
17	GARAGE DOOR OPENER (1/2HP)	2	20	1.02	.72	20
19		2	20		1.66	25
21	GARAGE DOOR OPENER (1/2HP)	2	20	1.02	5.35	40①
23		2	20		2	CU-1
25	GARAGE DOOR OPENER (1/2HP)	2	20	1.02	.50	20
27		2	20			
29	GARAGE DOOR OPENER (1/2HP)	2	20	1.02		
31		2	20			
33	GARAGE DOOR OPENER (1/2HP)	2	20	1.02		
35		2	20			
37	SPACE	1	---			
39	SPACE	1	---			
41	SPACE	1	---			

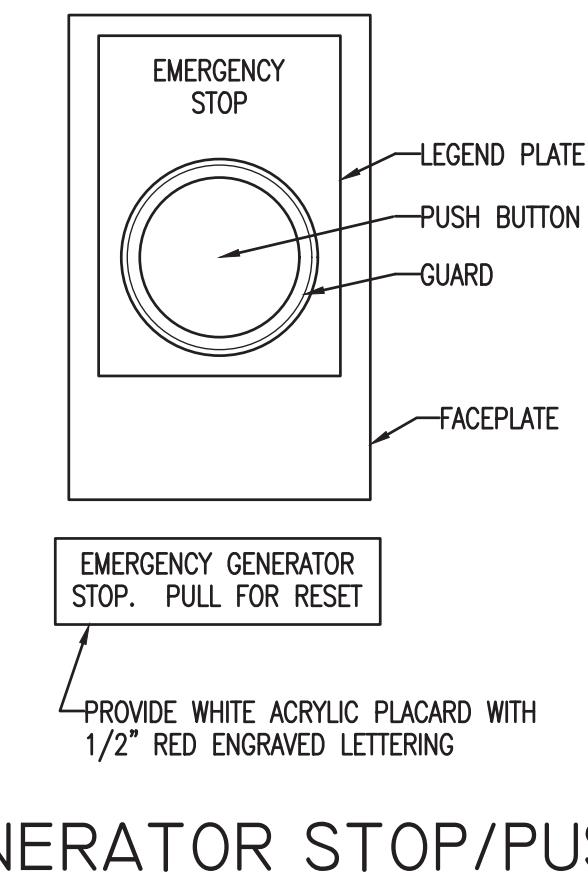TOTAL CONNECTED LOAD: 23.37 KVA  
MINIMUM INTERRUPTING CAPACITY: 10,000 AMPS SYMMETRICAL  
① HACR RATED BREAKER; VERIFY SIZE REQUIRED  
FOR EQUIPMENT FURNISHEDGENERATOR STOP/PUSH  
BUTTON DETAIL  
NOT TO SCALE

① PROVIDE INTEGRAL SURGE SUPPRESSOR DEVICE IN PANEL WITH 80KA PER PHASE, SINE WAVE TRACKING TYPE, INDICATING LIGHTS, ALARM SURGE COUNTER AND DISCONNECT SWITCH. VERIFY VOLTAGE AND PHASE FOR EACH PANEL.

② SEE TYPICAL GROUND BUS BAR DETAIL.

③ INSTALL GENERATOR AND TRANSFER SWITCH ACCORDING TO MANUFACTURER'S RECOMMENDATIONS. GENERATOR SHALL MEET UL 2200 STANDARDS. PROVIDE SHUNT TRIP BREAKER FOR EMERGENCY SHUT DOWN.


④ STUB OUT THREE (3) 3" EMPTY CONDUITS WITH PULL STRING TO 5 FEET BEYOND BUILDING LINE; CAP AND MARK LOCATIONS.

⑤ VERIFY LOCATIONS OF GENERATOR ANNUNCIATOR PANEL AND STOP SWITCH WITH OWNER PRIOR TO ROUGH-IN.


⑥ PROVIDE MUSHROOM HEAD TYPE EMERGENCY GENERATOR STOP SWITCH. 2 POSITION, MAINTAINED CONTACT, NON-ILLUMINATED MUSHROOM PUSH/PULL BUTTON WITH "EMERGENCY STOP" LEGEND PLATE AND PROTECTIVE GUARD. SEE PUSH BUTTON DETAIL.

⑦ HOMERUN 2#12,1#12 GND IN 3/4" TO SHUNT TRIP BREAKER IN GENERATOR

⑧ HOMERUN GENERATORS MANUFACTURER'S APPROVED CONTROL CABLE IN 1 1/4"

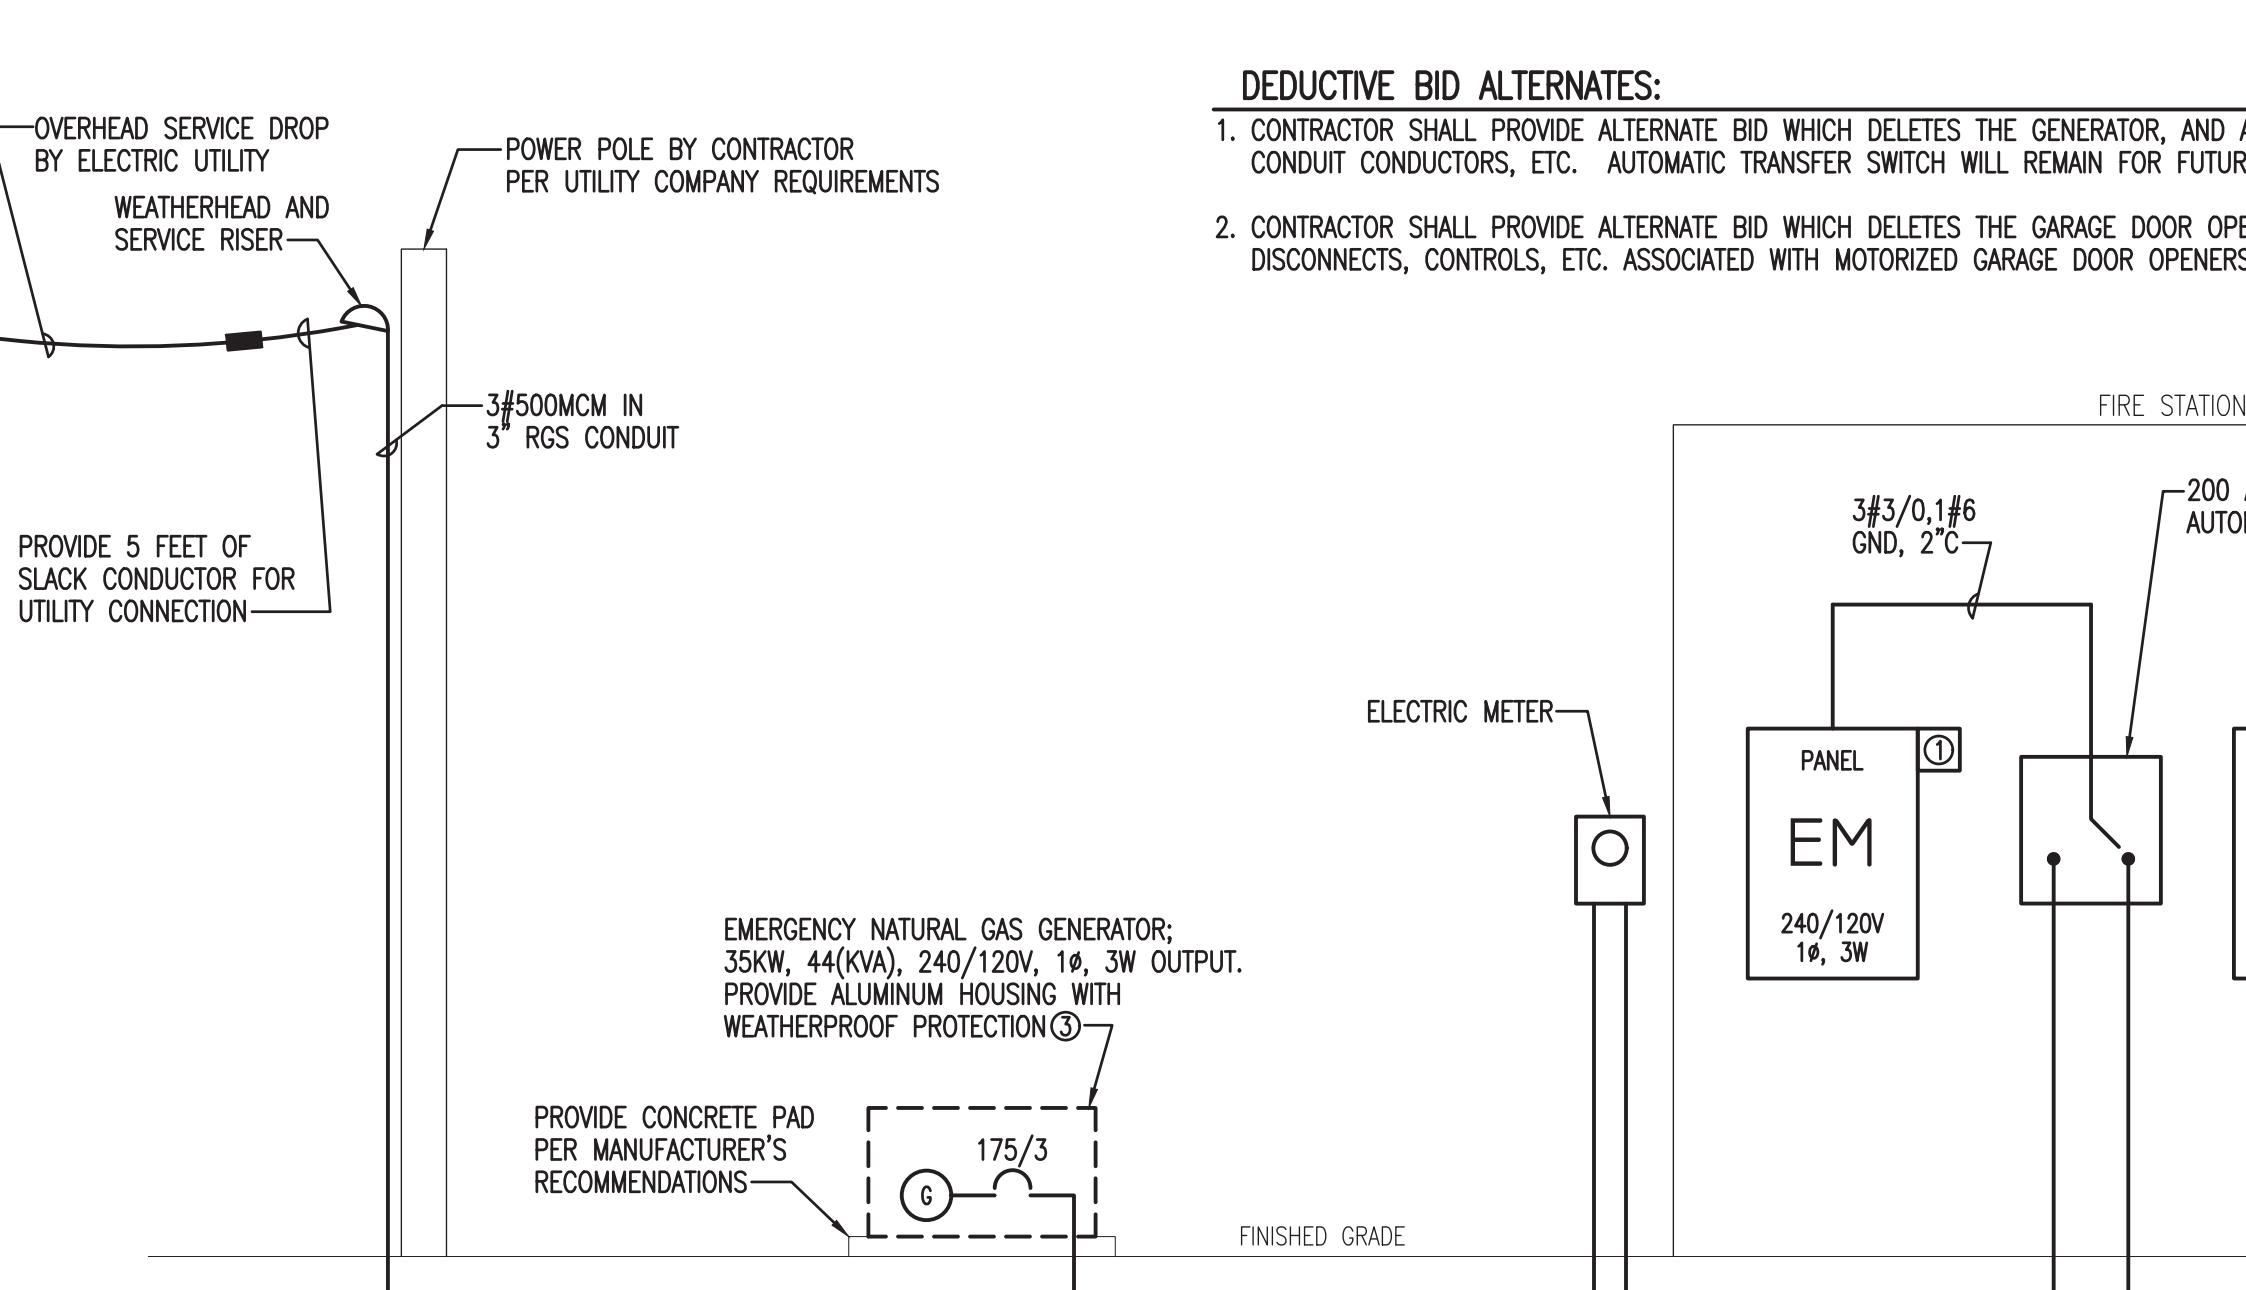POWER RISER DIAGRAM  
NOT TO SCALE

POWER RISER DIAGRAM GENERAL NOTES:  
- COORDINATE UTILITY LOCATIONS WITH UTILITY COMPANY PRIOR TO SUBMITTING BID.  
CONTRACTOR SHALL PAY FOR ALL ASSESSMENTS, SERVICE CHARGES, FEES, ETC.  
FROM THE UTILITY COMPANY FOR SERVICE REQUIREMENTS.

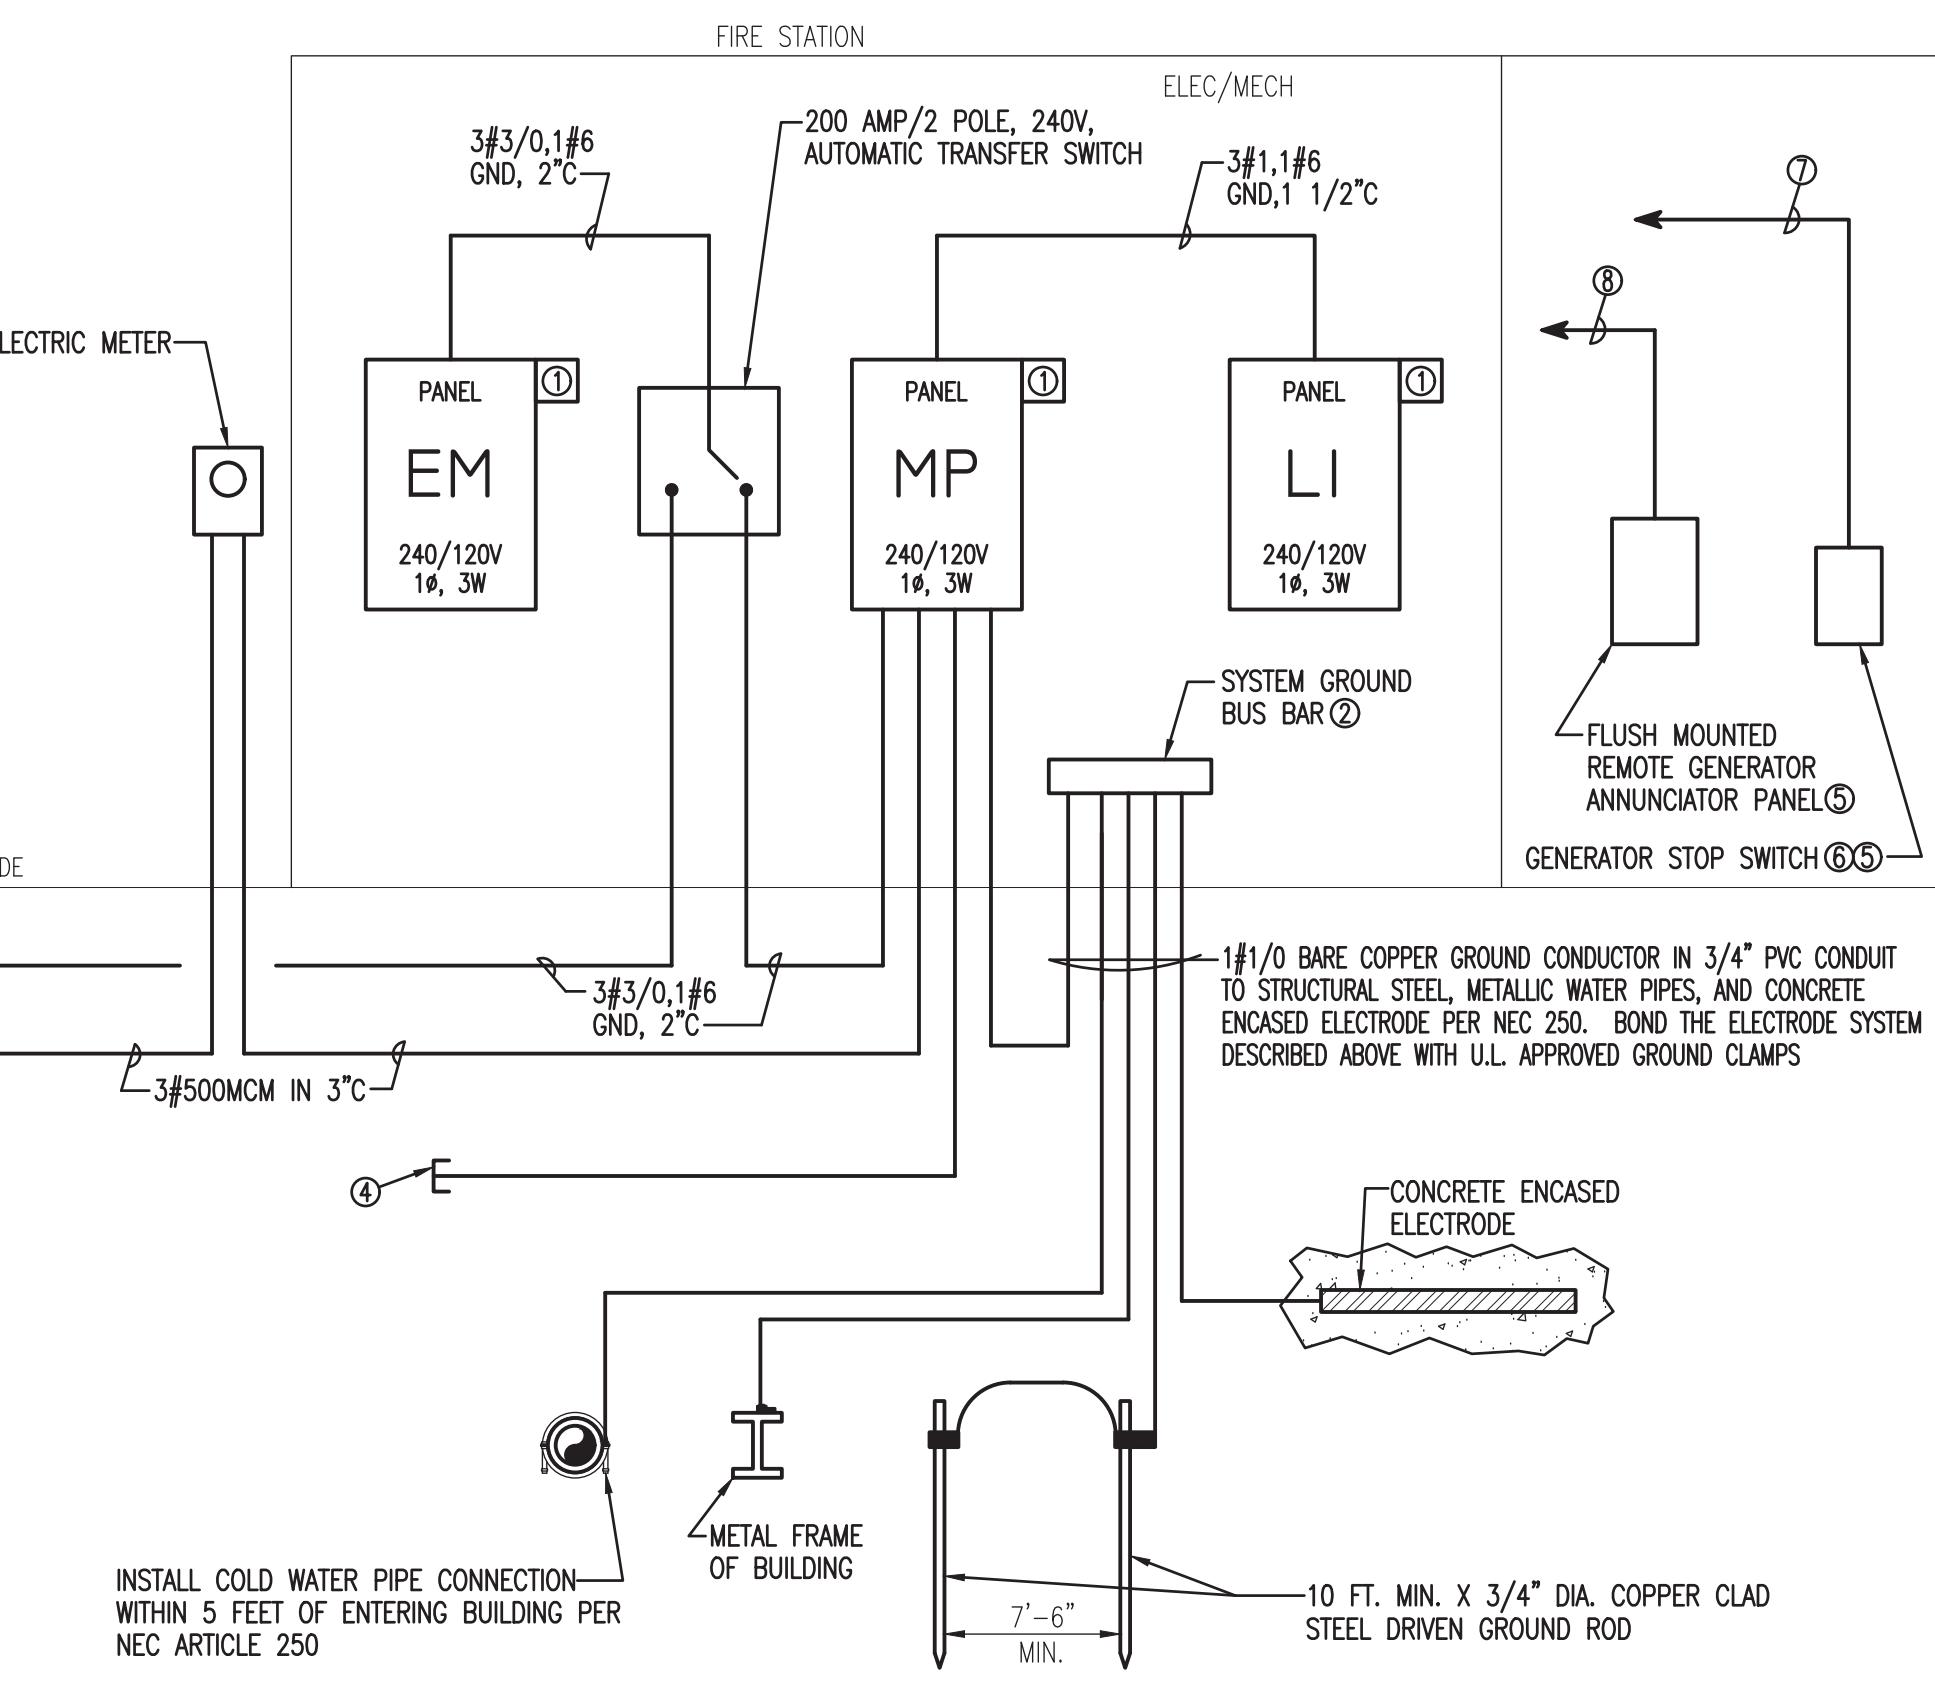



A NEW FIRE STATION  
FOR THE  
CITY OF ASHFORD  
ASHFORD, ALABAMA

OWNER:


CITY OF ASHFORD  
525 N BROADWAY STREET  
ASHFORD, ALABAMA 36312

ISSUE: APRIL 20, 2022  
MARK DATE DESCRIPTION

PROJECT NO: 21-20  
DRAWN BY: Quinn Yates  
CHECKED BY: Quinn Yates

SHEET TITLE

POWER & SIGNAL  
PLAN

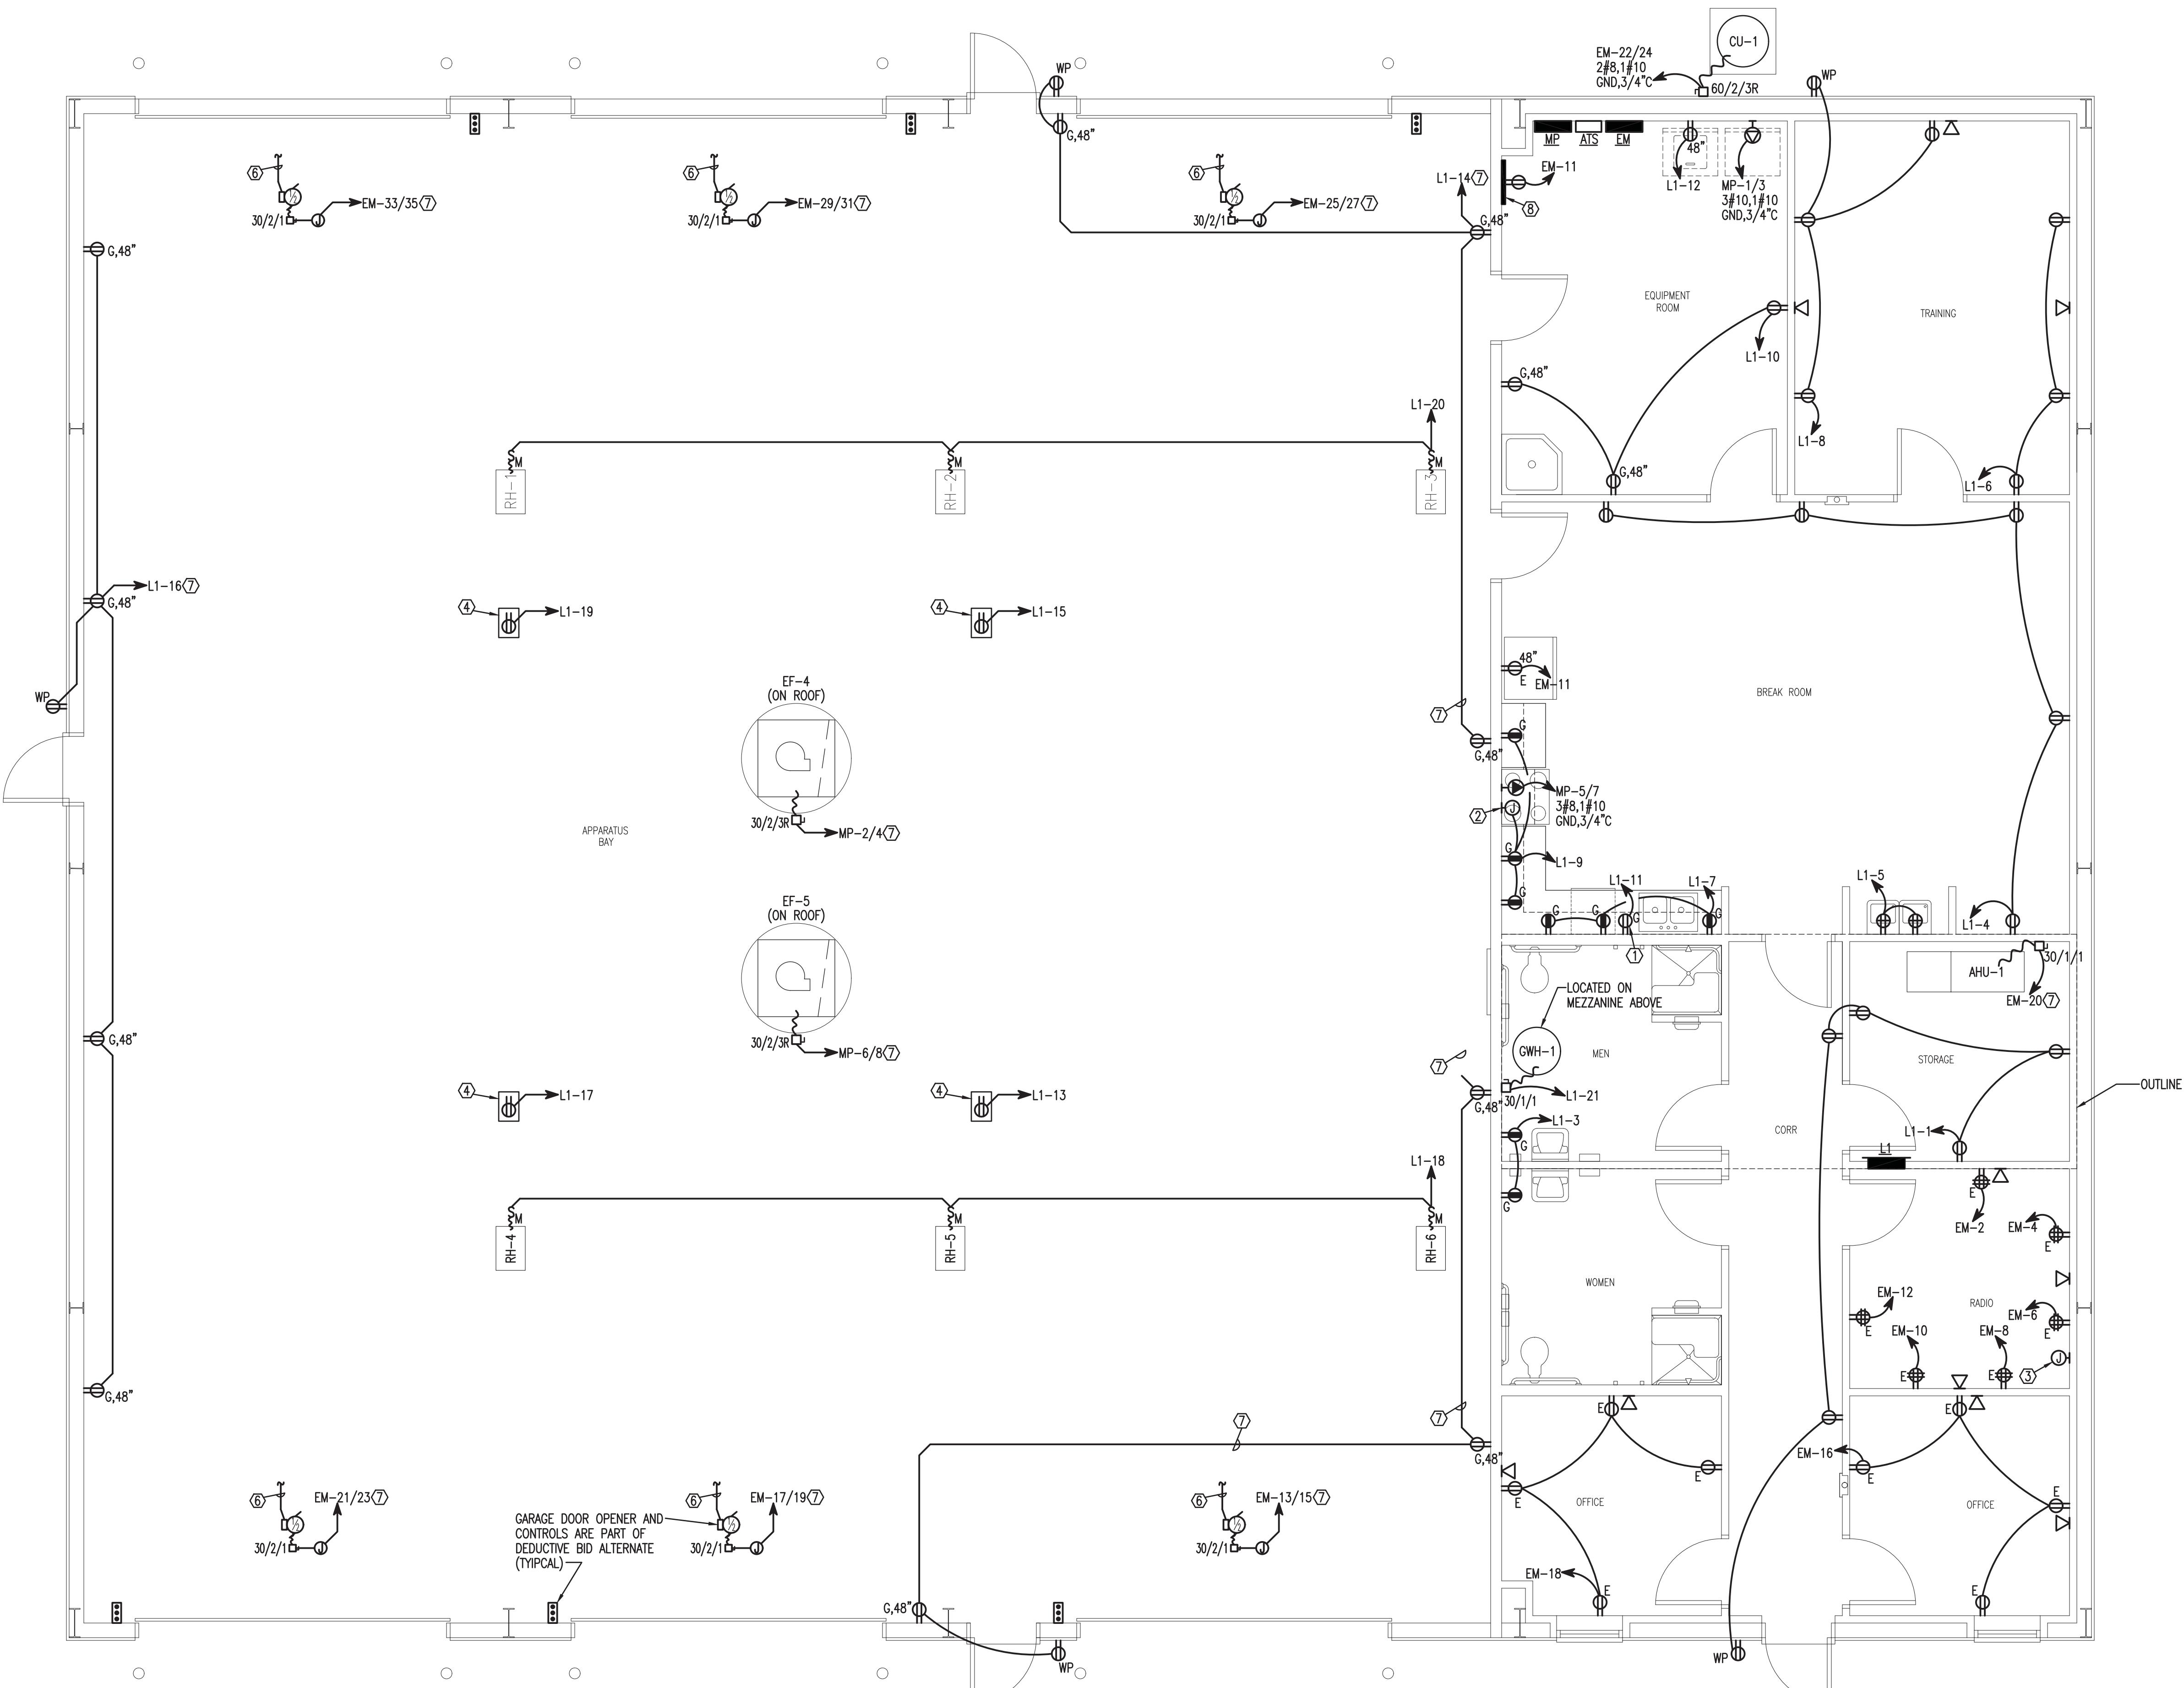E1.1  
SHEET OF

POWER & SIGNAL PLAN

SCALE: 1/4" = 1'-0"

## KEYNOTES:

- ① RECEPTACLE MOUNTED BELOW COUNTER FOR DISHWASHER; COORDINATE LOCATION WITH CASEWORK INSTALLER PRIOR TO ROUGH-IN
- ② JUNCTION BOX FOR HOOD VENT ABOVE RANGE
- ③ INSTALL 3" CONDUIT WITH PULL WIRE UP TO ABOVE MEZZANINE FOR OWNER FURNISHED RADIO EQUIPMENT CONDUCTORS; INSTALL INSULATED BUSHINGS AT EACH END. COORDINATE LOCATION WITH OWNER PRIOR TO ROUGH-IN
- ④ RECEPTACLE FOR OVERHEAD ELECTRIC POWER CORD; VERIFY EXACT LOCATION WITH OWNER PRIOR TO ROUGH-IN
- ⑤ DISCONNECT FOR GARAGE DOOR OPENER; VERIFY EXACT LOCATION OF DOOR OPENER IN FIELD PRIOR TO ROUGH-IN
- ⑥ INSTALL DOOR CONTROLLER CONDUCTORS IN CONDUIT TO DOOR CONTROLLER
- ⑦ 2#10,1#10 GND,3/4°C
- ⑧ TELEPHONE BACKBOARD, 2 FT. WIDE X 4 FT. HIGH X 3/4" EXTERIOR PLYWOOD. PAINT TWO COATS FIRE RETARDANT PAINT. INSTALL ONE NO. 6 COPPER GROUND CONDUCTOR IN 3/4" CONDUIT TO BUILDING GROUND, LEAVE 4 FT. SLACK CONDUCTOR AT BACKBOARD.



A NEW FIRE STATION  
FOR THE  
CITY OF ASHFORD  
ASHFORD, ALABAMA

OWNER:


CITY OF ASHFORD  
525 N BROADWAY STREET  
ASHFORD, ALABAMA 36312

ISSUE: APRIL 20, 2022  
MARK DATE DESCRIPTION

PROJECT NO: 21-20  
DRAWN BY: Quinn Yates  
CHECKED BY: Quinn Yates

SHEET TITLE

## LIGHTING PLAN

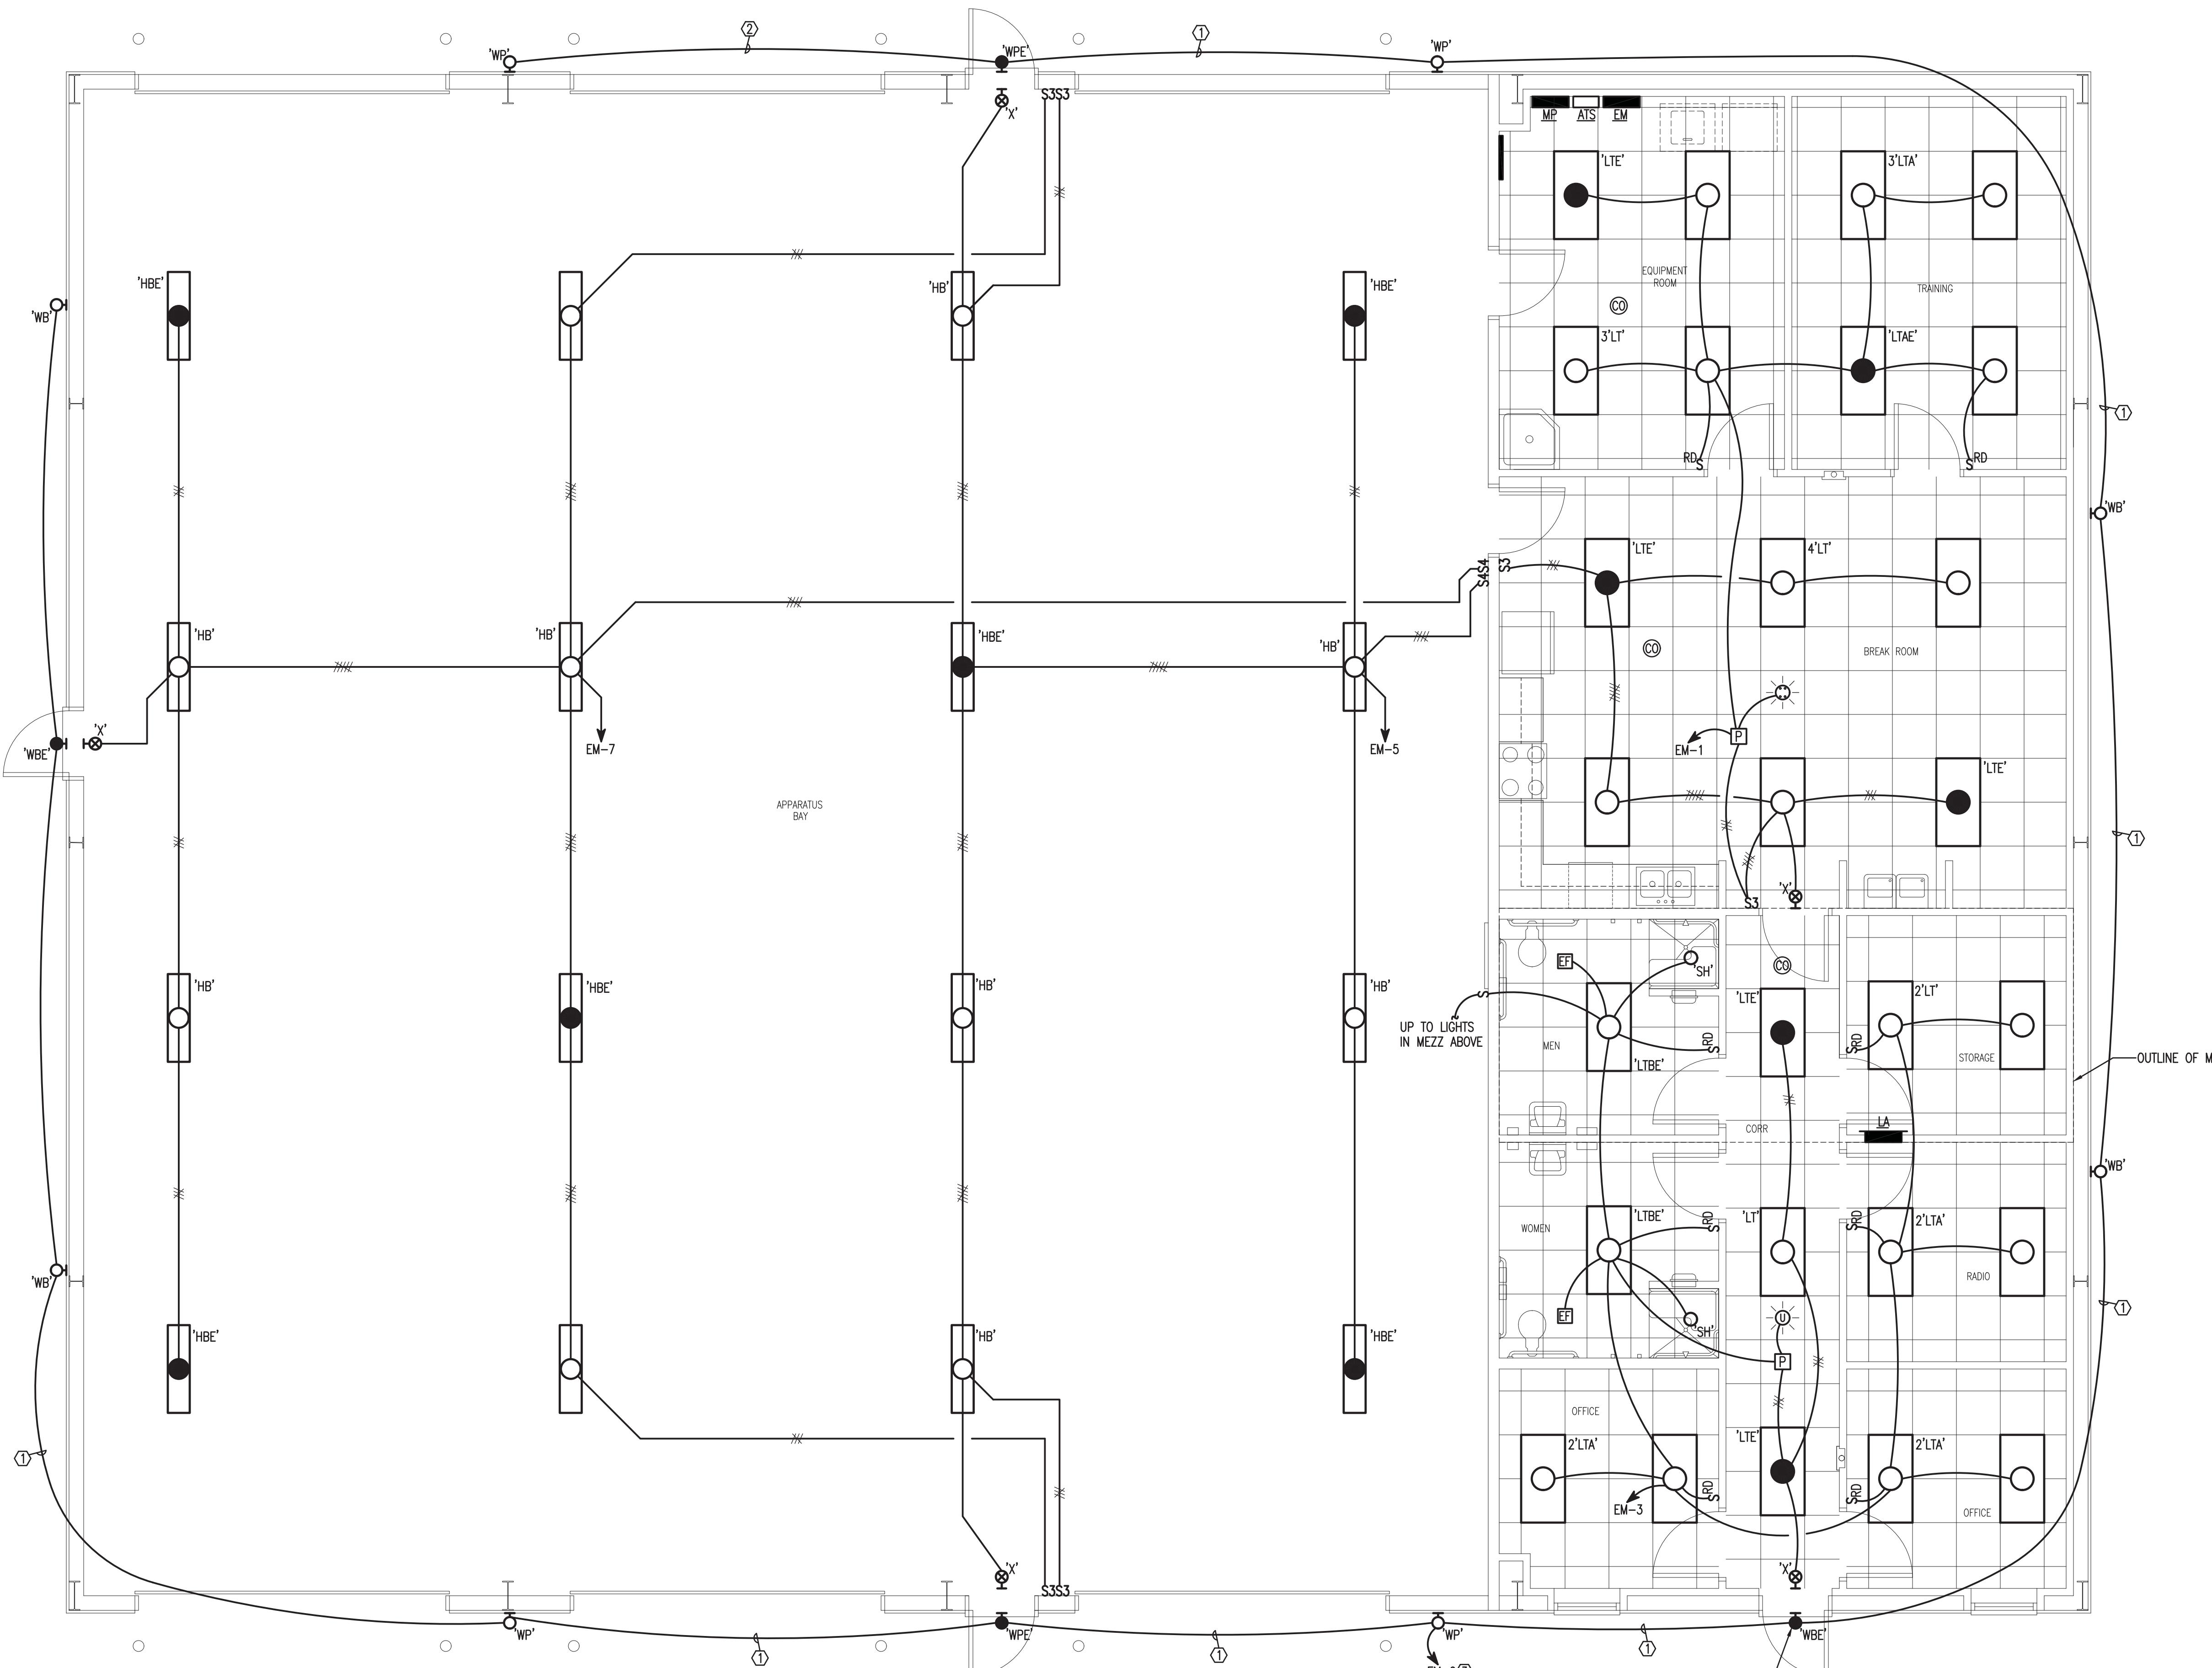


LIGHTING PLAN  
SCALE: 1/4"=1'-0"

## ALTERNATE DEDUCTION NOTES:

1. IF EMERGENCY GENERATOR IS DEDUCTED FROM THE PROJECT; PROVIDE EMERGENCY UNIT BATTERY PACKS IN 'E' FIXTURES.
2. IF EMERGENCY GENERATOR IS PROVIDED AS PART OF THIS PROJECT; DO NOT PROVIDE EMERGENCY UNIT BATTERY PACKS IN 'E' FIXTURES.

## KEYNOTES:

① 3#10, #10 GND, 3/4" C  
② 2#10, #10 GND, 3/4" C  
③ ROUTE CIRCUIT THROUGH LIGHTING CONTACTOR FOR CONTROLS; SEE EXTERIOR LIGHTING CONTROL DIAGRAM

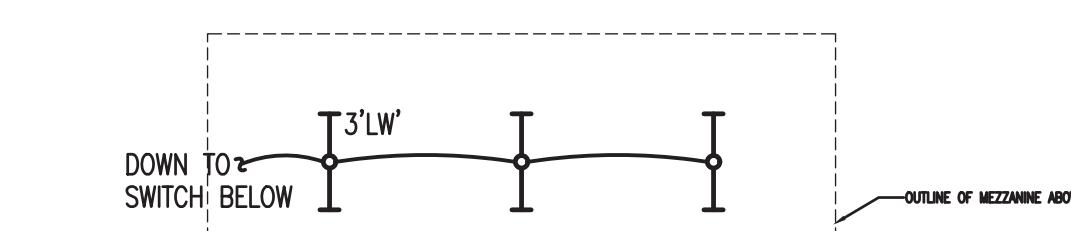

MEZZANINE LIGHTING PLAN  
SCALE: 1/4"=1'-0"

